
## 435 & STATE LINE REDEVELOPMENT

Preliminary Development Plan Resubmission // 7.1.2021

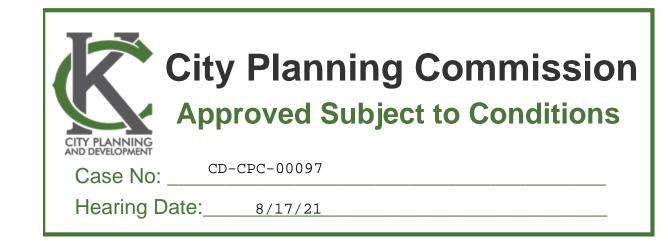

#### SHEET INDEX

CIVIL	
CO	OVERALL SITE PLAN
CO.1	PRELIMINARY PLAT
C0.2	OVERALL SITE PLAN - AERIAL
C1	DEMOLITION PLAN - PHASE 1
C1.1	SITE PLAN - PHASE 1
C1.2	GRADING PLAN - PHASE 1
C1.3	UTILITY PLAN - PHASE 1
C2	DEMOLITION PLAN - PHASE 2
C2:1	OVERALL SITE PLAN - PHASE 2
C2.2	ENLARGED SITE PLAN - PHASE 2
C2.3	ENLARGED SITE PLAN - PHASE 2
C2.4	GRADING PLAN - PHASE 2
C2,5	UTILITY PLAN - PHASE 2
C3	STORM SEWER PLAN & PROFILE
C3.1	STORM SEWER SECTIONS

## LANDSCAPE

SITE PLAN OFFICE LANDSCAPE PLAN BANK LANDSCAPE PLAN

#### ARCHITECTURAL

OFFICE ELEVATIONS GARAGE ELEVATIONS UMB BANK ELEVATIONS

#### ELECTRICAL















Project 435 & STATE LINE 1310 Carondelet Dr, Kansas City, MO 64114

Prepared for VanTrust Real Estate 4900 Main St. Ste 400, Kansas City, MO 64112

UMB Financial Corportation 1010 Grand Boulevard, Kansas City, MO 64106



Hellmuth, Obata & Kassabaum, Inc. 300 West 22nd Street Kansas City, MO 64108 USA t +1 816 472 3360 f+1 816 472 2100

## GastingerWalker &

817 Wyandotte St, Kansas City, MO 64105 t +1 816 421 8200 f +1 816 421 1262

Phelps Engineering Inc

1270 N Winchester St #5878, Olathe, KS 66061 Oppermann LandDesign LLC

Retail Bank Landscape Architect 22 Debra Lane, New Windsor, New York 12553

Lankford Fendler Associates Engineering Consultant 1730 Walnet St, Kansas City, MO 64108


## **NOT FOR** CONSTRUCTION

No.	Description	Date
1	PDP SUBMISSION	4.30.2021
2	PDP RE- SUBMISSION	7.1.2021

**COVER SHEET** 

Original is 36 x 24. Do not scale contents of this drawing.

G00

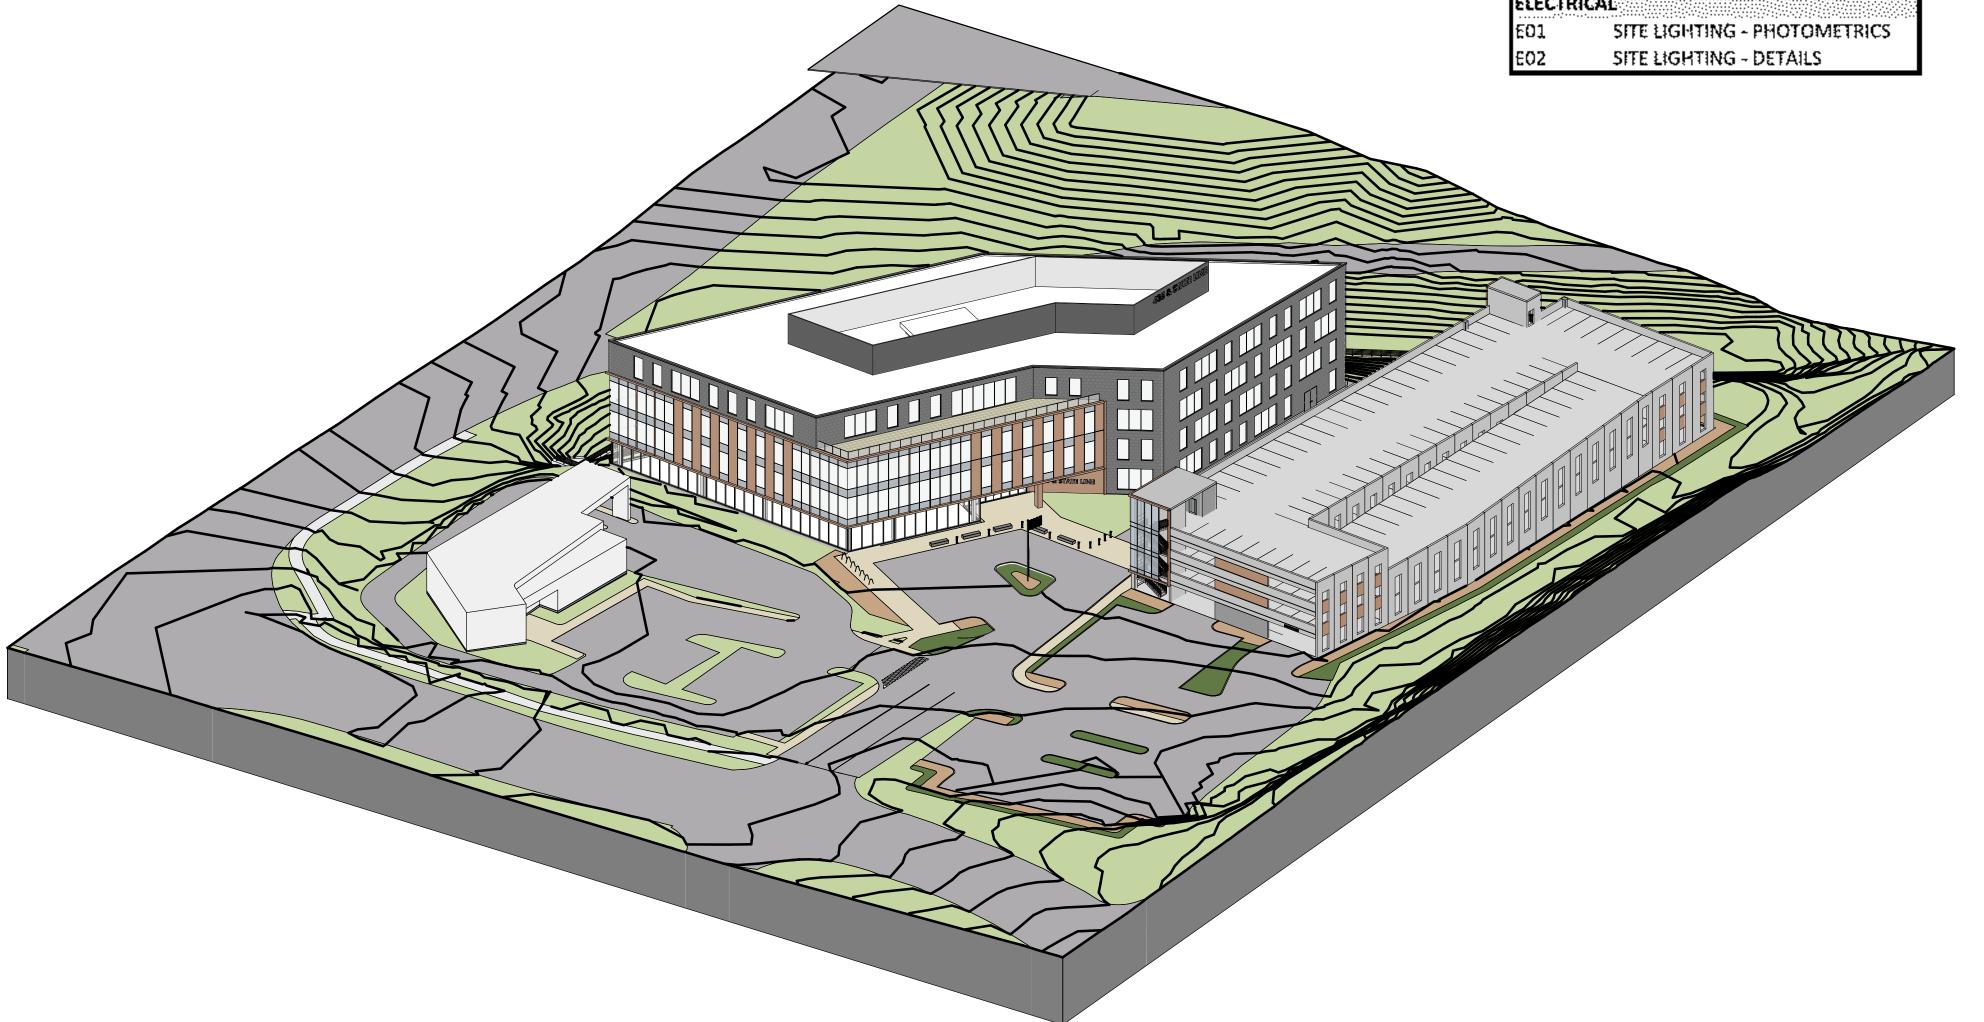

#### LEGAL DESCRIPTION:

LOT THREE (3), CARONDELET THREE, A SUBDIVISION IN KANSAS CITY, JACKSON COUNTY, MISSOURI, EXCEPT THEREFROM THAT PART DEEDED TO THE CITY OF KANSAS CITY, A MUNICIPAL CORPORATION, DESCRIBED AS FOLLOWS: BEGINNING AT THE SOUTHWEST CORNER OF SAID LOT THREE; THENCE NORTH O DEGREES, 14 MINUTES 00 SECONDS WEST, ALONG THE WEST LINE OF SAID LOT THREE, A DISTANCE OF 35.78 FEET; THENCE SOUTH 58 DEGREES 08 MINUTES 01 SECONDS EAST, A DISTANCE OF 67.34 FEET, TO A POINT ON THE SOUTH LINE OF SAID LOT THREE; THENCE SOUTH 89 DEGREES 46 MINUTES 00 SECONDS WEST, ALONG THE SOUTH LINE OF SAID LOT THREE, A DISTANCE OF 57.05 FEET TO THE POINT OF BEGINNING.

 $AREA = 4.3230 ACRES / \pm 188,310 SQ.FT.$ 

**SCHEDULE:** 

UNITED MISSOURI BANK OF KANSAS CITY C/O CORPORATE TAX DEPARTMENT 1010 GRAND BLVD 4TH FLOOR KANSAS CITY, MISSOURI

**OWNER:** 

Commencement of Construction Date: 10-01-21 Completion of Construction Date: 02-01-24

#### **BUILDING & LOT DATA**

DUILDING & LOI DAIA		
Site Area	188,310 S.F./4.32 Ac.	
Zoning		
Existing	B2-2, R-0.5	
Proposed	B2-4	
Phase 1		
Lot 1 Area	0.94 Ac.	
UMB Bank		
Building S.F.	4,500 S.F.	
# of Stories	1 Story	
Building Height	25'-0" (Building)	
3 3	40'-0" (Tower/Clerestory)	
Floor Area Ratio (FAR)	0.1099	
Building Coverage	4,500 SF (0.1099)	
Phase 2		
Lot 2 Area	3.38 Ac.	
Office Building		
Building S.F.	105,289 S.F.	
# of Stories	4 Stories	
# of Stories Building Height	58'-0"	
Floor Area Ratio (FAR)	0.7151	
Building Coverage	26,800 SF (0.1820)	
Parking Garage		
Building S.F.	108,000 S.F.	
# of Stories	4 Stories	
Building Height	43'-6"	
Floor Area Ratio (FAR)	0.7335	
Building Coverage	27,000 SF (0.1834)	
Lot 2 Total		
Building S.F.	213,289 S.F.	
Floor Ârea Ratio (FAR)	1.4487	
Building Coverage	53,800 SF (0.3654)	
Overall		
Lot 1 and Lot 2 Area	4.32 Ac.	
Total Building S.F.	217,789 S.F.	
Total Floor Area Ratio (FAR)	1.1573	
Total Building Coverage	58,300 SF (0.1663)	
rotal ballaring coverage	1 30,300 31 (0.1003)	

#### PARKING SUMMARY

Phase 1 — Lot 1		
Parking Required:		
Financial Services (all other) 2.5 Spaces for Every 1,000 S.F.	11	S
Parking Provided		_
Exterior Parking Spaces	22	S
Required Accessible Parking Spaces (1–25)	1	S
Phase 2 - Lot 2		
Parking Required:		
Office (general) 1 Space For Every 1,000 S.F.	105	<u>S</u>
Parking Provided	+	
Parking Garage Parking Spaces	300	S
Exterior Parking Spaces	58	$\overline{s}$
Total Parking Provided	358	S
Required Accessible Parking Spaces (301-400)	8	_

**LEGEND** 

<u> 22 421 12</u>	
——PL—— ——LL—— ——R/W——	PROPERTY LINE LOT LINE RIGHT-OF-WAY
	2' CURB & GUTTER
	ASPHALT PAVEMENT
	PERVIOUS PAVEMENT

PERVIOUS PAVEMENT PROPOSED BUILDING CONCRETE PAVEMENT CONCRETE SIDEWALK

UTILITY NOTES:
VISUAL INDICATIONS OF UTILITIES ARE AS SHOWN.
UNDERGROUND LOCATIONS SHOWN, AS FURNISHED BY THEIR
LESSORS, ARE APPROXIMATE AND SHOULD BE VERIFIED IN
THE FIELD AT THE TIME OF CONSTRUCTION. FOR ACTUAL
FIELD LOCATIONS OF UNDERGROUND UTILITIES CALL 811.



PEI #210040

99TH STREET

N1/2

103RD STREET

CARONDELET DRIVE

VICINITY MAP FRAC. SEC. 31-48-33



435 & STATE LINE 1310 Carondelet Dr, Kansas City, MO 64114

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**UMB** Financial Corportation 1010 Grand Boulevard, Kansas City, MO 64106



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## GastingerWalker&

UMB Retail Bank Architect 817 Wyandotte St, Kansas City, MO 64105 t +1 816 421 8200 f +1 816 421 1262

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Oppermann LandDesign LLC Retail Bank Landscape Architect 22 Debra Lane, New Windsor, New York 12553

Lankford Fendler Associates **Engineering Consultant** 

1730 Walnet St, Kansas City, MO 64108

Professional Seals

## PDP SUBMITTAL **NOT FOR** CONSTRUCTION

No.	Description	Date
1	PDP SUBMISSION	4.30.2021
	PDP RE-SUBMISSION	7.1.2021
3	PDP RE-SUBMISSION	7.29.2021
Project No:	20.70060.00	

**OVERALL SITE PLAN** 

Original is 36 x 24. Do not scale contents of this drawing. Sheet Number

C<sub>0</sub>


## CARONDELET THREE REPLAT

A REPLAT OF LOT 3, CARONDELETE THREE, A PLATTED SUBDIVISION IN THE SOUTH HALF OF FRACTIONAL SECTION 31,

STORM DRAINAGE ESMT.

TO KANSAS CITY

BEND=835.41

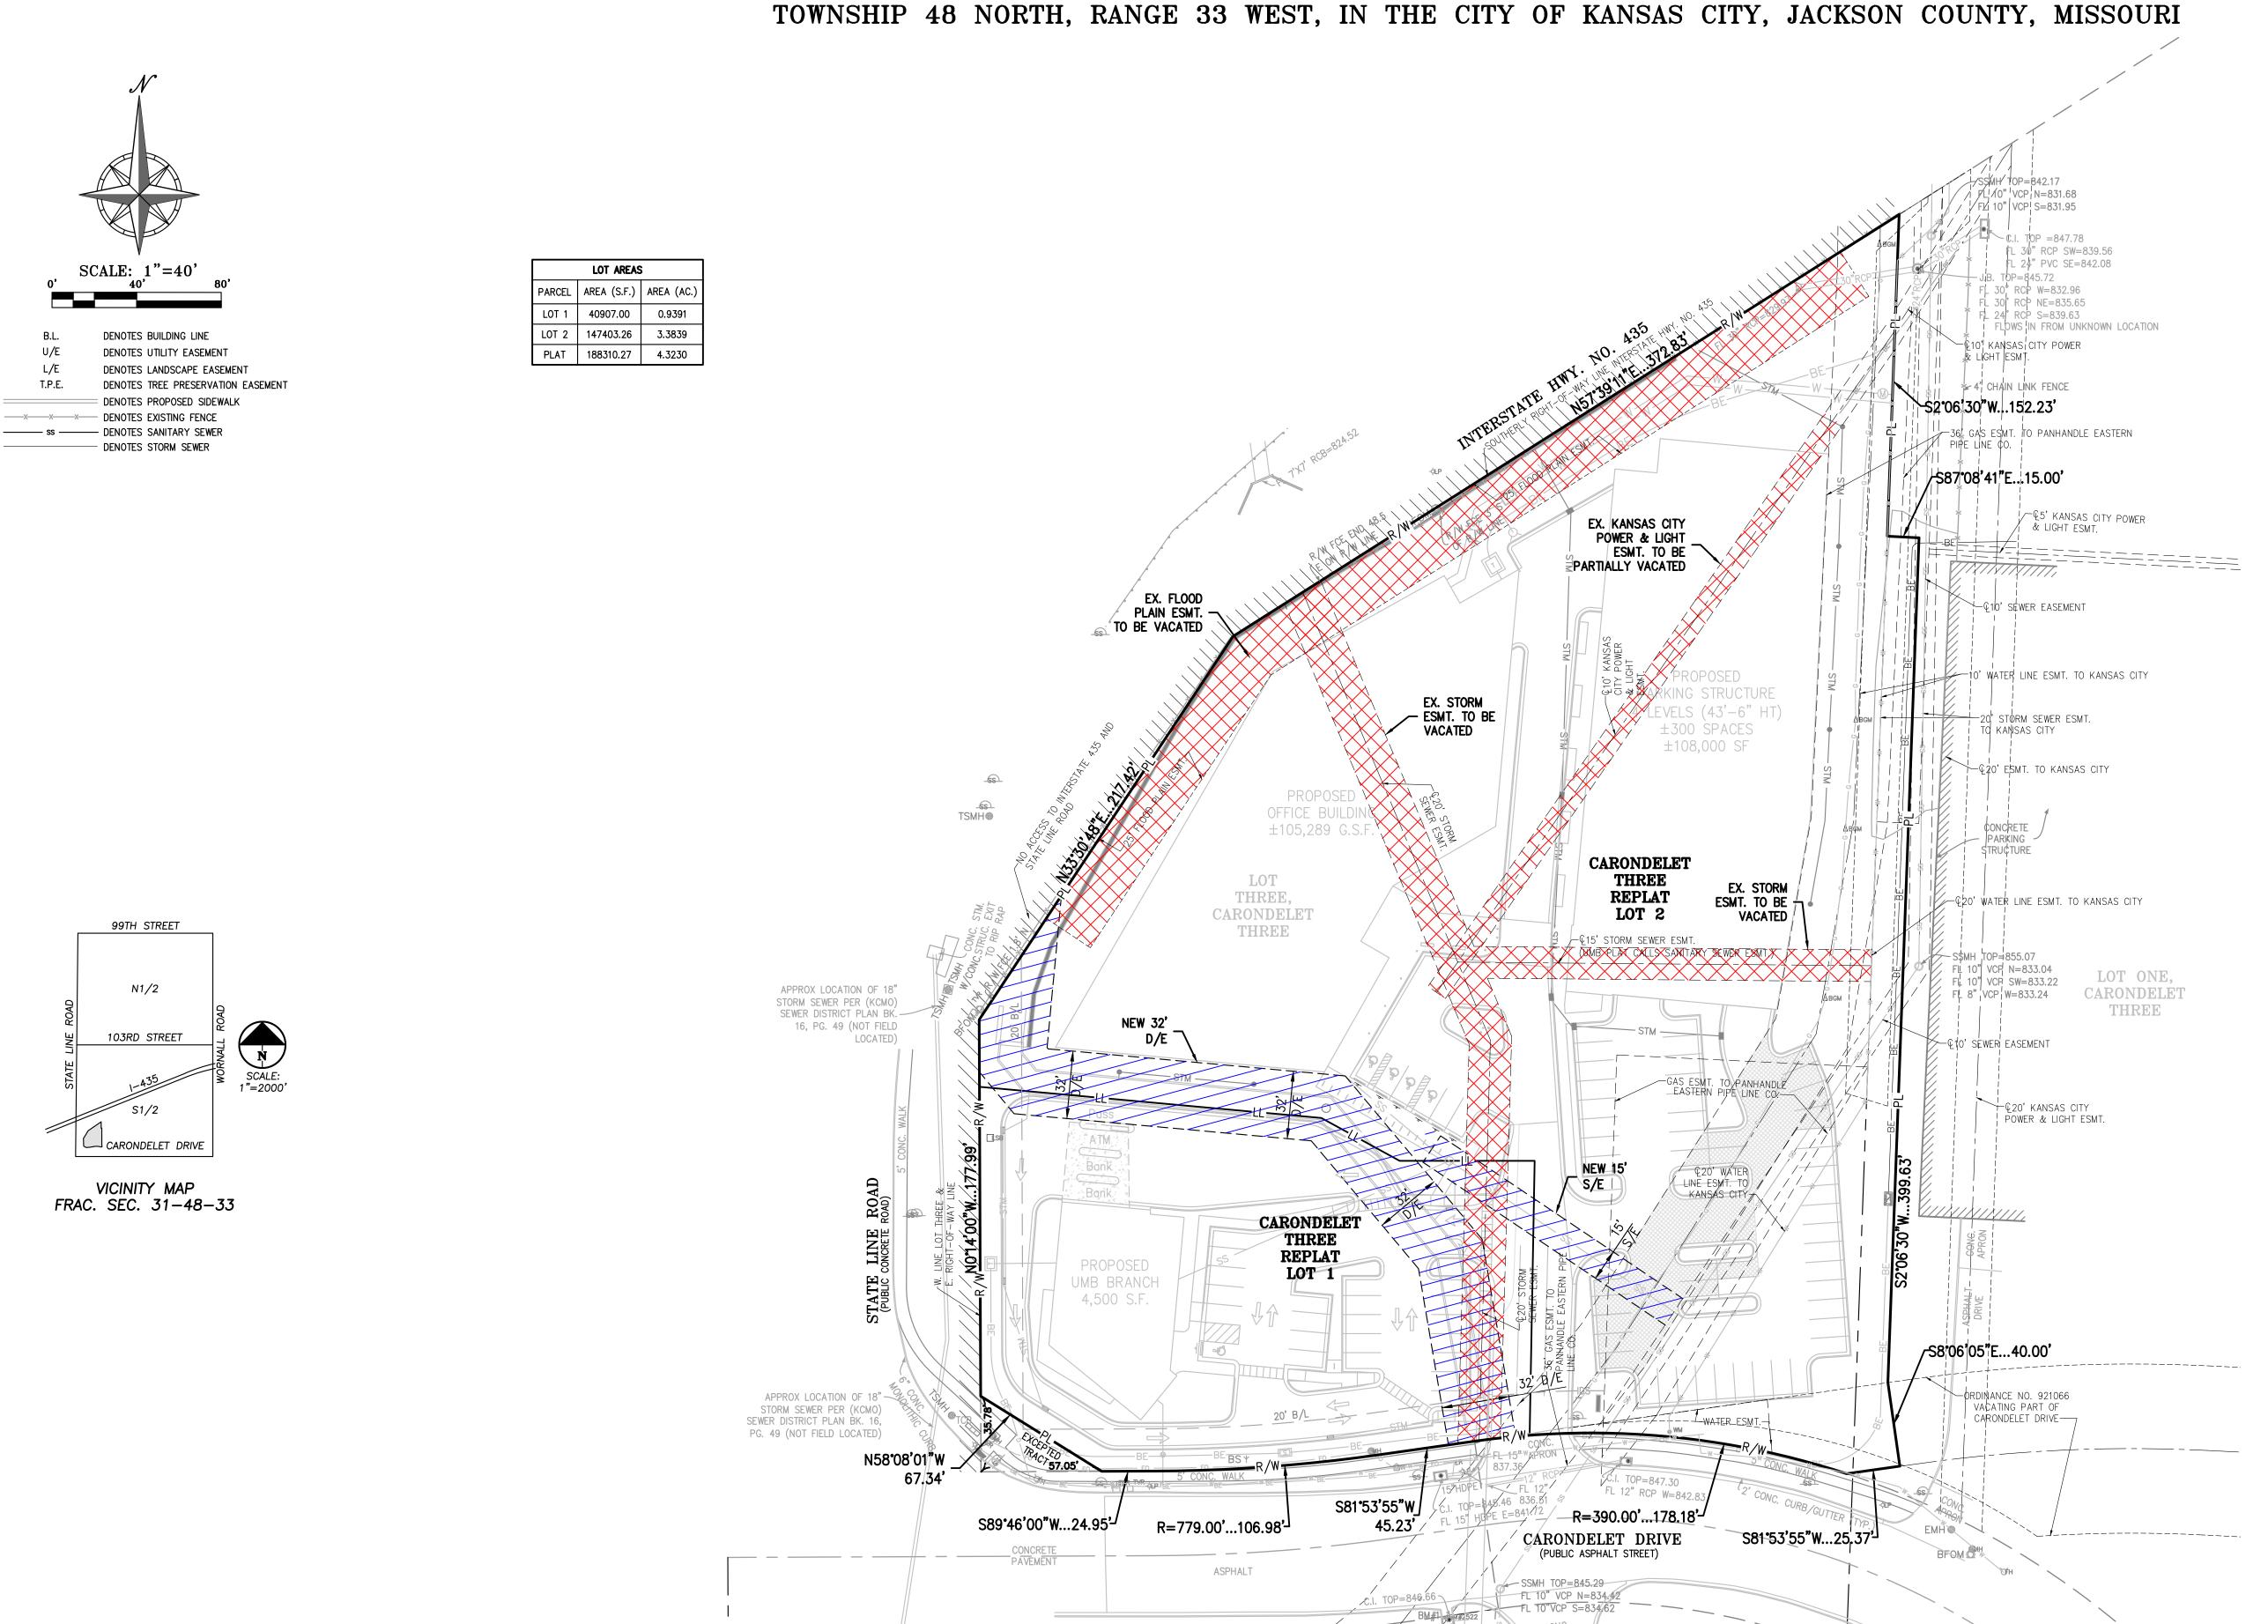

PEI #210040 - 04/20/2021

#### LEGAL DESCRIPTION:

LOT THREE (3), CARONDELET THREE, A SUBDIVISION IN KANSAS CITY, JACKSON COUNTY, MISSOURI, EXCEPT THEREFROM THAT PART DEEDED TO THE CITY OF KANSAS CITY, A MUNICIPAL CORPORATION, DESCRIBED AS FOLLOWS: BEGINNING AT THE SOUTHWEST CORNER OF SAID LOT THREE; THENCE NORTH O DEGREES, 14 MINUTES 00 SECONDS WEST, ALONG THE WEST LINE OF SAID LOT THREE, A DISTANCE OF 35.78 FEET; THENCE SOUTH 58 DEGREES 08 MINUTES 01 SECONDS EAST, A DISTANCE OF 67.34 FEET, TO A POINT ON THE SOUTH LINE OF SAID LOT THREE; THENCE SOUTH 89 DEGREES 46 MINUTES 00 SECONDS WEST, ALONG THE SOUTH LINE OF SAID LOT THREE, A DISTANCE OF 57.05 FEET TO THE POINT OF BEGINNING.

 $AREA = 4.3230 ACRES / \pm 188,310 SQ.FT.$ 

#### FLOOD NO

THIS PROPERTY LIES WITHIN ZONE X, DEFINED AS AREAS DETERMINED TO BE OUTSIDE THE 0.2% ANNUAL CHANCE FLOODPLAIN, AS SHOWN ON THE FLOOD INSURANCE RATE MAP PREPARED BY THE FEDERAL EMERGENCY MANAGEMENT AGENCY FOR THE CITY OF KANSAS CITY, COMMUNITY NO. 290173, JACKSON COUNTY, MISSOURI, MAP NO. 29095C0386G, AND DATED JANUARY 20, 2017.

#### PHASING TABLE/TIMELINE:

Commencement of Construction Date: 10-01-21 Completion of Construction Date: 02-01-24

#### OWNER:


UNITED MISSOURI BANK OF KANSAS CITY C/O CORPORATE TAX DEPARTMENT 1010 GRAND BLVD 4TH FLOOR KANSAS CITY, MISSOURI

#### ENGINEER/APPLICANT:

PHELPS ENGINEERING, INC. 1270 N. WINCHESTER OLATHE, KS. 66061 (913) 393-1155 (913) 393-1166 FAX



PHELPS ENGINEERING, INC 1270 N. Winchester Olathe, Kansas 66061 (913) 393-1155 Fax (913) 393-1166

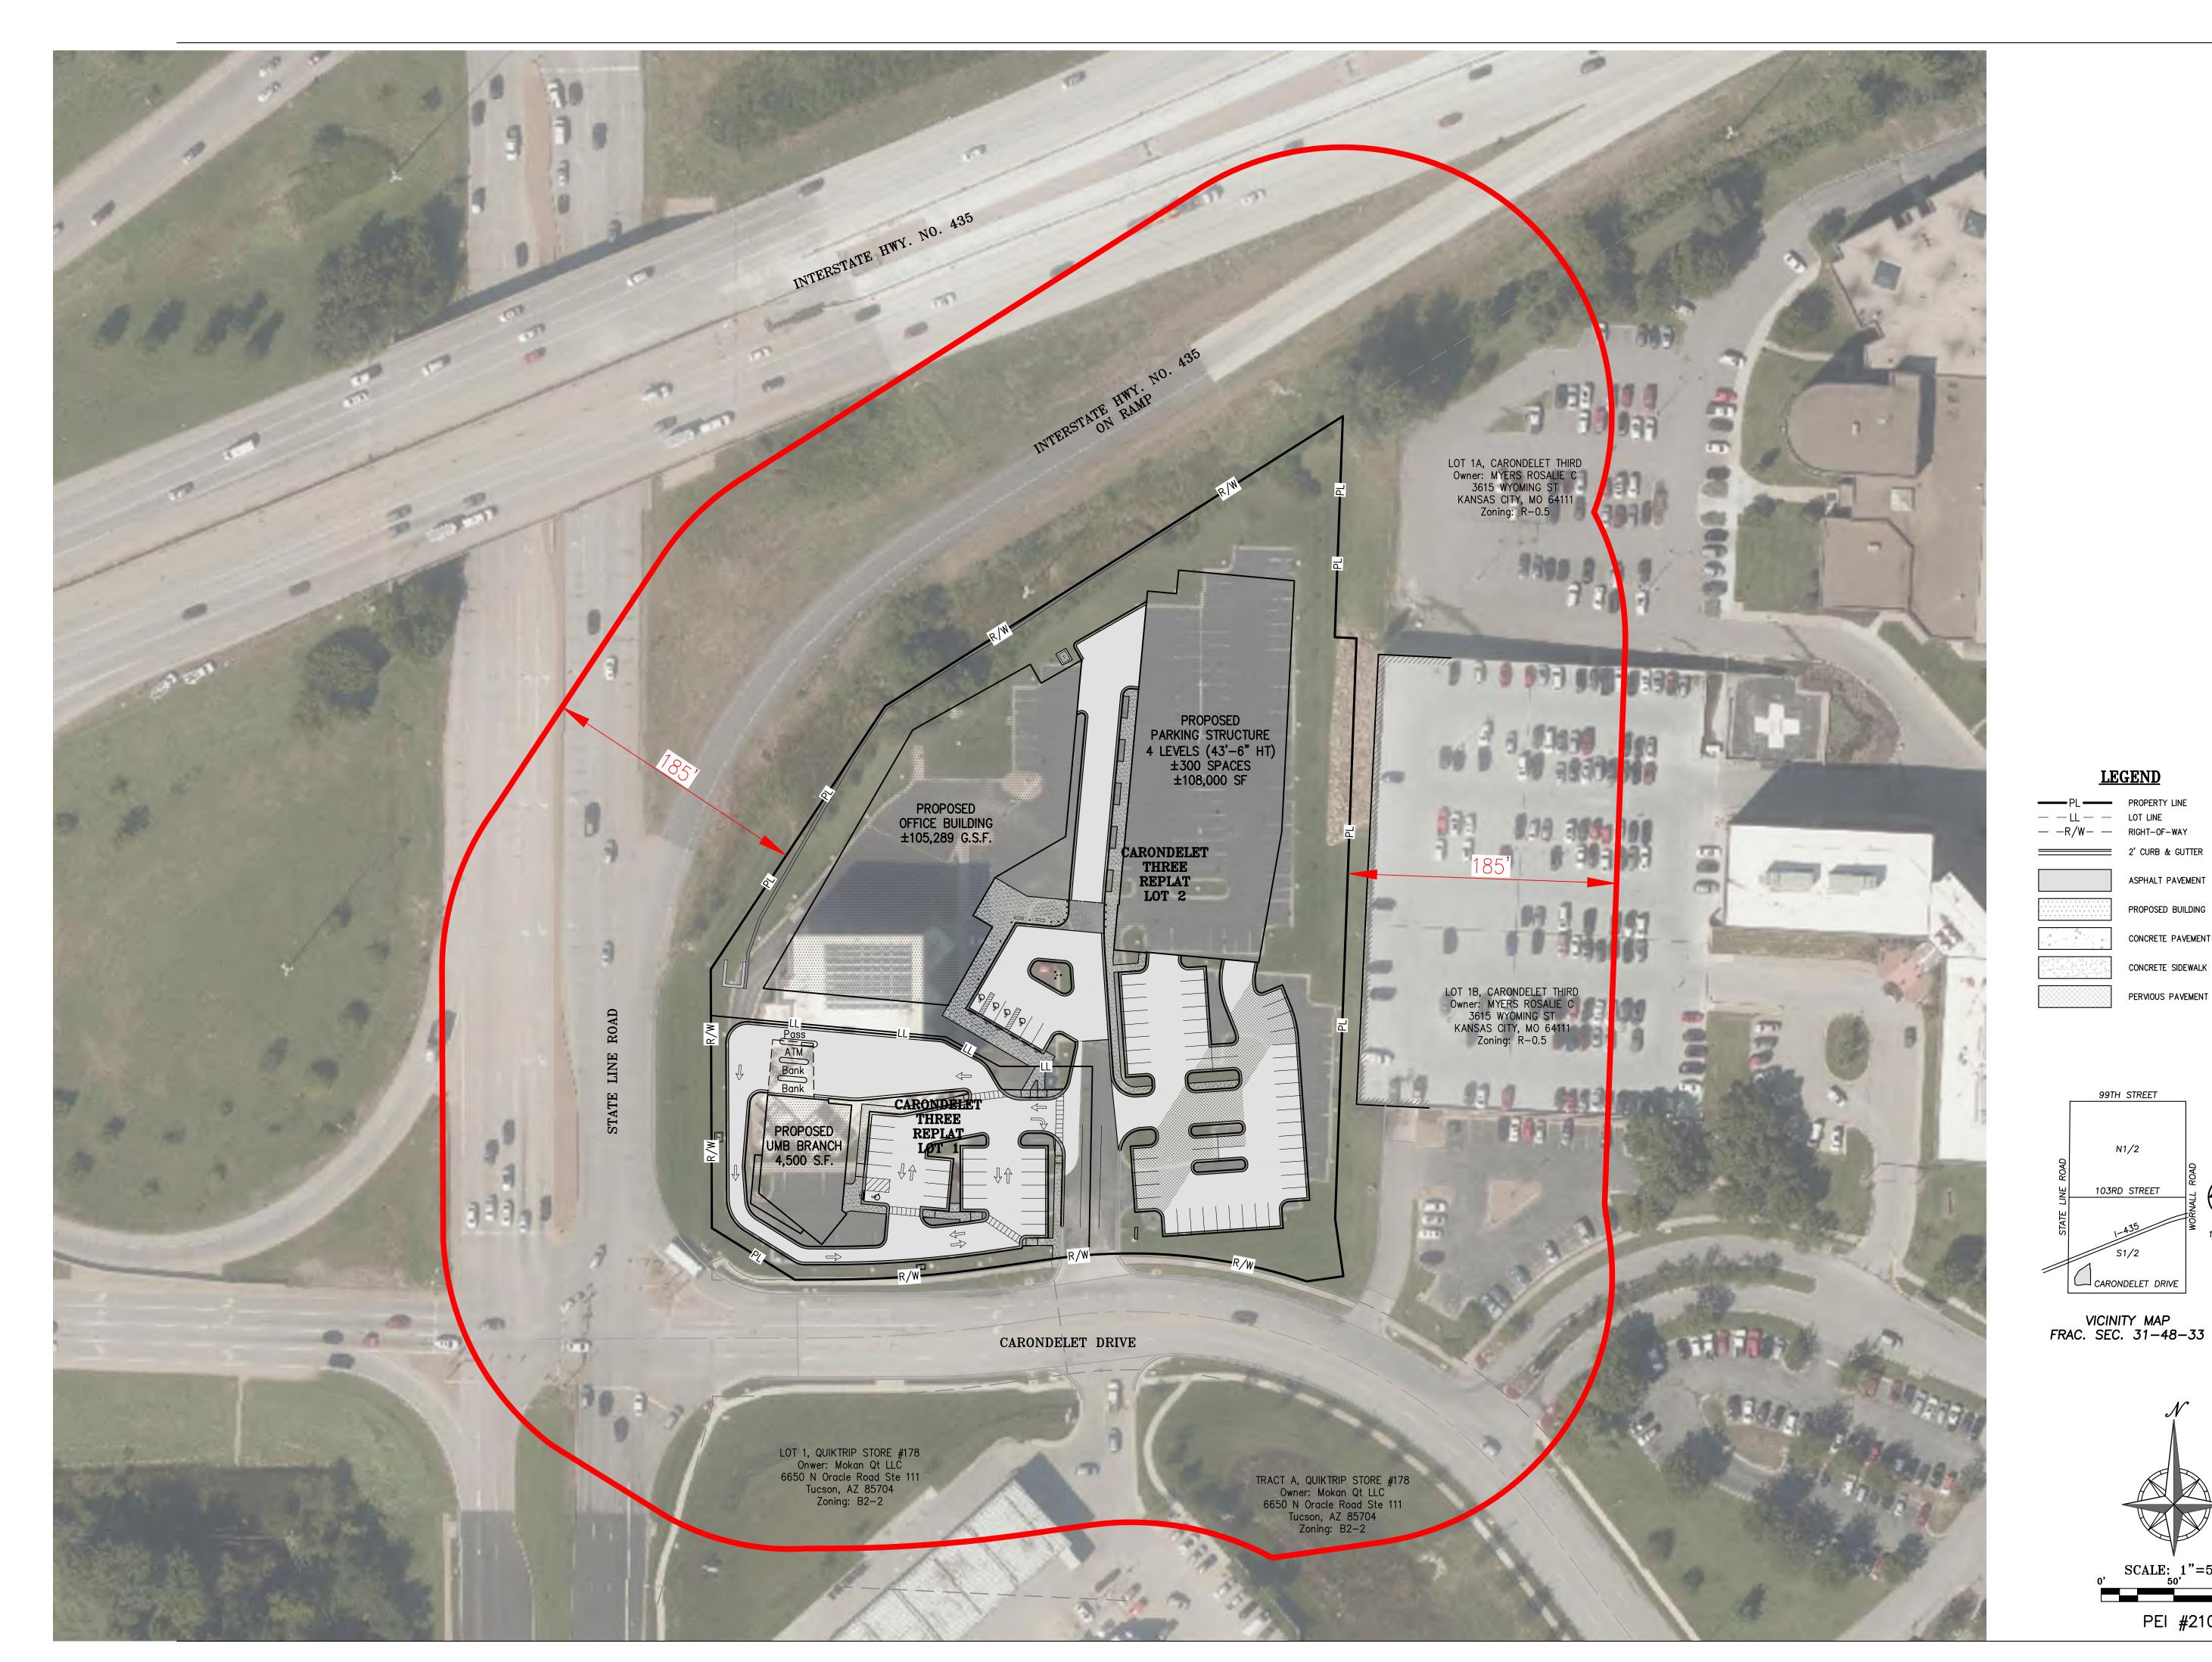





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Civil Engineering
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**LEGEND** 

ASPHALT PAVEMENT

PROPOSED BUILDING

CONCRETE PAVEMENT

CONCRETE SIDEWALK

PERVIOUS PAVEMENT

99TH STREET

N1/2

103RD STREET

CARONDELET DRIVE

PEI #210040


Oppermann LandDesign LLC Retail Bank Landscape Architect

22 Debra Lane, New Windsor, New York 12553

Lankford Fendler Associates
Engineering Consultant
1730 Walnet St, Kansas City, MO 64108

Professional Seals

## PDP SUBMITTAL NOT FOR CONSTRUCTION

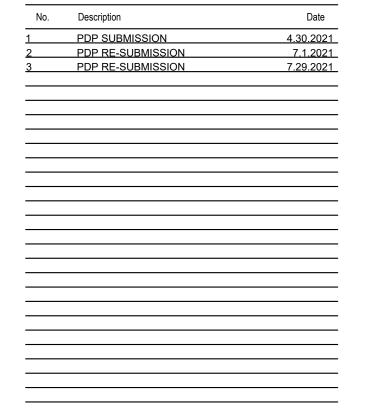


Project No: 20.70060.00

**OVERALL SITE PLAN - AERIAL** 

Original is 36 x 24. Do not scale contents of this drawing. Sheet Number

C0.2

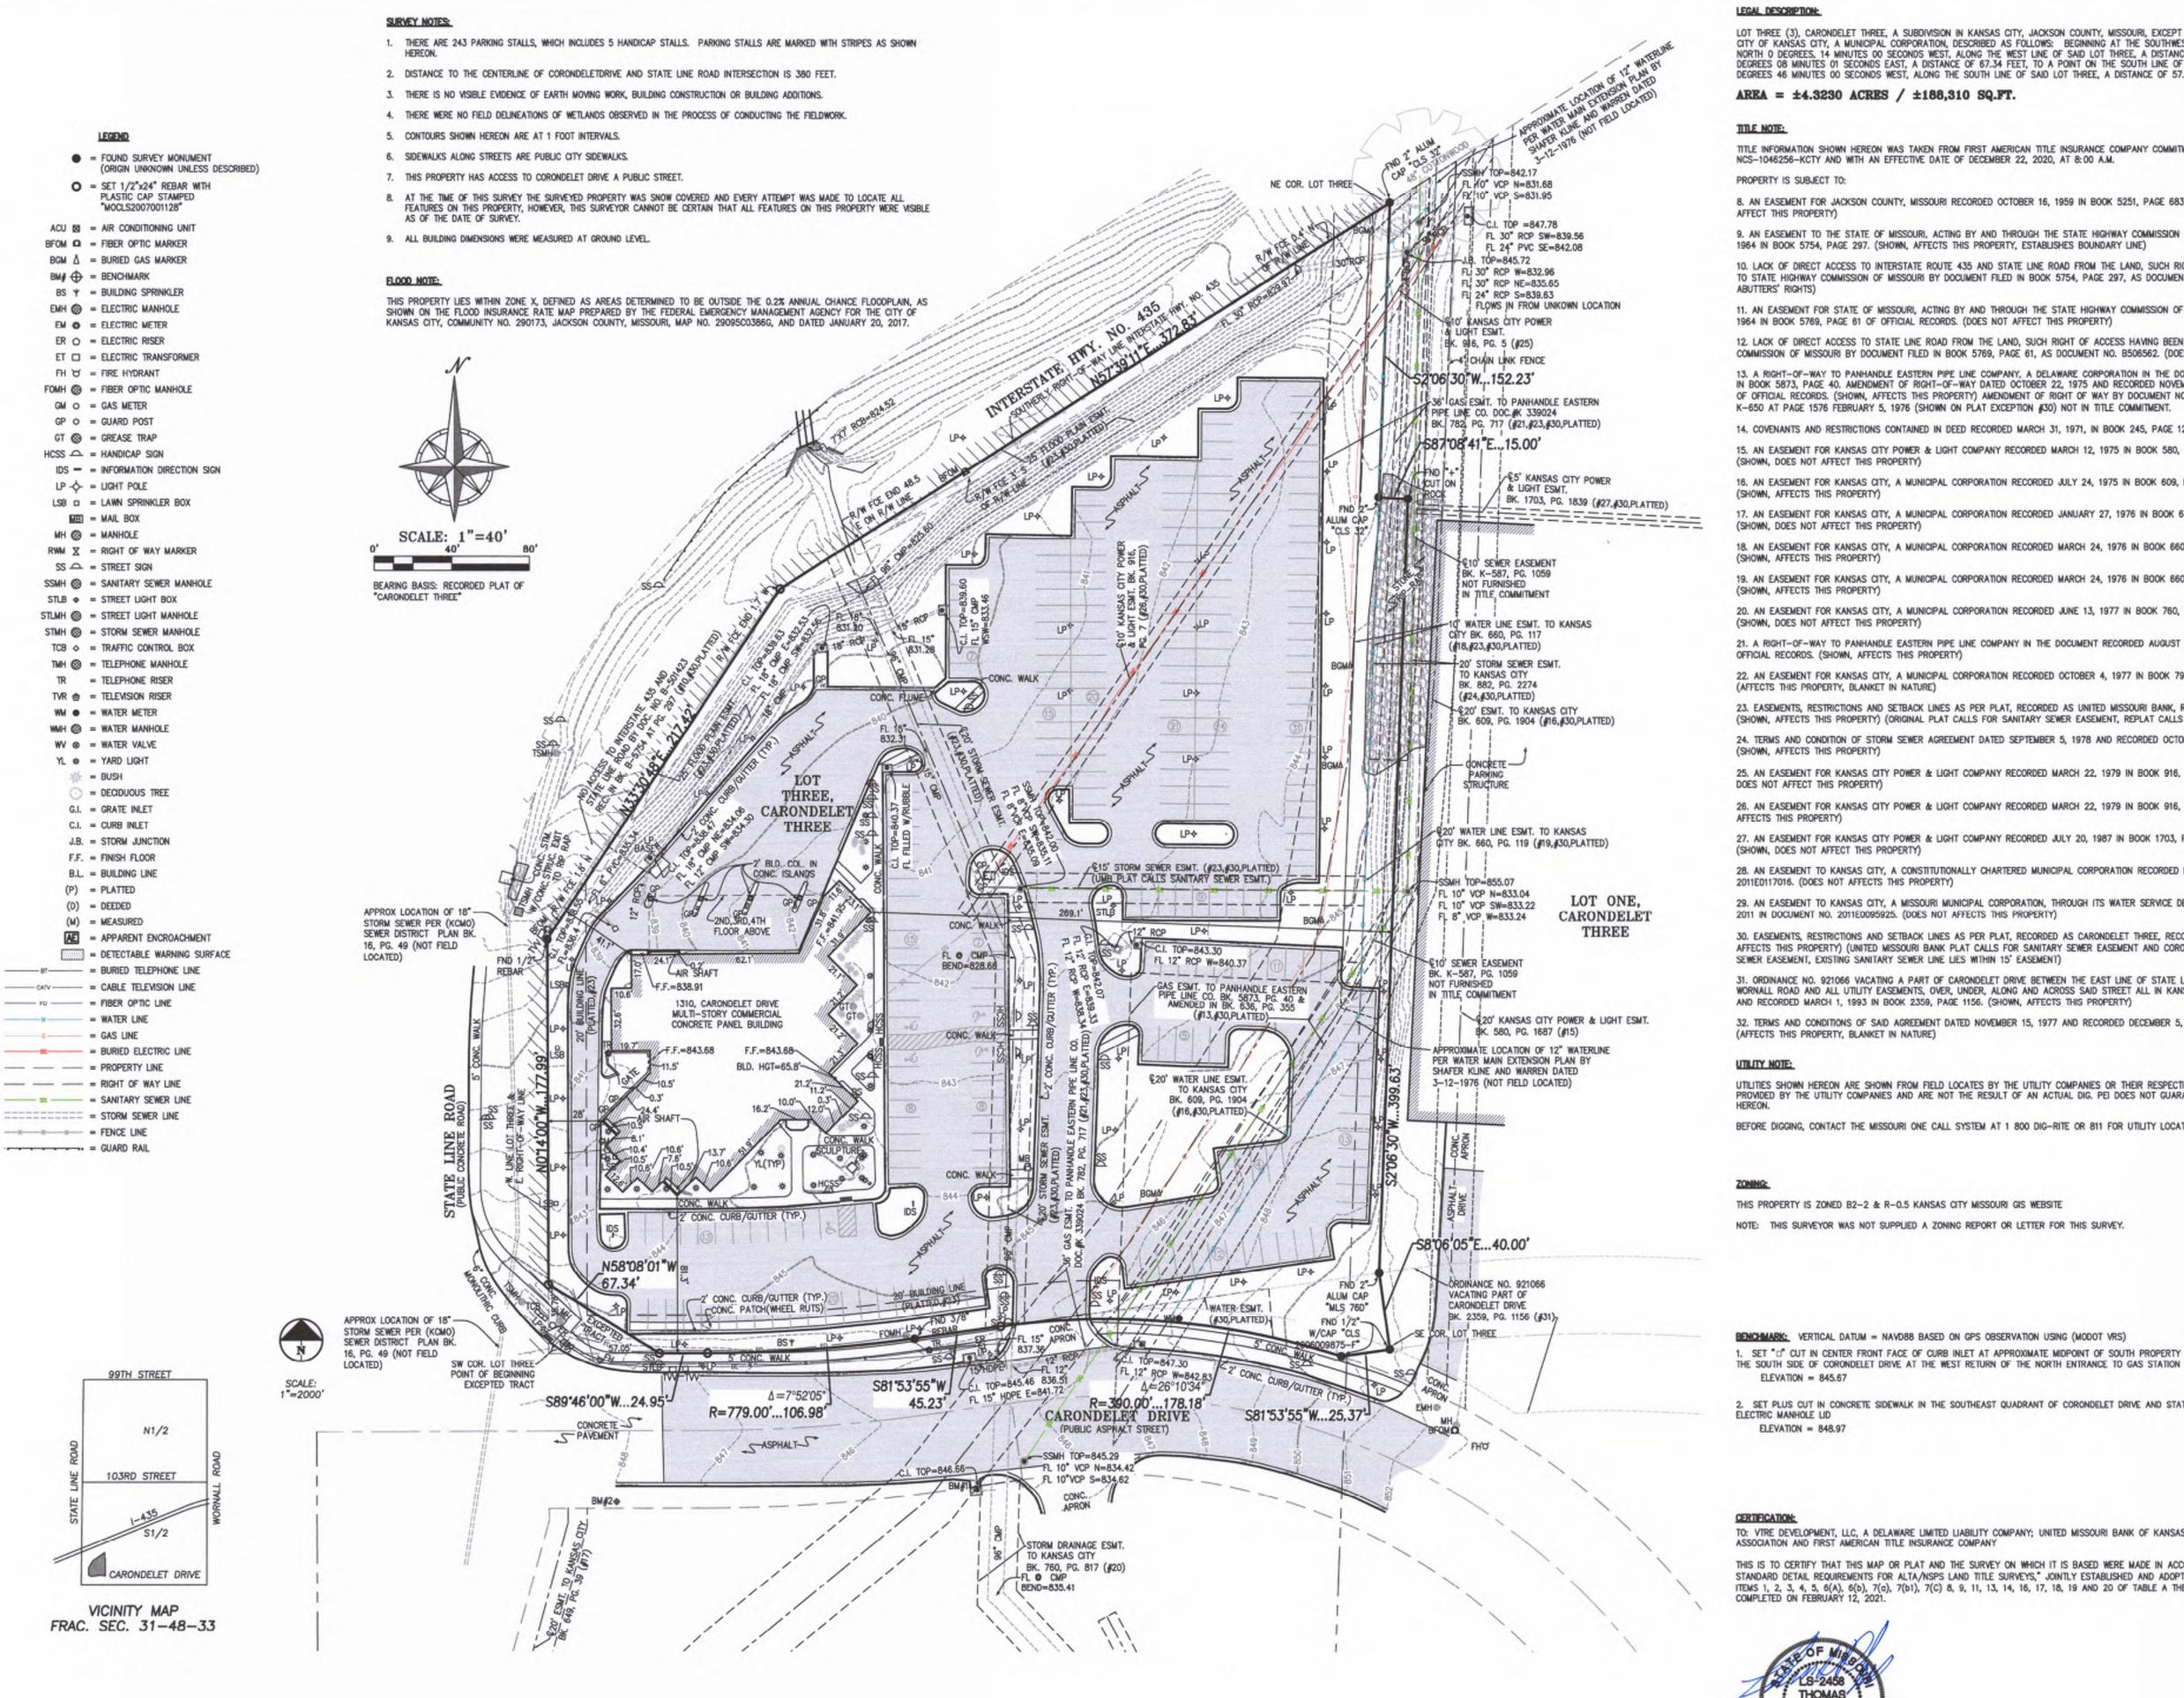

LEGAL DESCRIPTION:

LOT THREE (3), CARONDELET THREE, A SUBDIVISION IN KANSAS CITY, JACKSON COUNTY, MISSOURI, EXCEPT THEREFROM THAT PART DEEDED TO THE CITY OF KANSAS CITY, A MUNICIPAL CORPORATION, DESCRIBED AS FOLLOWS: BEGINNING AT THE SOUTHWEST CORNER OF SAID LOT THREE; THENCE NORTH O DEGREES, 14 MINUTES OO SECONDS WEST, ALONG THE WEST LINE OF SAID LOT THREE, A DISTANCE OF 35.78 FEET: THENCE SOUTH 58 DEGREES 08 MINUTES 01 SECONDS EAST, A DISTANCE OF 67.34 FEET, TO A POINT ON THE SOUTH LINE OF SAID LOT THREE; THENCE SOUTH 89 DEGREES 46 MINUTES 00 SECONDS WEST, ALONG THE SOUTH LINE OF SAID LOT THREE, A DISTANCE OF 57.05 FEET TO THE POINT OF BEGINNING.

 $AREA = \pm 4.3230 ACRES / \pm 188,310 SQ.FT.$ 

TITLE INFORMATION SHOWN HEREON WAS TAKEN FROM FIRST AMERICAN TITLE INSURANCE COMPANY COMMITMENT FOR TITLE INSURANCE NO. NCS-1046256-KCTY AND WITH AN EFFECTIVE DATE OF DECEMBER 22, 2020, AT 8:00 A.M.

8. AN EASEMENT FOR JACKSON COUNTY, MISSOURI RECORDED OCTOBER 16, 1959 IN BOOK 5251, PAGE 683 OF OFFICIAL RECORDS. (DOES NOT

9. AN EASEMENT TO THE STATE OF MISSOURI, ACTING BY AND THROUGH THE STATE HIGHWAY COMMISSION OF MISSOURI RECORDED NOVEMBER 30,

10. LACK OF DIRECT ACCESS TO INTERSTATE ROUTE 435 AND STATE LINE ROAD FROM THE LAND, SUCH RIGHT OF ACCESS HAVING BEEN GRANTED TO STATE HIGHWAY COMMISSION OF MISSOURI BY DOCUMENT FILED IN BOOK 5754, PAGE 297, AS DOCUMENT NO. B501423. (SHOWN, LACK OF

11. AN EASEMENT FOR STATE OF MISSOURI, ACTING BY AND THROUGH THE STATE HIGHWAY COMMISSION OF MISSOURI RECORDED NOVEMBER 2, 1964 IN BOOK 5769, PAGE 61 OF OFFICIAL RECORDS. (DOES NOT AFFECT THIS PROPERTY)

12. LACK OF DIRECT ACCESS TO STATE LINE ROAD FROM THE LAND, SUCH RIGHT OF ACCESS HAVING BEEN GRANTED TO STATE HIGHWAY COMMISSION OF MISSOURI BY DOCUMENT FILED IN BOOK 5769, PAGE 61, AS DOCUMENT NO. B506562. (DOES NOT AFFECT THIS PROPERTY)

13. A RIGHT-OF-WAY TO PANHANDLE EASTERN PIPE LINE COMPANY, A DELAWARE CORPORATION IN THE DOCUMENT RECORDED FEBRUARY 24, 1966 IN BOOK 5873, PAGE 40. AMENDMENT OF RIGHT-OF-WAY DATED OCTOBER 22, 1975 AND RECORDED NOVEMBER 19, 1975 IN BOOK 636, PAGE 355. OF OFFICIAL RECORDS, (SHOWN, AFFECTS THIS PROPERTY) AMENDMENT OF RIGHT OF WAY BY DOCUMENT NO. K-283766 AND RECORDED IN BOOK K-650 AT PAGE 1576 FEBRUARY 5, 1976 (SHOWN ON PLAT EXCEPTION #30) NOT IN TITLE COMMITMENT.

14. COVENANTS AND RESTRICTIONS CONTAINED IN DEED RECORDED MARCH 31, 1971, IN BOOK 245, PAGE 1248. (DOES NOT AFFECT THIS PROPERTY) 15. AN EASEMENT FOR KANSAS CITY POWER & LIGHT COMPANY RECORDED MARCH 12, 1975 IN BOOK 580, PAGE 1687 OF OFFICIAL RECORDS. (SHOWN, DOES NOT AFFECT THIS PROPERTY)

16. AN EASEMENT FOR KANSAS CITY, A MUNICIPAL CORPORATION RECORDED JULY 24, 1975 IN BOOK 609, PAGE 1904 OF OFFICIAL RECORDS.

17. AN EASEMENT FOR KANSAS CITY, A MUNICIPAL CORPORATION RECORDED JANUARY 27, 1976 IN BOOK 649, PAGE 39 OF OFFICIAL RECORDS. (SHOWN, DOES NOT AFFECT THIS PROPERTY)

18. AN EASEMENT FOR KANSAS CITY, A MUNICIPAL CORPORATION RECORDED MARCH 24, 1976 IN BOOK 660, PAGE 117 OF OFFICIAL RECORDS. (SHOWN, AFFECTS THIS PROPERTY)

 AN EASEMENT FOR KANSAS CITY, A MUNICIPAL CORPORATION RECORDED MARCH 24, 1976 IN BOOK 660, PAGE 119 OF OFFICIAL RECORDS. (SHOWN, AFFECTS THIS PROPERTY)

20. AN EASEMENT FOR KANSAS CITY, A MUNICIPAL CORPORATION RECORDED JUNE 13, 1977 IN BOOK 760, PAGE 817 OF OFFICIAL RECORDS. (SHOWN, DOES NOT AFFECT THIS PROPERTY)

21. A RIGHT-OF-WAY TO PANHANDLE EASTERN PIPE LINE COMPANY IN THE DOCUMENT RECORDED AUGUST 30, 1977 IN BOOK 782, PAGE 717 OF OFFICIAL RECORDS. (SHOWN, AFFECTS THIS PROPERTY)

22. AN EASEMENT FOR KANSAS CITY, A MUNICIPAL CORPORATION RECORDED OCTOBER 4, 1977 IN BOOK 791, PAGE 1376 OF OFFICIAL RECORDS. (AFFECTS THIS PROPERTY, BLANKET IN NATURE)

23. EASEMENTS, RESTRICTIONS AND SETBACK LINES AS PER PLAT, RECORDED AS UNITED MISSOURI BANK, RECORDED IN BOOK 34, PAGE 62. (SHOWN, AFFECTS THIS PROPERTY) (ORIGINAL PLAT CALLS FOR SANITARY SEWER EASEMENT, REPLAT CALLS OUT STORM SEWER EASEMENT)

24. TERMS AND CONDITION OF STORM SEWER AGREEMENT DATED SEPTEMBER 5, 1978 AND RECORDED OCTOBER 11, 1978 IN BOOK 882, PAGE 2274. 25. AN EASEMENT FOR KANSAS CITY POWER & LIGHT COMPANY RECORDED MARCH 22, 1979 IN BOOK 916, PAGE 5 OF OFFICIAL RECORDS. (SHOWN,

DOES NOT AFFECT THIS PROPERTY) 26. AN EASEMENT FOR KANSAS CITY POWER & LIGHT COMPANY RECORDED MARCH 22, 1979 IN BOOK 916, PAGE 7 OF OFFICIAL RECORDS. (SHOWN,

AN EASEMENT FOR KANSAS CITY POWER & LIGHT COMPANY RECORDED JULY 20, 1987 IN BOOK 1703, PAGE 1839 OF OFFICIAL RECORDS.

(SHOWN, DOES NOT AFFECT THIS PROPERTY

28. AN EASEMENT TO KANSAS CITY, A CONSTITUTIONALLY CHARTERED MUNICIPAL CORPORATION RECORDED DECEMBER 12, 2011 IN DOCUMENT NO. 2011E0117016. (DOES NOT AFFECTS THIS PROPERTY)

29. AN EASEMENT TO KANSAS CITY, A MISSOURI MUNICIPAL CORPORATION, THROUGH ITS WATER SERVICE DEPARTMENT RECORDED OCTOBER 17, 2011 IN DOCUMENT NO. 2011E0095925. (DOES NOT AFFECTS THIS PROPERTY)

30. EASEMENTS, RESTRICTIONS AND SETBACK LINES AS PER PLAT, RECORDED AS CARONDELET THREE, RECORDED IN BOOK K38, PAGE 96. (SHOWN, AFFECTS THIS PROPERTY) (UNITED MISSOURI BANK PLAT CALLS FOR SANITARY SEWER EASEMENT AND CORONDELET THREE PLAT CALLS FOR STORM SEWER EASEMENT, EXISTING SANITARY SEWER LINE LIES WITHIN 15' EASEMENT)

31. ORDINANCE NO. 921066 VACATING A PART OF CARONDELET DRIVE BETWEEN THE EAST LINE OF STATE LINE ROAD AND THE WEST LINE OF WORNALL ROAD AND ALL UTILITY EASEMENTS, OVER, UNDER, ALONG AND ACROSS SAID STREET ALL IN KANSAS CITY, JACKSON COUNTY, MISSOURI

32. TERMS AND CONDITIONS OF SAID AGREEMENT DATED NOVEMBER 15, 1977 AND RECORDED DECEMBER 5, 1977 IN BOOK 807, PAGE 1876. (AFFECTS THIS PROPERTY, BLANKET IN NATURE)

UTILITY NOTE:

UTILITIES SHOWN HEREON ARE SHOWN FROM FIELD LOCATES BY THE UTILITY COMPANIES OR THEIR RESPECTIVE REPRESENTATIVES AND MAPPING PROVIDED BY THE UTILITY COMPANIES AND ARE NOT THE RESULT OF AN ACTUAL DIG. PEI DOES NOT GUARANTEE THAT ALL UTILITIES ARE SHOWN

BEFORE DIGGING, CONTACT THE MISSOURI ONE CALL SYSTEM AT 1 800 DIG-RITE OR 811 FOR UTILITY LOCATES.

THIS PROPERTY IS ZONED B2-2 & R-0.5 KANSAS CITY MISSOURI GIS WEBSITE

NOTE: THIS SURVEYOR WAS NOT SUPPLIED A ZONING REPORT OR LETTER FOR THIS SURVEY.

BENCHMARK: VERTICAL DATUM = NAVD88 BASED ON GPS OBSERVATION USING (MODOT VRS) 1. SET "C" CUT IN CENTER FRONT FACE OF CURB INLET AT APPROXIMATE MIDPOINT OF SOUTH PROPERTY LINE LOT 3, CORONDELET THREE ON

ELEVATION = 845.67 2. SET PLUS CUT IN CONCRETE SIDEWALK IN THE SOUTHEAST QUADRANT OF CORONDELET DRIVE AND STATE LINE ROAD JUST EAST OF AN

ELECTRIC MANHOLE LID ELEVATION = 848.97

CERTIFICATION:

TO: VTRE DEVELOPMENT, LLC, A DELAWARE LIMITED LIABILITY COMPANY; UNITED MISSOURI BANK OF KANSAS CITY, N.A., A NATIONAL BANKING ASSOCIATION AND FIRST AMERICAN TITLE INSURANCE COMPANY

THIS IS TO CERTIFY THAT THIS MAP OR PLAT AND THE SURVEY ON WHICH IT IS BASED WERE MADE IN ACCORDANCE WITH THE 2016 "MINIMUM STANDARD DETAIL REQUIREMENTS FOR ALTA/NSPS LAND TITLE SURVEYS," JOINTLY ESTABLISHED AND ADOPTED BY ALTA AND NSPS, AND INCLUDES ITEMS 1, 2, 3, 4, 5, 6(A), 6(b), 7(c), 7(b1), 7(C) 8, 9, 11, 13, 14, 16, 17, 18, 19 AND 20 OF TABLE A THEREOF. THE FIELD WORK WAS COMPLETED ON FEBRUARY 12, 2021.







435 & STATE LINE 1310 Carondelet Dr, Kansas City, MO 64114

Prepared for VanTrust Real Estate 4900 Main St. Ste 400, Kansas City, MO 64112

**UMB Financial Corportation** 1010 Grand Boulevard, Kansas City, MO 64106



LET THREE COUNTY, DRIVE

0

0

Hellmuth, Obata & Kassabaum, Inc. 300 West 22nd Street Kansas City, MO 64108 USA t +1 816 472 3360 f +1 816 472 2100

GastingerWalker 6 UMB Retail Bank Architect

817 Wyandotte St, Kansas City, MO 64105 t +1 816 421 8200 f +1 816 421 1262

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Oppermann LandDesign LLC Retail Bank Landscape Architect 22 Debra Lane, New Windsor, New York 12553

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Professional Seals

PDP SUBMITTAL **NOT FOR CONSTRUCTION** 

F	DD CLIDMICCION
	PDP SUBMISSION
	PDP RE-SUBMISSION
	PDP RE-SUBMISSION
roiect No:	20.70060.00
	20.10000.00
heet Title:	
A I T /	A SURVEY
	roject No:

Original is 36 x 24. Do not scale contents of this drawing. Sheet Number

DRAW KANSAS KANSAS KANSAS BNGNEE

SHEET

#### **DEMOLITION NOTES:**

1. THE CONTRACTOR IS RESPONSIBLE FOR THE DEMOLITION, REMOVAL, AND DISPOSAL (IN A LOCATION APPROVED BY ALL GOVERNING AUTHORITIES) ALL CURBS, PARKING, DRIVES, DRAINAGE STRUCTURES, UTILITIES, ETC., SUCH THAT THE IMPROVEMENTS SHOWN ON THE REMAINING PLANS CAN BE CONSTRUCTED. ALL FACILITIES TO BE REMOVED SHALL BE UNDERCUT TO SUITABLE MATERIAL AND BROUGHT TO GRADE WITH SUITABLE COMPACTED FILL MATERIAL.

2. THE CONTRACTOR IS RESPONSIBLE FOR REMOVING ALL DEBRIS FROM THE SITE AND DISPOSING THE DEBRIS IN A LAWFUL MANNER. THE CONTRACTOR IS RESPONSIBLE FOR OBTAINING ALL PERMITS REQUIRED FOR DEMOLITION AND DISPOSAL.

JAMAGE TO ALL EXISTING CONDITIONS TO REMAIN WILL BE REPLACED AT CONTRACTOR'S EXPENSE.CONTRACTOR MUST COORDINATE WITH OWNER PRIOR TO ANY CONSTRUCTION TO ESTABLISH CUSTOMER ACCESS AND TRAFFIC FLOW DURING ALL PHASES.

5. REFER TO THE BUILDING PLANS FOR SITE LIGHTING ELECTRICAL MODIFICATIONS (IF ANY) TO THE

**LEGEND** 

REMOVE EXISTING CURB & GUTTER

EXISTING BUILDING TO BE REMOVED

EXISTING GRAVEL TO BE REMOVED

EXISTING TREE TO REMAIN

EXISTING BURIED TELEPHONE

EXISTING FIBER OPTIC LINE

EXISTING BURIED ELECTRIC

EXISTING SANITARY SEWER
EXISTING STORM SEWER
EXISTING FIRE HYDRANT

EXISTING LIGHT POLE

99TH STREET

N1/2

103RD STREET

CARONDELET DRIVE

VICINITY MAP

FRAC. SEC. 31-48-33

1"=2000'

EXISTING OVERHEAD POWER LINE

EXISTING WATER LINE
EXISTING GAS LINE

EXISTING CABLE TELEVISION LINE

EXISTING ASPHALT PAVEMENT TO BE REMOVED

EXISTING CONCRETE PAVEMENT/SIDEWALK TO BE REMOVED

PL PROPERTY LINE

- LL - LOT LINE

— −R/W− — RIGHT−OF−WAY

VanTrust REAL ESTATE LLC



Project
435 & STATE LINE
1310 Carondelet Dr, Kansas City, MO 64114

Prepared for
VanTrust Real Estate
4900 Main St. Ste 400, Kansas City, MO 64112
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Professional Seals

# PDP SUBMITTAL NOT FOR CONSTRUCTION

No.	Description	Date
1	PDP SUBMISSION	4.30.2021
2	PDP RE-SUBMISSION	7.1.2021
3	PDP RE-SUBMISSION	7.29.2021

Project No: 20.70060.00

DEMOLITION PLAN - PHASE 1


Original is 36 x 24. Do not scale contents of this drawing.

Sheet Number

C'

SCALE: 1"=30'

PEI #210040

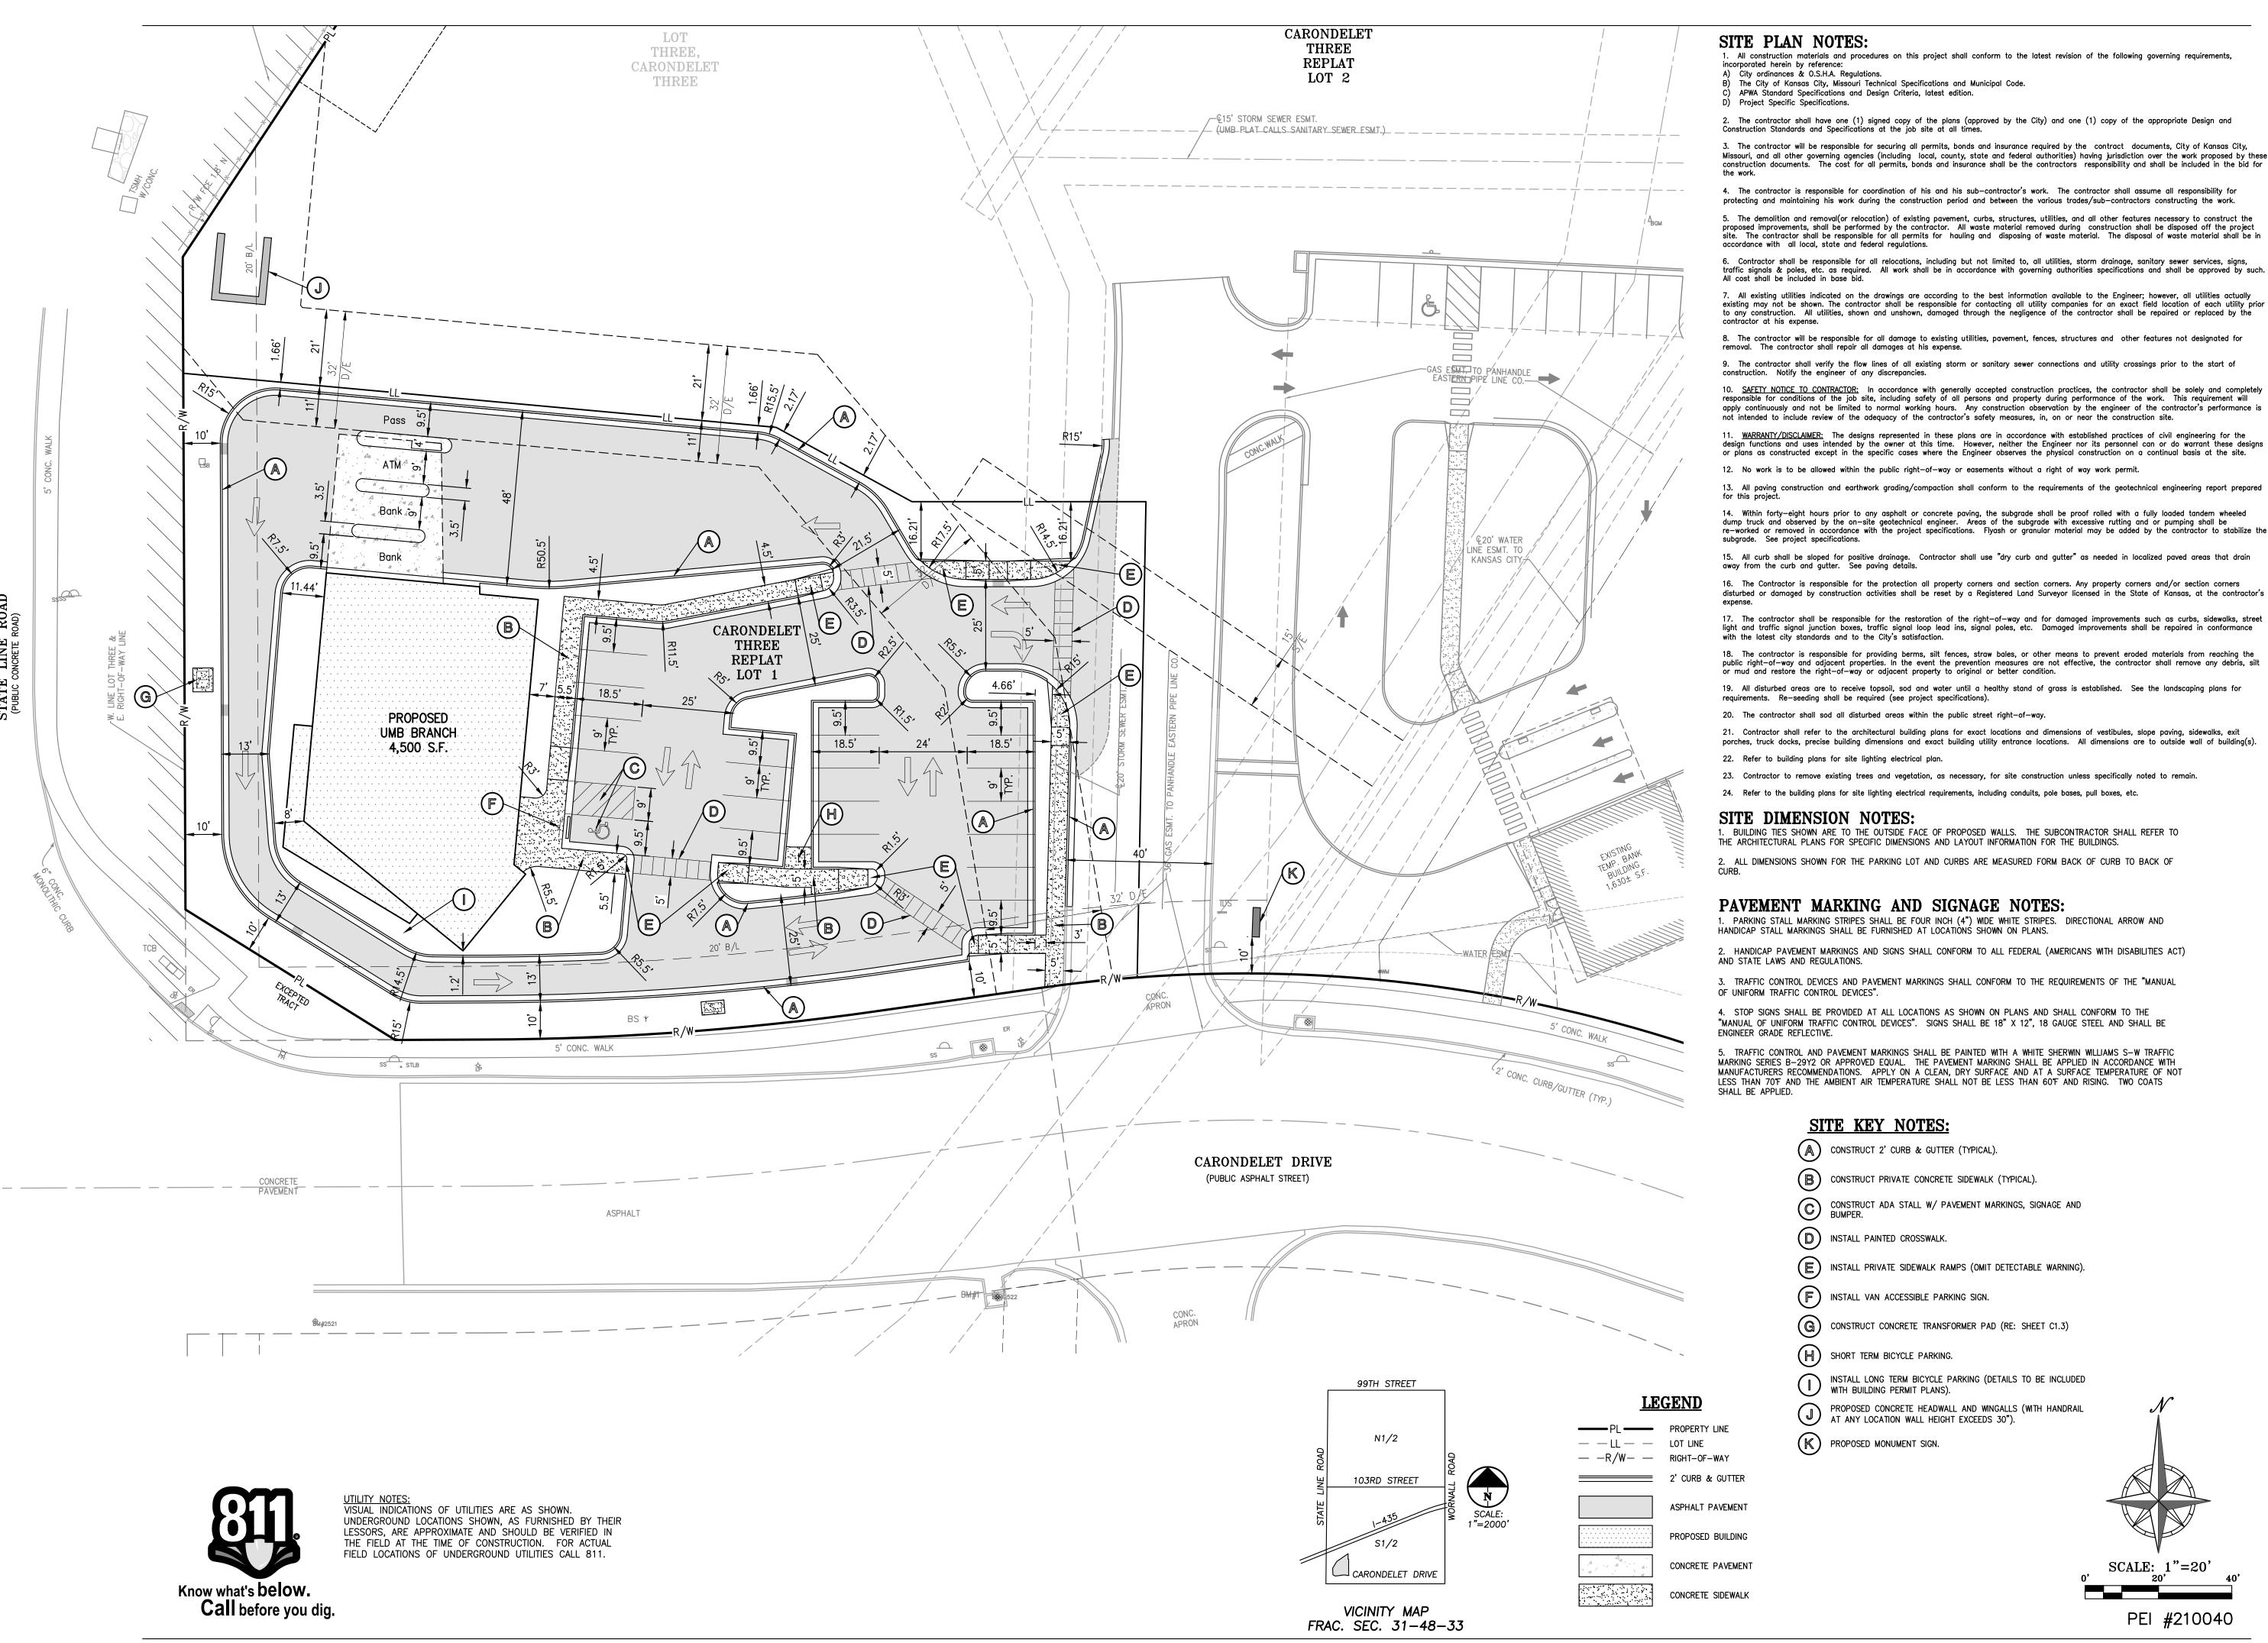

SITE PLAN NOTES:

1. All construction materials and procedures on this project shall conform to the latest revision of the following governing requirements,

A) City ordinances & O.S.H.A. Regulations.

The City of Kansas City, Missouri Technical Specifications and Municipal Code. APWA Standard Specifications and Design Criteria, latest edition.

2. The contractor shall have one (1) signed copy of the plans (approved by the City) and one (1) copy of the appropriate Design and Construction Standards and Specifications at the job site at all times.

3. The contractor will be responsible for securing all permits, bonds and insurance required by the contract documents, City of Kansas City, Missouri, and all other governing agencies (including local, county, state and federal authorities) having jurisdiction over the work proposed by these construction documents. The cost for all permits, bonds and insurance shall be the contractors responsibility and shall be included in the bid for

4. The contractor is responsible for coordination of his and his sub-contractor's work. The contractor shall assume all responsibility for protecting and maintaining his work during the construction period and between the various trades/sub-contractors constructing the work.

5. The demolition and removal(or relocation) of existing pavement, curbs, structures, utilities, and all other features necessary to construct the proposed improvements, shall be performed by the contractor. All waste material removed during construction shall be disposed off the project site. The contractor shall be responsible for all permits for hauling and disposing of waste material. The disposal of waste material shall be in accordance with all local, state and federal regulations.

6. Contractor shall be responsible for all relocations, including but not limited to, all utilities, storm drainage, sanitary sewer services, signs, traffic signals & poles, etc. as required. All work shall be in accordance with governing authorities specifications and shall be approved by such.

to any construction. All utilities, shown and unshown, damaged through the negligence of the contractor shall be repaired or replaced by the

8. The contractor will be responsible for all damage to existing utilities, pavement, fences, structures and other features not designated for removal. The contractor shall repair all damages at his expense.

9. The contractor shall verify the flow lines of all existing storm or sanitary sewer connections and utility crossings prior to the start of construction. Notify the engineer of any discrepancies. 10. SAFETY NOTICE TO CONTRACTOR: In accordance with generally accepted construction practices, the contractor shall be solely and completely

apply continuously and not be limited to normal working hours. Any construction observation by the engineer of the contractor's performance is not intended to include review of the adequacy of the contractor's safety measures, in, on or near the construction site. 11. WARRANTY/DISCLAIMER: The designs represented in these plans are in accordance with established practices of civil engineering for the

design functions and uses intended by the owner at this time. However, neither the Engineer nor its personnel can or do warrant these designs or plans as constructed except in the specific cases where the Engineer observes the physical construction on a continual basis at the site. 12. No work is to be allowed within the public right-of-way or easements without a right of way work permit.

13. All paving construction and earthwork grading/compaction shall conform to the requirements of the geotechnical engineering report prepared 14. Within forty-eight hours prior to any asphalt or concrete paving, the subgrade shall be proof rolled with a fully loaded tandem wheeled

dump truck and observed by the on—site geotechnical engineer. Areas of the subgrade with excessive rutting and or pumping shall be re—worked or removed in accordance with the project specifications. Flyash or granular material may be added by the contractor to stabilize the

15. All curb shall be sloped for positive drainage. Contractor shall use "dry curb and gutter" as needed in localized paved areas that drain

16. The Contractor is responsible for the protection all property corners and section corners. Any property corners and/or section corners disturbed or damaged by construction activities shall be reset by a Registered Land Surveyor licensed in the State of Kansas, at the contractor's

17. The contractor shall be responsible for the restoration of the right-of-way and for damaged improvements such as curbs, sidewalks, street light and traffic signal junction boxes, traffic signal loop lead ins, signal poles, etc. Damaged improvements shall be repaired in conformance with the latest city standards and to the City's satisfaction.

18. The contractor is responsible for providing berms, silt fences, straw bales, or other means to prevent eroded materials from reaching the public right—of—way and adjacent properties. In the event the prevention measures are not effective, the contractor shall remove any debris, silt or mud and restore the right—of—way or adjacent property to original or better condition.

19. All disturbed areas are to receive topsoil, sod and water until a healthy stand of grass is established. See the landscaping plans for requirements. Re-seeding shall be required (see project specifications).

20. The contractor shall sod all disturbed areas within the public street right-of-way.

21. Contractor shall refer to the architectural building plans for exact locations and dimensions of vestibules, slope paving, sidewalks, exit porches, truck docks, precise building dimensions and exact building utility entrance locations. All dimensions are to outside wall of building(s).

22. Refer to building plans for site lighting electrical plan.

23. Contractor to remove existing trees and vegetation, as necessary, for site construction unless specifically noted to remain.

24. Refer to the building plans for site lighting electrical requirements, including conduits, pole bases, pull boxes, etc.

#### SITE DIMENSION NOTES:

THE ARCHITECTURAL PLANS FOR SPECIFIC DIMENSIONS AND LAYOUT INFORMATION FOR THE BUILDINGS.

2. ALL DIMENSIONS SHOWN FOR THE PARKING LOT AND CURBS ARE MEASURED FORM BACK OF CURB TO BACK OF

#### PAVEMENT MARKING AND SIGNAGE NOTES:

1. PARKING STALL MARKING STRIPES SHALL BE FOUR INCH (4") WIDE WHITE STRIPES. DIRECTIONAL ARROW AND HANDICAP STALL MARKINGS SHALL BE FURNISHED AT LOCATIONS SHOWN ON PLANS.

2. HANDICAP PAVEMENT MARKINGS AND SIGNS SHALL CONFORM TO ALL FEDERAL (AMERICANS WITH DISABILITIES ACT) AND STATE LAWS AND REGULATIONS.

3. TRAFFIC CONTROL DEVICES AND PAVEMENT MARKINGS SHALL CONFORM TO THE REQUIREMENTS OF THE "MANUAL

4. STOP SIGNS SHALL BE PROVIDED AT ALL LOCATIONS AS SHOWN ON PLANS AND SHALL CONFORM TO THE

"MANUAL OF UNIFORM TRAFFIC CONTROL DEVICES". SIGNS SHALL BE 18" X 12", 18 GAUGE STEEL AND SHALL BE ENGINEER GRADE REFLECTIVE.

5. TRAFFIC CONTROL AND PAVEMENT MARKINGS SHALL BE PAINTED WITH A WHITE SHERWIN WILLIAMS S-W TRAFFIC MARKING SERIES B-29Y2 OR APPROVED EQUAL. THE PAVEMENT MARKING SHALL BE APPLIED IN ACCORDANCE WITH MANUFACTURERS RECOMMENDATIONS. APPLY ON A CLEAN, DRY SURFACE AND AT A SURFACE TEMPERATURE OF NOT LESS THAN 70°F AND THE AMBIENT AIR TEMPERATURE SHALL NOT BE LESS THAN 60°F AND RISING. TWO COATS

#### **SITE KEY NOTES:**

(A) CONSTRUCT 2' CURB & GUTTER (TYPICAL).

(B) CONSTRUCT PRIVATE CONCRETE SIDEWALK (TYPICAL).

CONSTRUCT ADA STALL W/ PAVEMENT MARKINGS, SIGNAGE AND BUMPER.

(D) INSTALL PAINTED CROSSWALK.

(E) INSTALL PRIVATE SIDEWALK RAMPS (OMIT DETECTABLE WARNING).

(F) INSTALL VAN ACCESSIBLE PARKING SIGN.


(G) CONSTRUCT CONCRETE TRANSFORMER PAD (RE: SHEET C1.3)

(H) SHORT TERM BICYCLE PARKING.

INSTALL LONG TERM BICYCLE PARKING (DETAILS TO BE INCLUDED WITH BUILDING PERMIT PLANS).

PROPOSED CONCRETE HEADWALL AND WINGALLS (WITH HANDRAIL AT ANY LOCATION WALL HEIGHT EXCEEDS 30").

PROPOSED MONUMENT SIGN.

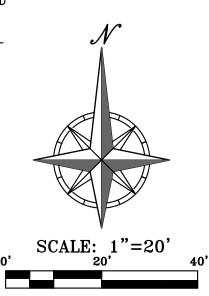

PEI #210040





435 & STATE LINE 1310 Carondelet Dr, Kansas City, MO 64114

Prepared for

VanTrust Real Estate 4900 Main St. Ste 400, Kansas City, MO 64112

**UMB Financial Corportation** 1010 Grand Boulevard, Kansas City, MO 64106



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22 Debra Lane, New Windsor, New York 12553

Lankford Fendler Associates **Engineering Consultant** 

1730 Walnet St, Kansas City, MO 64108

Professional Seals

No. Description

## PDP SUBMITTAL **NOT FOR CONSTRUCTION**

1	PDP SUBMISSION	4.30.202
2	PDP RE-SUBMISSION	7.1.202
3	PDP RE-SUBMISSION	7.29.202
-		
Project No:	20 70060 00	

Sheet Title:

SITE PLAN -PHASE 1

Original is 36 x 24. Do not scale contents of this drawing. Sheet Number

#### **SITE GRADING NOTES:**

- CONTOURS AND ELEVATIONS: Existing and proposed contours are shown on plans at one foot (1') contour intervals, unless otherwise noted, proposed contours and elevations shown represent approximate finish grade. Contractor shall hold down subgrades to allow for pavement and
- If the contractor does not accept existing topography as shown on the plans, without exception, he shall have made at his expense, a topographic survey by a registered land surveyor and submit it to the owner for review.
- CLEARING AND GRUBBING: Prior to beginning preparation of subgrade, all areas under pavements or building shall be stripped of all topsoil, vegetation, large rock fragments (greater than 6 inches in any dimension) and any other deleterious material. The actual stripping depth should be based on visual examination during construction and the results of proof-rolling operations. The root systems of all trees (not designated to remain) shall be removed in their entirety. Stripping materials shall not be incorporated into structural fills.
- TOPSOIL STRIPPING: Prior to the start of site grading, the contractor shall strip all topsoil from areas to be graded, and stockpiled at a location on or adjacent to the site as directed by the owner. At completion of grading operations and related construction, the contractor will be responsible for redistribution of topsoil over all areas disturbed by the construction activities. Topsoil shall be placed to a minimum depth of six inches (6") and in accordance with specifications for landscaping. At that time, and prior to the installation of landscaping or irrigation, all topsoil graded areas shall be visually inspected and accepted by the owner and ITL.
- Contractor shall adjust and/or cut existing pavement as necessary to assure a smooth fit and continuous grade. Contractor shall assure positive drainage away from buildings for all natural and paved areas.
- SUBGRADE PREPARATION: Prior to placement of new fill material, the existing subgrade shall be proofrolled and approved under the direction of the Geotechnical Engineer or his representative.
- PROOFROLLING: Subsequent to completion of stripping and over—excavation, all building and pavement areas to receive engineered fill should be systematically proof—rolled using a tandem axle dump truck loaded to approximately 20,000 pounds per axle. Also, any finished subgrade areas to receive paving shall be proof—rolled within 48 hours of paving. Unsuitable soils that are detected and that can not be recompacted should be over—excavated and replaced with controlled structural fill.
- EARTHWORK:

A) GEOTECHNICAL: All earthwork shall conform to the recommendations of the Geotechnical report. Said report and its recommendations are herein incorporated into the project requirements by reference. Prior to beginning construction, the contractor shall obtain a copy of and become familiar with the geotechnical report. Unless specifically noted on the plans, the recommendations in the geotechnical report are hereby incorporated into the project requirements and specifications.

B) SURFACE WATER: Surface water shall be intercepted and diverted during the placement of fill.

C) FILLS: All fills shall be considered controlled or structural fill and shall be free of vegetation, organic matter, topsoil and debris. In areas where the thickness of the engineered fill is greater than five, feet building and pavement construction should not commence until so authorized by the on-site geotechnical engineer to allow for consolidation.

D) BUILDING SUBGRADE: As specified in the Geotechnical Engineering Report, the upper 24 inches of building subgrade shall consist of Low Volume Change (LVC) material defined as approved, compacted granular fill or low to moderate plasticity cohesive soil materials stabilized with Class C Flyash. Granular fill shall consist of compacted granular materials with a maximum particle size of two (2) inches or less, such as limestone screenings. Refer to geotechnical report for complete requirements.

E) EXISTING SLOPES: Where fill material is to be placed on existing slopes greater—than 5:1 (horizontal to vertical), existing slope shall be benched providing a minimum vertical face of twelve inches (12"). The benches should be cut wide enough to accommodate the compaction equipment. Fill material shall be placed and compacted in horizontal lifts not exceeding nine inches (9") (loose lift measurement), unless otherwise approved by the Geotechnical Engineer.

F) COMPACTION REQUIREMENTS: The upper 9 inches of pavement subgrade areas shall be compacted to a minimum density of ninety five percent (95%) of the material's maximum dry density as determined by ASTM D698 (standard proctor compaction). The moisture content at the time of placement and compaction shall within a range of 0% below to 4% above optimum moisture content as defined by the standard proctor compaction procedure. The moisture contents shall be maintained within this range until completion of the work. Where compaction of earth fill by a large roller is impractical or undesirable, the earth fill shall be hand compacted with small vibrating rollers or mechanical tampers.

- All cut or fill slopes shall be 3:1 or flatter. All asphalt parking areas shall be a minimum of 1% slope but not more than 5% slope unless otherwise noted. All pavements within ADA parking areas shall not exceed 2% total slope. All grades around building shall be held down 6" from finish floor and slope away another 6" in 10 feet. Contractor shall notify engineer prior to final subgrade construction of any areas not within this slope requirement.
- TESTING AND INSPECTION: Owner's Independent Testing Laboratory (ITL) shall make tests of earthwork during construction and observe the placement of fills and other work performed on this project to verify that work has been completed in accordance with Geotechnical Engineering Report, Project Specifications and within indústry standards. The ITL will be selected by the owner and the cost of testing will be the owner's responsibility.
- 11. CLASSIFICATION: All excavation shall be considered unclassified. No separate or additional payments shall be made for rock excavation.
- RESTORATION: All disturbed areas not in building or pavements shall be sodded, unless shown otherwise by the landscaping plan or erosion
- UTILITIES: The contractor is specifically cautioned that the location and/or elevation of existing utilities as shown on these plans is based on records of the various utility companies, and where possible, measurements taken in the field. The information is not to be relied on as being exact or complete. The contractor must call the appropriate utility companies at least 48 hours before any excavation to request exact field location of utilities. It shall be the responsibility of the contractor to relocate all existing utilities which conflict with the proposed improvements shown on the plans.
- 14. LAND DISTURBANCE: The contractor shall adhere to all terms & conditions as outlined in the EPA or applicable state N.P.D.E.S. permit for storm water discharge associated with construction activities. Refer to project S.W.P.P.P. requirements.





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Project No:	20.70060.00	

**OVERALL GRADING PLAN -**PHASE 1

Original is 36 x 24. Do not scale contents of this drawing. Sheet Number

PEI #210040

ANNUAL CHANCE FLOODPLAIN, AS SHOWN ON THE FLOOD INSURANCE RATE MAP PREPARED BY VISUAL INDICATIONS OF UTILITIES ARE AS SHOWN. THE FEDERAL EMERGENCY MANAGEMENT AGENCY FOR THE CITY OF KANSAS CITY, COMMUNITY NO. UNDERGROUND LOCATIONS SHOWN, AS FURNISHED BY THEIR 290173, JACKSON COUNTY, MISSOURI, MAP NO. 29095C0386G, AND DATED JANUARY 20, 2017. LESSORS, ARE APPROXIMATE AND SHOULD BE VERIFIED IN THE FIELD AT THE TIME OF CONSTRUCTION. FOR ACTUAL


FIELD LOCATIONS OF UNDERGROUND UTILITIES CALL 811.

Know what's below.

Call before you dig.

VERTICAL DATUM = NAVD88 BASED ON GPS OBSERVATION USING (MODOT VRS) SET "-" CUT IN CENTER FRONT FACE OF CURB INLET AT APPROXIMATE MIDPOINT OF SOUTH PROPERTY LINE LOT 3. CORONDELET THREE ON THE SOUTH SIDE OF CORONDELET DRIVE AT THE WEST RETURN OF THE NORTH ENTRANCE TO GAS STATION ELEVATION = 845.67

STATE LINE ROAD JUST EAST OF AN ELECTRIC MANHOLE LID

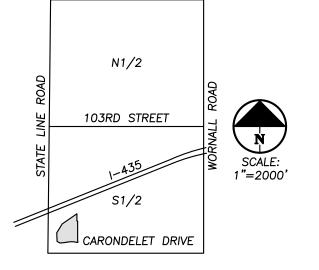

VICINITY MAP FRAC. SEC. 31-48-33

99TH STREET


- - R/W- - RIGHT-OF-WAY 2' CURB & GUTTER EXISTING CONTOURS PROPOSED CONTOURS <del>-----</del>918-----EXISTING STORM SEWER PROPOSED STORM PIPE PROPOSED WET CURB & GUTTER PROPOSED DRY CURB & GUTTER

PROPOSED RETAINING WALL

**LEGEND** 

— LOT LINE

SET PLUS CUT IN CONCRETE SIDEWALK IN THE SOUTHEAST QUADRANT OF CORONDELET DRIVE AND ELEVATION = 848.97

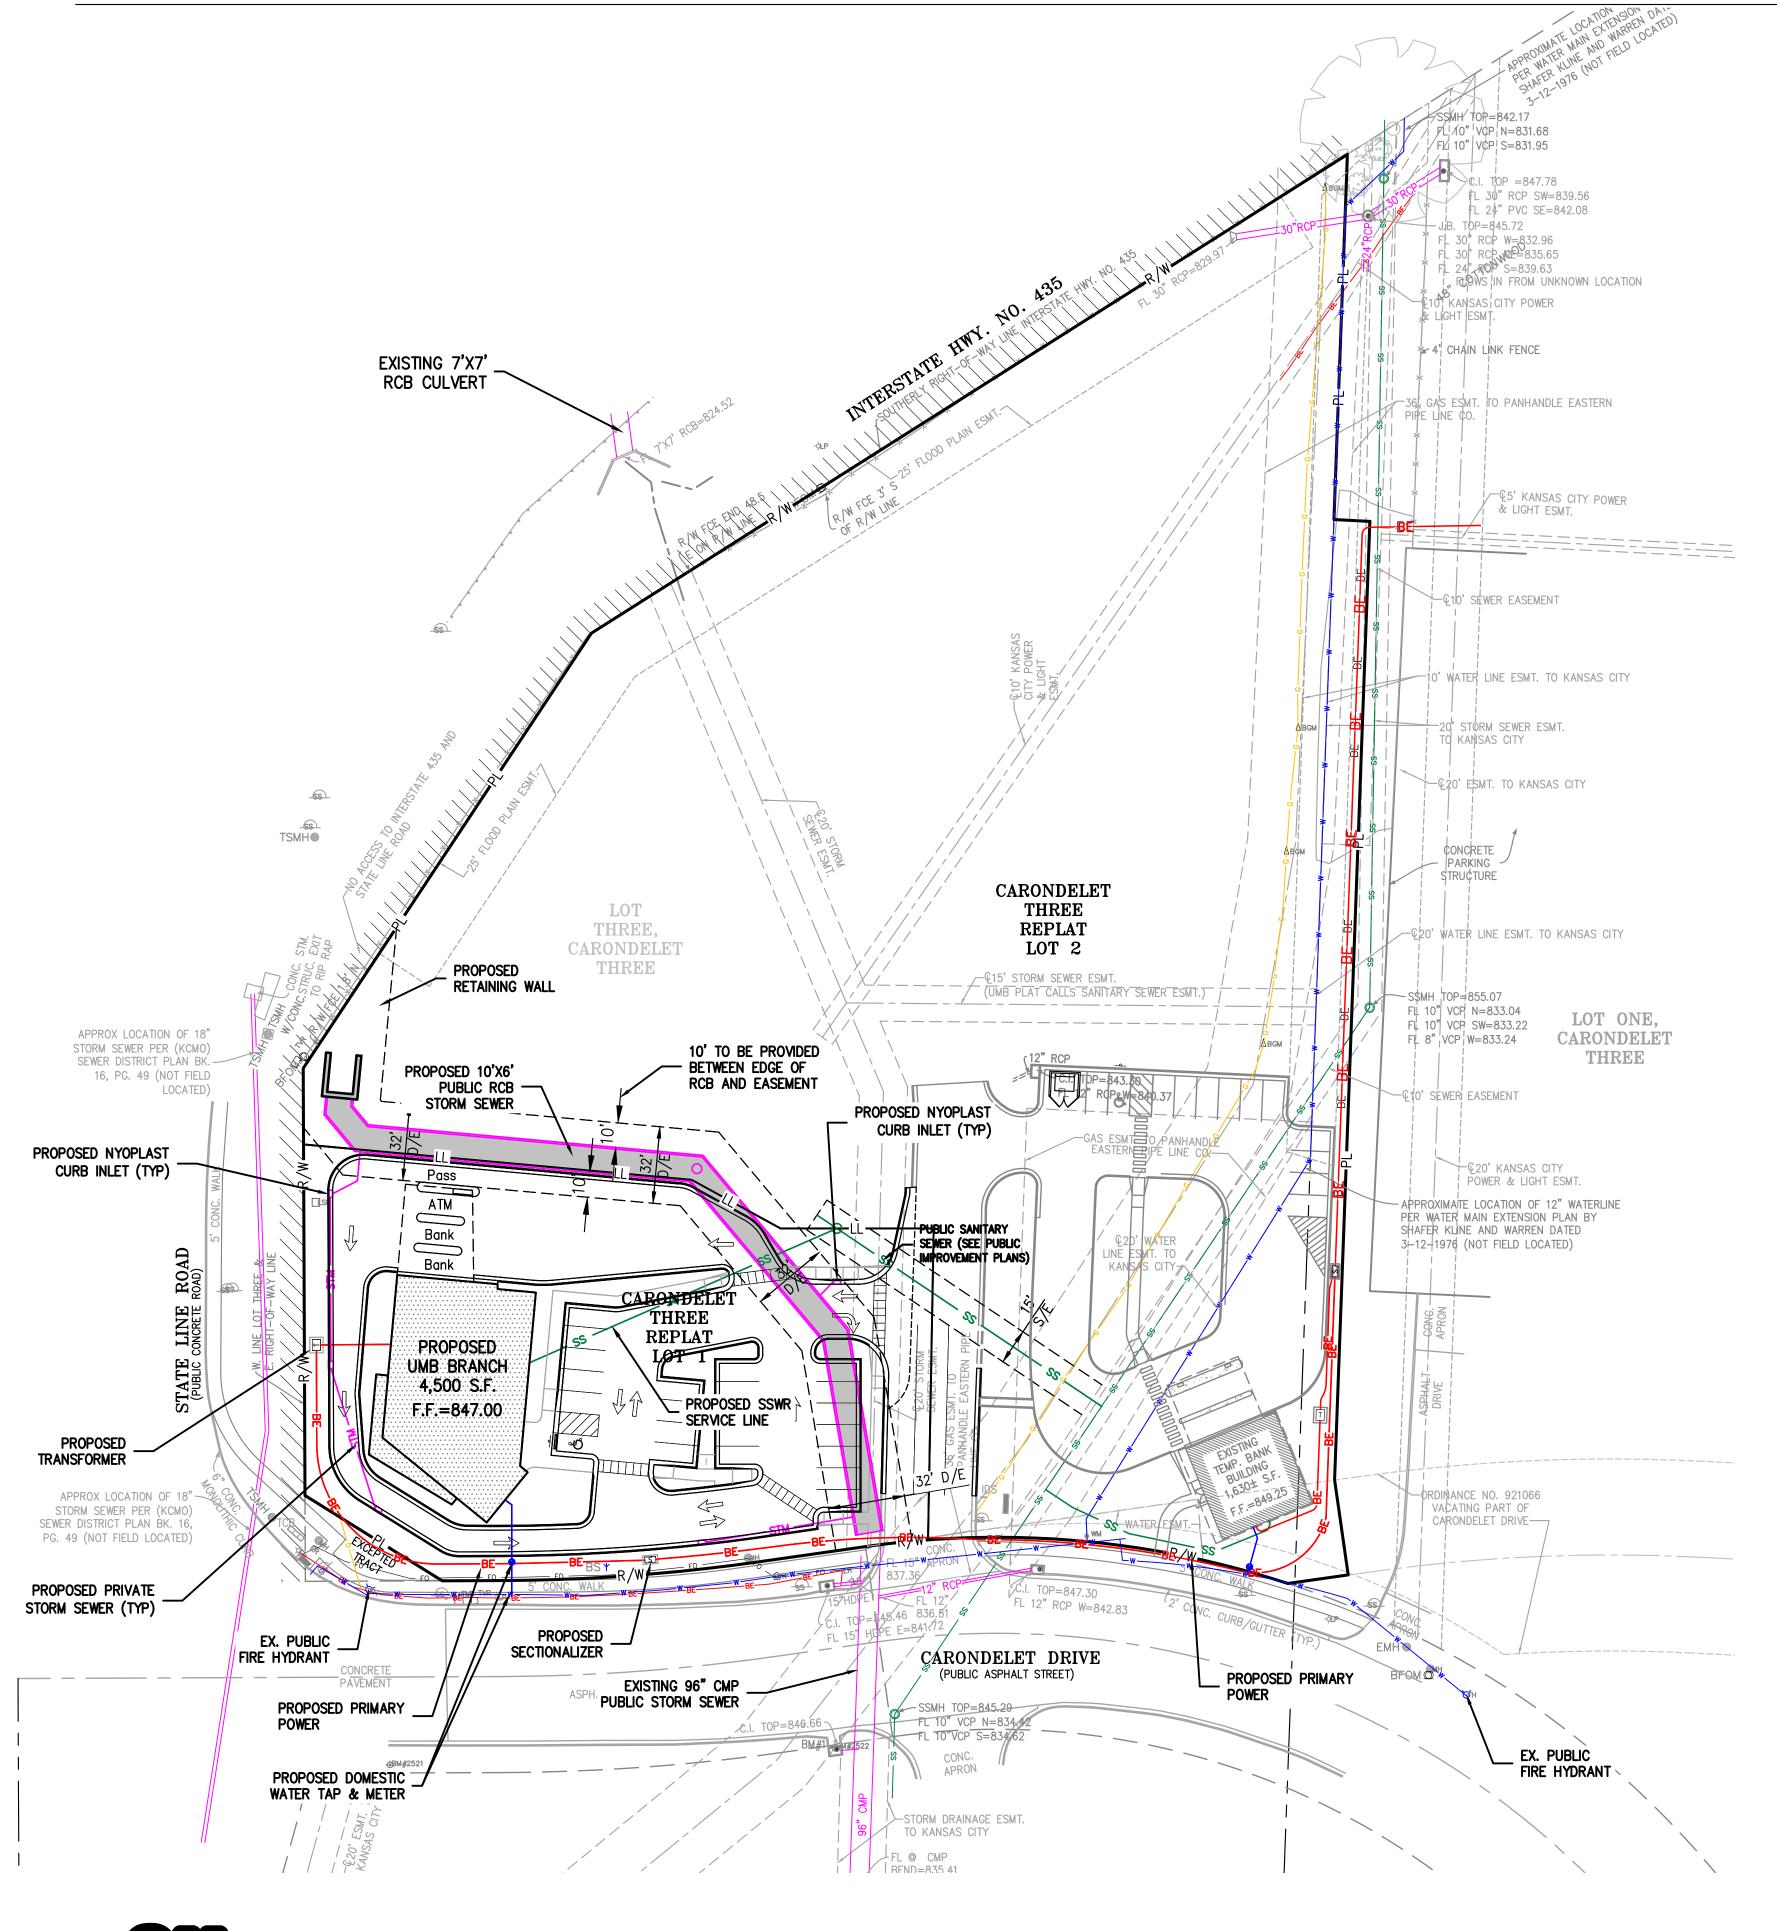

#### UTILITY NOTES:

- 1. The contractor is specifically cautioned that the location and/or elevation of existing utilities as shown on these plans is based on records of the various utility companies, and where possible, measurements taken in the field. The information is not to be relied on as being exact or complete. The contractor must call the appropriate utility companies at least 48 hours before any excavation to request exact field location of utilities. It shall be the responsibility of the contractor to coordinate with and relocate &/or remove all existing utilities which conflict with the proposed improvements shown on the plans.
- 2. The construction of storm sewers on this project shall conform to the requirements of the City's Technical Specifications and Design Criteria.
- 3. The contractor shall field verify the exact location and elevation of the existing storm sewer lines and the existing elevation at locations where the proposed storm sewer collects or releases to existing ground. If discrepancies are encountered from the information shown on the plans, the contractor shall contact the design engineer. No pipes shall be laid until direction is received from the design engineer.
- 4. It will be the contractors responsibility to field adjust the top of all manholes and boxes as necessary to match the grade of the adjacent area. Tops of existing manholes shall be raised as necessary to be flush with proposed pavement elevations, and to be 6-inches above finished ground elevations in non-paved areas. No separate or additional compensation will be made to the contractor for making final adjustments to the
- 5. Inlet locations, horizontal pipe information and vertical pipe information is shown to the center of the structure. Deflection angles shown for storm sewer pipes are measured from the center of curb inlets and manholes. The contractor shall adjust the horizontal location of the pipes to go to the face of the boxes. All roof drains shall be connected to storm sewer structures. Provide cleanouts on roof drain lines at 100' max. Spacing and at all bend points. Do not connect roof drains directly to storm sewer pipe.
- 6. The contractor shall be responsible for furnishing and installing all fire and domestic water lines, meters, backflow devices, pits, valves and all other incidentals required for a complete operable fire protection and domestic water system. All costs associated with the complete water system for the buildings shall be the responsibility of the contractor. All work shall conform to the requirements of City.
- 7. The contractor shall be responsible for furnishing and installing all sanitary sewer service lines from the buildings to the public line. All work shall conform to the requirements of the City.
- 8. The contractor will be responsible for securing all permits, bonds and insurance required by the contract documents, City, and all other governing agencies (including local, county, state and federal authorities) having jurisdiction over the work proposed by these construction documents. The cost for all permits bonds and insurance shall be the contractors responsibility and shall be included in the bid for the work.
- 9. By the use of these construction documents the contractor hereby agrees that he/she shall be solely responsible for the safety of the construction workers and the public. The contractor agrees to hold the engineer and owner harmless for any and all injuries, claims, losses or damages related
- 10. The Contractor shall be responsible for furnishing all materials, tools and equipment and installation of electrical power, telephone and gas service from a point of connection from the public utility lines to the building structures. This will include all conduits, service lines, meters, concrete pads and all other incidentals required for a complete and operational system as required by the owner and the public utilities. Refer to building plans for exact tie-in locations of all utilities. Contractor shall verify connection points prior to installation of utility line.
- 11. All fill material is to be in place, compacted, and consolidated before installation of proposed utilities. On-site geotechnical engineer shall provide written confirmation that this requirement has been met and that utilities may proceed in the fill areas. All utilities are to be placed in trench
- 12. Contractor shall notify the utility authorities inspectors 48 hours before connecting to any existing line.
- 13. Water lines shall be as follows (unless otherwise shown on plans):
- Pipe sizes less than 3-inches that are installed below grade and outside building shall comply with the following: 1. Seamless Copper Tubing: Type "K" soft copper, ASTM B88. 2. Fittings: Wrought copper (95\_5 Tin Antimony solder joint), ASME B 16.22.
- 14. Minimum trench width shall be 2 feet.
- 15. Contractor shall maintain a minimum of 42" cover on all waterlines. All water line joints are to be mechanical joints with thrust blocking as called out in specifications and construction plans. Water mains and service lines shall be constructed in accordance to City's specifications for
- 16. All waterlines shall be kept min. ten (10') apart (parallel) from sanitary sewer lines or manholes. Or when crossing, an 24" vertical clearance (outside edge of pipe to outside edge of pipe) of the water line above the sewer line is required.
- 17. Sanitary conflicts will be resolved prior to permit issuance.
- 18. All underground storm, sanitary, water and other utility lines shall be installed, inspected and approved before backfilling. Failure to have inspection approval prior to backfill will constitute rejection of work.
- 19. All necessary inspections and/or certifications required by codes and/or utility service companies shall be performed prior to announced building possession and the final connection of service. Contractor shall coordinate with all utility companies for installation requirements and specifications.
- 20. Refer to building plans for site lighting electrical plan, irrigation, parking lot security system and associated conduit requirements. Coordinate with Owner that all required conduits are in place & tested prior to paving.
- 21. When a building utility connection from site utilities leading up to the building cannot be made immediately, temporarily mark all such site utility

TIME WARNER CABLE

15 NW BARRY ROAD

KANSAS CITY, MO. 64155

22. Refer to the building plans for site lighting electrical requirements, including conduits, pole bases, pull boxes, etc.

## t +1 816 472 3360 f +1 816 472 2100

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300 West 22nd Street

Kansas City, MO 64108 USA

435 & STATE LINE

Prepared for

and

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## PDP SUBMITTAL **NOT FOR CONSTRUCTION**

Description	Date
PDP SUBMISSION	4.30.2021
PDP RE-SUBMISSION	7.1.2021
PDP RE-SUBMISSION	7.29.2021
	PDP SUBMISSION PDP RE-SUBMISSION

Project No: 20.70060.00

**UTILITY PLAN -**PHASE 1

Original is 36 x 24. Do not scale contents of this drawing. Sheet Number

C1.3

(816) 513-2627 SPIRE ENERGY (816) 472-3434 CITY OF KANSAS CITY BEVERLY PASSANTINO PUBLIC WORKS DEPARTMENT 7500 E. 35TH TERRACE 414 E. 12TH STREET KANSAS CITY, MO. 64129 KANSAS CITY, MO. 64106 EMAIL: beverly.passantino@spireenergy.com CITY OF KANSAS CITY (GENERAL NUMBER) (816) 513-1313 **EVERGY** (816) 420-4721 CARLA HASKINS (WATER) (816) 513-2133 MELISSA FELTES EMAIL: carla.haskins@kcmo.org 8325 N. PLATTE PURCHASE DRIVE AMY BUNNELL (LAND DEVELOPMENT DIVISION) (816) 513-2552 KANSAS CITY, MO. 64118 EMAIL: amy.bunnell@kcmo.org 4800 E. 63RD STREET E-MAIL: Melissa.Feltes@kcpl.com KANSAS CITY, MO. 64130

(816) 734-8700

**LEGEND** 

JILL SCHROEDER 9556 N. MCGEE COURT KANSAS CITY, MO 64155 EMAIL: jb0311@att.com

**UTILITY COMPANIES:** 

PL PROPERTY LINE — — LL — — LOT LINE

VICINITY MAP FRAC. SEC. 31-48-33

99TH STREET — −R/W− — RIGHT−0F−WAY ----- EXISTING CABLE TELEVISION LINE EXISTING FIBER OPTIC LINE EXISTING GAS LINE N1/2EXISTING BURIED ELECTRIC LINE EXISTING OVERHEAD POWER LINE EXISTING OVERHEAD TELEPHONE LINE 103RD STREET EXISTING SANITARY SEWER LINE 24"HDPE EXISTING STORM SEWER LINE (& SIZE) -----BT------ EXISTING BURIED TELEPHONE LINE ————w——6"— EXISTING WATER LINE (& SIZE) S1/2 CARONDELET DRIVE

PROPOSED BURIED ELECTRIC LINE ------ SS ------ PROPOSED SANITARY SEWER LINE PROPOSED STORM SEWER LINE (& SIZE) 

VISUAL INDICATIONS OF UTILITIES ARE AS SHOWN. UNDERGROUND LOCATIONS SHOWN, AS FURNISHED BY THEIR LESSORS, ARE APPROXIMATE AND SHOULD BE VERIFIED IN THE FIELD AT THE TIME OF CONSTRUCTION. FOR ACTUAL FIELD LOCATIONS OF UNDERGROUND UTILITIES CALL 811. Know what's **below. Call** before you dig.

#### **DEMOLITION NOTES:**

1. THE CONTRACTOR IS RESPONSIBLE FOR THE DEMOLITION, REMOVAL, AND DISPOSAL (IN A LOCATION APPROVED BY ALL GOVERNING AUTHORITIES) ALL CURBS, PARKING, DRIVES, DRAINAGE STRUCTURES, UTILITIES, ETC., SUCH THAT THE IMPROVEMENTS SHOWN ON THE REMAINING PLANS CAN BE CONSTRUCTED. ALL FACILITIES TO BE REMOVED SHALL BE UNDERCUT TO SUITABLE MATERIAL AND BROUGHT TO GRADE WITH SUITABLE COMPACTED FILL MATERIAL.

2. THE CONTRACTOR IS RESPONSIBLE FOR REMOVING ALL DEBRIS FROM THE SITE AND DISPOSING THE DEBRIS IN A LAWFUL MANNER. THE CONTRACTOR IS RESPONSIBLE FOR OBTAINING ALL PERMITS REQUIRED FOR DEMOLITION AND DISPOSAL.

- 3. DAMAGE TO ALL EXISTING CONDITIONS TO REMAIN WILL BE REPLACED AT CONTRACTOR'S EXPENSE.
- 4. CONTRACTOR MUST COORDINATE WITH OWNER PRIOR TO ANY CONSTRUCTION TO ESTABLISH CUSTOMER ACCESS AND TRAFFIC FLOW DURING ALL PHASES.

5. REFER TO THE BUILDING PLANS FOR SITE LIGHTING ELECTRICAL MODIFICATIONS (IF ANY) TO THE EXISTING SYSTEM.

**LEGEND** 

REMOVE EXISTING CURB & GUTTER

BE REMOVED

-----BT------ EXISTING BURIED TELEPHONE

EXISTING BUILDING TO BE REMOVED

EXISTING GRAVEL TO BE REMOVED

EXISTING TREE TO REMAIN

EXISTING CABLE TELEVISION LINE

EXISTING FIBER OPTIC LINE

EXISTING BURIED ELECTRIC

EXISTING SANITARY SEWER

EXISTING STORM SEWER

EXISTING FIRE HYDRANT

EXISTING LIGHT POLE

EXISTING OVERHEAD POWER LINE

EXISTING WATER LINE

EXISTING GAS LINE

EXISTING ASPHALT PAVEMENT TO BE REMOVED

EXISTING CONCRETE PAVEMENT/SIDEWALK TO

PL PROPERTY LINE

— −R/W− — RIGHT−OF−WAY

- - LL - LOT LINE

VanTrus<sup>1</sup>



Project
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		·

Project No: 20.70060.00

DEMOLITION PLAN - PHASE 2

Original is 36 x 24. Do not scale contents of this drawing.

Sheet Number

**C**2

SCALE: 1"=30'

PEI #210040

N1/2

103RD STREET

NOWNALL ROAD

SCALE
1"=200

LP -**-**-

99TH STREET

VICINITY MAP FRAC. SEC. 31-48-33

VISUAL INDICATIONS OF UTILITIES ARE AS SHOWN. UNDERGROUND LOCATIONS SHOWN, AS FURNISHED BY THEIR LESSORS, ARE APPROXIMATE AND SHOULD BE VERIFIED IN THE FIELD AT THE TIME OF CONSTRUCTION. FOR ACTUAL

N1/2 103RD STREET N SCALE: 1"=2000' S1/2 → CARONDELET DRIVE

99TH STREET

VICINITY MAP FRAC. SEC. 31-48-33

#### SITE PLAN NOTES:

1. All construction materials and procedures on this project shall conform to the latest revision of the following governing requirements, incorporated herein by reference:

A) City ordinances & O.S.H.A. Regulations. The City of Kansas City, Missouri Technical Specifications and Municipal Code.

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2. The contractor shall have one (1) signed copy of the plans (approved by the City) and one (1) copy of the appropriate Design and Construction Standards and Specifications at the job site at all times.

3. The contractor will be responsible for securing all permits, bonds and insurance required by the contract documents, City of Kansas City, Missouri, and all other governing agencies (including local, county, state and federal authorities) having jurisdiction over the work proposed by these construction documents. The cost for all permits, bonds and insurance shall be the contractors responsibility and shall be included in the bid for

4. The contractor is responsible for coordination of his and his sub-contractor's work. The contractor shall assume all responsibility for protecting and maintaining his work during the construction period and between the various trades/sub-contractors constructing the work.

5. The demolition and removal(or relocation) of existing pavement, curbs, structures, utilities, and all other features necessary to construct the proposed improvements, shall be performed by the contractor. All waste material removed during construction shall be disposed off the project site. The contractor shall be responsible for all permits for hauling and disposing of waste material. The disposal of waste material shall be in accordance with all local, state and federal regulations.

6. Contractor shall be responsible for all relocations, including but not limited to, all utilities, storm drainage, sanitary sewer services, signs, traffic signals & poles, etc. as required. All work shall be in accordance with governing authorities specifications and shall be approved by such.

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7. All existing utilities indicated on the drawings are according to the best information available to the Engineer; however, all utilities actually

8. The contractor will be responsible for all damage to existing utilities, pavement, fences, structures and other features not designated for removal. The contractor shall repair all damages at his expense.

9. The contractor shall verify the flow lines of all existing storm or sanitary sewer connections and utility crossings prior to the start of construction. Notify the engineer of any discrepancies.

10. SAFETY NOTICE TO CONTRACTOR: In accordance with generally accepted construction practices, the contractor shall be solely and completely responsible for conditions of the job site, including safety of all persons and property during performance of the work. This requirement will apply continuously and not be limited to normal working hours. Any construction observation by the engineer of the contractor's performance is not intended to include review of the adequacy of the contractor's safety measures, in, on or near the construction site.

11. WARRANTY/DISCLAIMER: The designs represented in these plans are in accordance with established practices of civil engineering for the design functions and uses intended by the owner at this time. However, neither the Engineer nor its personnel can or do warrant these designs or plans as constructed except in the specific cases where the Engineer observes the physical construction on a continual basis at the site.

12. No work is to be allowed within the public right-of-way or easements without a right of way work permit. 13. All paving construction and earthwork grading/compaction shall conform to the requirements of the geotechnical engineering report prepared for this project.

14. Within forty—eight hours prior to any asphalt or concrete paving, the subgrade shall be proof rolled with a fully loaded tandem wheeled dump truck and observed by the on—site geotechnical engineer. Areas of the subgrade with excessive rutting and or pumping shall be re—worked or removed in accordance with the project specifications. Flyash or granular material may be added by the contractor to stabilize the

15. All curb shall be sloped for positive drainage. Contractor shall use "dry curb and gutter" as needed in localized paved areas that drain away from the curb and gutter. See paving details

16. The Contractor is responsible for the protection all property corners and section corners. Any property corners and/or section corners disturbed or damaged by construction activities shall be reset by a Registered Land Surveyor licensed in the State of Kansas, at the contractor's

17. The contractor shall be responsible for the restoration of the right-of-way and for damaged improvements such as curbs, sidewalks, street light and traffic signal junction boxes, traffic signal loop lead ins, signal poles, etc. Damaged improvements shall be repaired in conformance with the latest city standards and to the City's satisfaction.

18. The contractor is responsible for providing berms, silt fences, straw bales, or other means to prevent eroded materials from reaching the public right-of-way and adjacent properties. In the event the prevention measures are not effective, the contractor shall remove any debris, silt or mud and restore the right-of-way or adjacent property to original or better condition.

19. All disturbed areas are to receive topsoil, sod and water until a healthy stand of grass is established. See the landscaping plans for

20. The contractor shall sod all disturbed areas within the public street right-of-way.

21. Contractor shall refer to the architectural building plans for exact locations and dimensions of vestibules, slope paving, sidewalks, exit porches, truck docks, precise building dimensions and exact building utility entrance locations. All dimensions are to outside wall of building(s).

22. Refer to building plans for site lighting electrical plan.

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23. Contractor to remove existing trees and vegetation, as necessary, for site construction unless specifically noted to remain.

24. Refer to the building plans for site lighting electrical requirements, including conduits, pole bases, pull boxes, etc.

#### SITE DIMENSION NOTES:

1. BUILDING TIES SHOWN ARE TO THE OUTSIDE FACE OF PROPOSED WALLS. THE SUBCONTRACTOR SHALL REFER TO THE ARCHITECTURAL PLANS FOR SPECIFIC DIMENSIONS AND LAYOUT INFORMATION FOR THE BUILDINGS.

2. ALL DIMENSIONS SHOWN FOR THE PARKING LOT AND CURBS ARE MEASURED FORM BACK OF CURB TO BACK OF

#### PAVEMENT MARKING AND SIGNAGE NOTES:

1. PARKING STALL MARKING STRIPES SHALL BE FOUR INCH (4") WIDE WHITE STRIPES. DIRECTIONAL ARROW AND HANDICAP STALL MARKINGS SHALL BE FURNISHED AT LOCATIONS SHOWN ON PLANS.

2. HANDICAP PAVEMENT MARKINGS AND SIGNS SHALL CONFORM TO ALL FEDERAL (AMERICANS WITH DISABILITIES ACT) AND STATE LAWS AND REGULATIONS.

3. TRAFFIC CONTROL DEVICES AND PAVEMENT MARKINGS SHALL CONFORM TO THE REQUIREMENTS OF THE "MANUAL

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"MANUAL OF UNIFORM TRAFFIC CONTROL DEVICES". SIGNS SHALL BE 18" X 12", 18 GAUGE STEEL AND SHALL BE ENGINEER GRADE REFLECTIVE.

5. TRAFFIC CONTROL AND PAVEMENT MARKINGS SHALL BE PAINTED WITH A WHITE SHERWIN WILLIAMS S-W TRAFFIC MARKING SERIES B-29Y2 OR APPROVED EQUAL. THE PAVEMENT MARKING SHALL BE APPLIED IN ACCORDANCE WITH MANUFACTURERS RECOMMENDATIONS. APPLY ON A CLEAN, DRY SURFACE AND AT A SURFACE TEMPERATURE OF NOT LESS THAN 70°F AND THE AMBIENT AIR TEMPERATURE SHALL NOT BE LESS THAN 60°F AND RISING. TWO COATS SHALL BE APPLIED.



435 & STATE LINE 1310 Carondelet Dr, Kansas City, MO 64114

#### Prepared for

VanTrust Real Estate 4900 Main St. Ste 400, Kansas City, MO 64112 and

**UMB Financial Corportation** 1010 Grand Boulevard, Kansas City, MO 64106



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UMB Retail Bank Architect 817 Wyandotte St, Kansas City, MO 64105 t +1 816 421 8200 f +1 816 421 1262

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#### Phelps Engineering Inc Civil Engineering

1270 N Winchester St #5878, Olathe, KS 66061

#### Oppermann LandDesign LLC Retail Bank Landscape Architect

22 Debra Lane, New Windsor, New York 12553

#### Lankford Fendler Associates

**Engineering Consultant** 1730 Walnet St, Kansas City, MO 64108

Professional Seals


## PDP SUBMITTAL **NOT FOR CONSTRUCTION**

No.	Description	Date
1	PDP SUBMISSION	4.30.2021
2	PDP RE-SUBMISSION	7.1.2021
3	PDP RE-SUBMISSION	7.29.2021

Project No: 20.70060.00

**OVERALL SITE** PLAN - PHASE 2

Original is 36 x 24. Do not scale contents of this drawing. Sheet Number

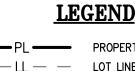


PL PROPERTY LINE - - LL - LOT LINE — −R/W− — RIGHT-OF-WAY 2' CURB & GUTTER

ASPHALT PAVEMENT PERVIOUS PAVEMENT PROPOSED BUILDING

CONCRETE PAVEMENT CONCRETE SIDEWALK

PEI #210040

FIELD LOCATIONS OF UNDERGROUND UTILITIES CALL 811. Know what's below. Call before you dig.

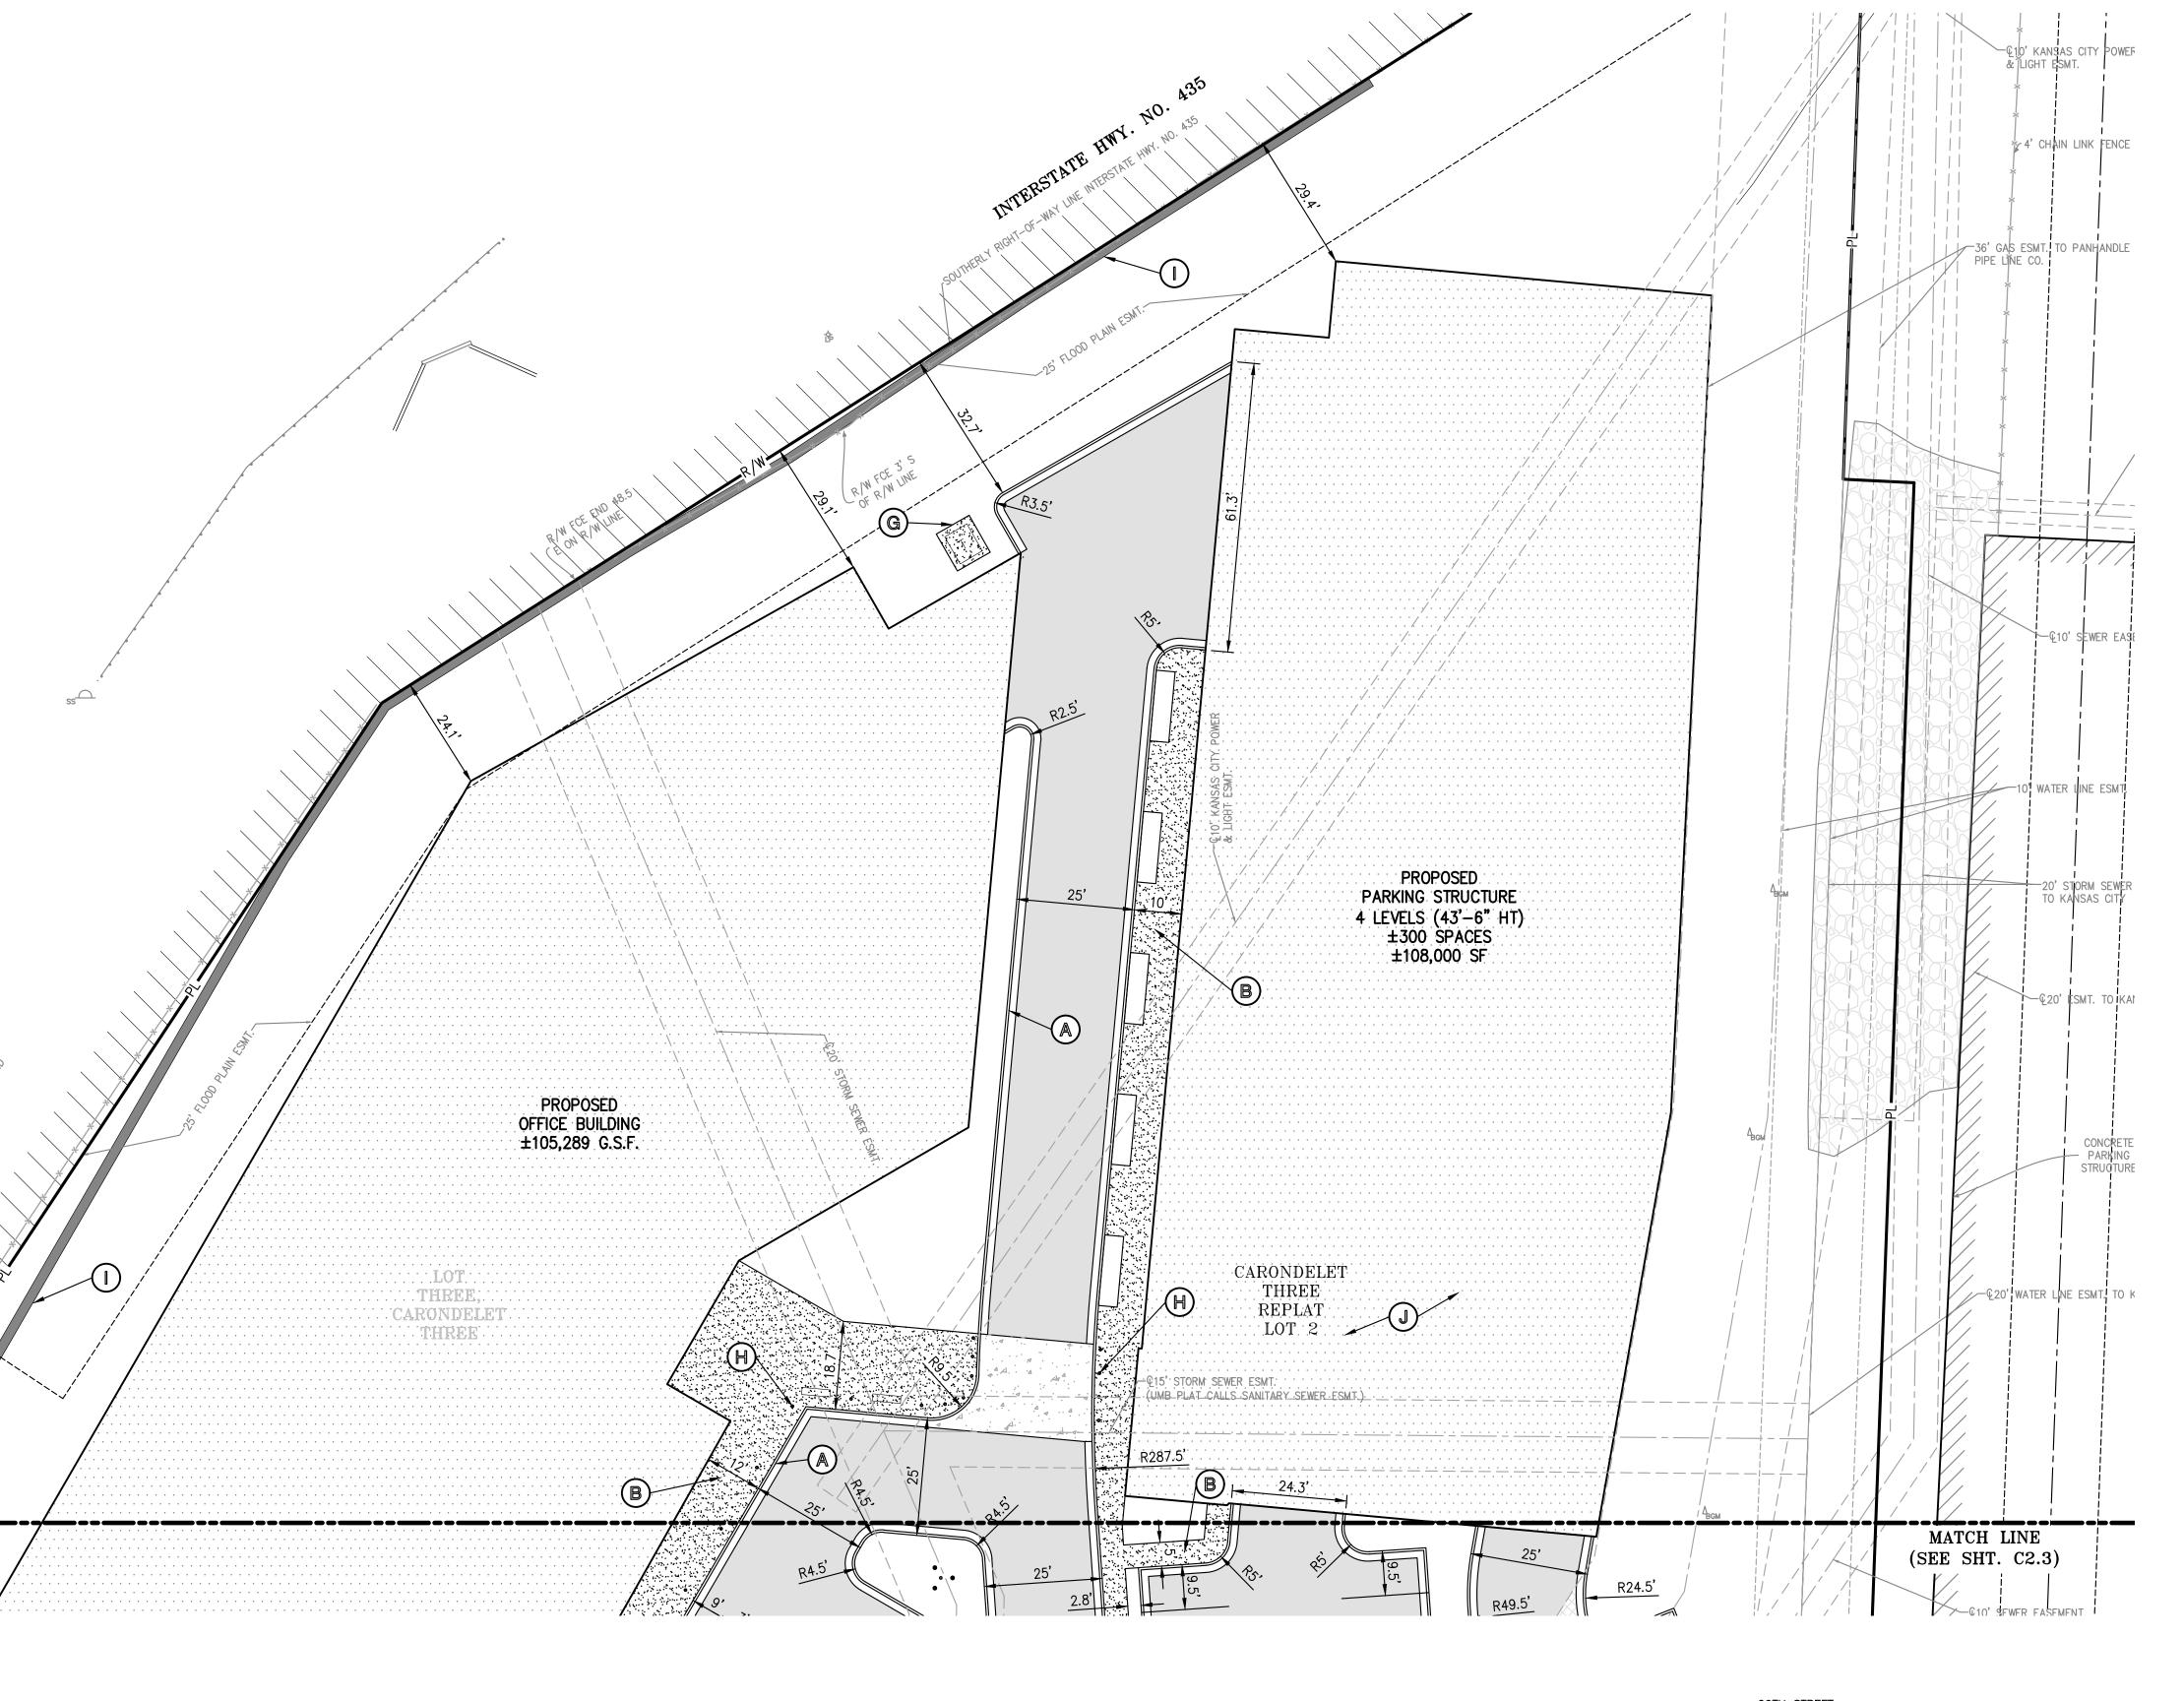

## 99TH STREET N1/2 103RD STREET SCALE: 1"=2000' S1/2 CARONDELET DRIVE

VICINITY MAP

**LEGEND** PL PROPERTY LINE — — LL — — LOT LINE

— −R/W− — RIGHT−OF−WAY 2' CURB & GUTTER

CONCRETE PAVEMENT CONCRETE SIDEWALK

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#### **SITE KEY NOTES:**

- (A) CONSTRUCT 2' CURB & GUTTER (TYPICAL).
- (B) CONSTRUCT PRIVATE CONCRETE SIDEWALK (TYPICAL).
- (C) CONSTRUCT ADA STALL W/ PAVEMENT MARKINGS AND SIGNAGE.
- INSTALL BUMPER BLOCK.
- (E) INSTALL BICYCLE PARKING (RE: ARCHITECT PLAN).
- (F) INSTALL FLAG POLE (RE: ARCH PLANS).
- G CONSTRUCT CONCRETE TRANSFORMER PAD.
- (H) INSTALL BOLLARD (TYPICAL).
- CONSTRUCT SEGMENTAL BLOCK RETAINING WALL (WITH HANDRAIL AT ANY LOCATION WALL HEIGHT EXCEEDS 30").
- ( J ) LONG TERM BICYCLE PARKING LOCATED WITHIN PARKING GARAGE.
- (K) INSTALL ACCESSIBLE PARKING SIGN.
- ( L ) INSTALL VAN ACCESSIBLE PARKING SIGN.



PEI #210040

Original is 36 x 24. Do not scale contents of this drawing. Sheet Number

Project No: 20.70060.00

**ENLARGED SITE** 

PLAN - PHASE 2

435 & STATE LINE

Prepared for

and

1310 Carondelet Dr, Kansas City, MO 64114

4900 Main St. Ste 400, Kansas City, MO 64112

**UMB Financial Corportation** 

1010 Grand Boulevard, Kansas City, MO 64106

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22 Debra Lane, New Windsor, New York 12553

PDP SUBMITTAL

**NOT FOR** 

CONSTRUCTION

4.30.2021

7.29.2021

7.1.2021

Oppermann LandDesign LLC

Lankford Fendler Associates

1730 Walnet St, Kansas City, MO 64108

**Engineering Consultant** 

Professional Seals

No. Description

PDP SUBMISSION

PDP RE-SUBMISSION

PDP RE-SUBMISSION

Retail Bank Landscape Architect

t +1 816 421 8200 f +1 816 421 1262

Kansas City, MO 64108 USA


VanTrust Real Estate

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FRAC. SEC. 31-48-33

PROPOSED BUILDING

ASPHALT PAVEMENT PERVIOUS PAVEMENT

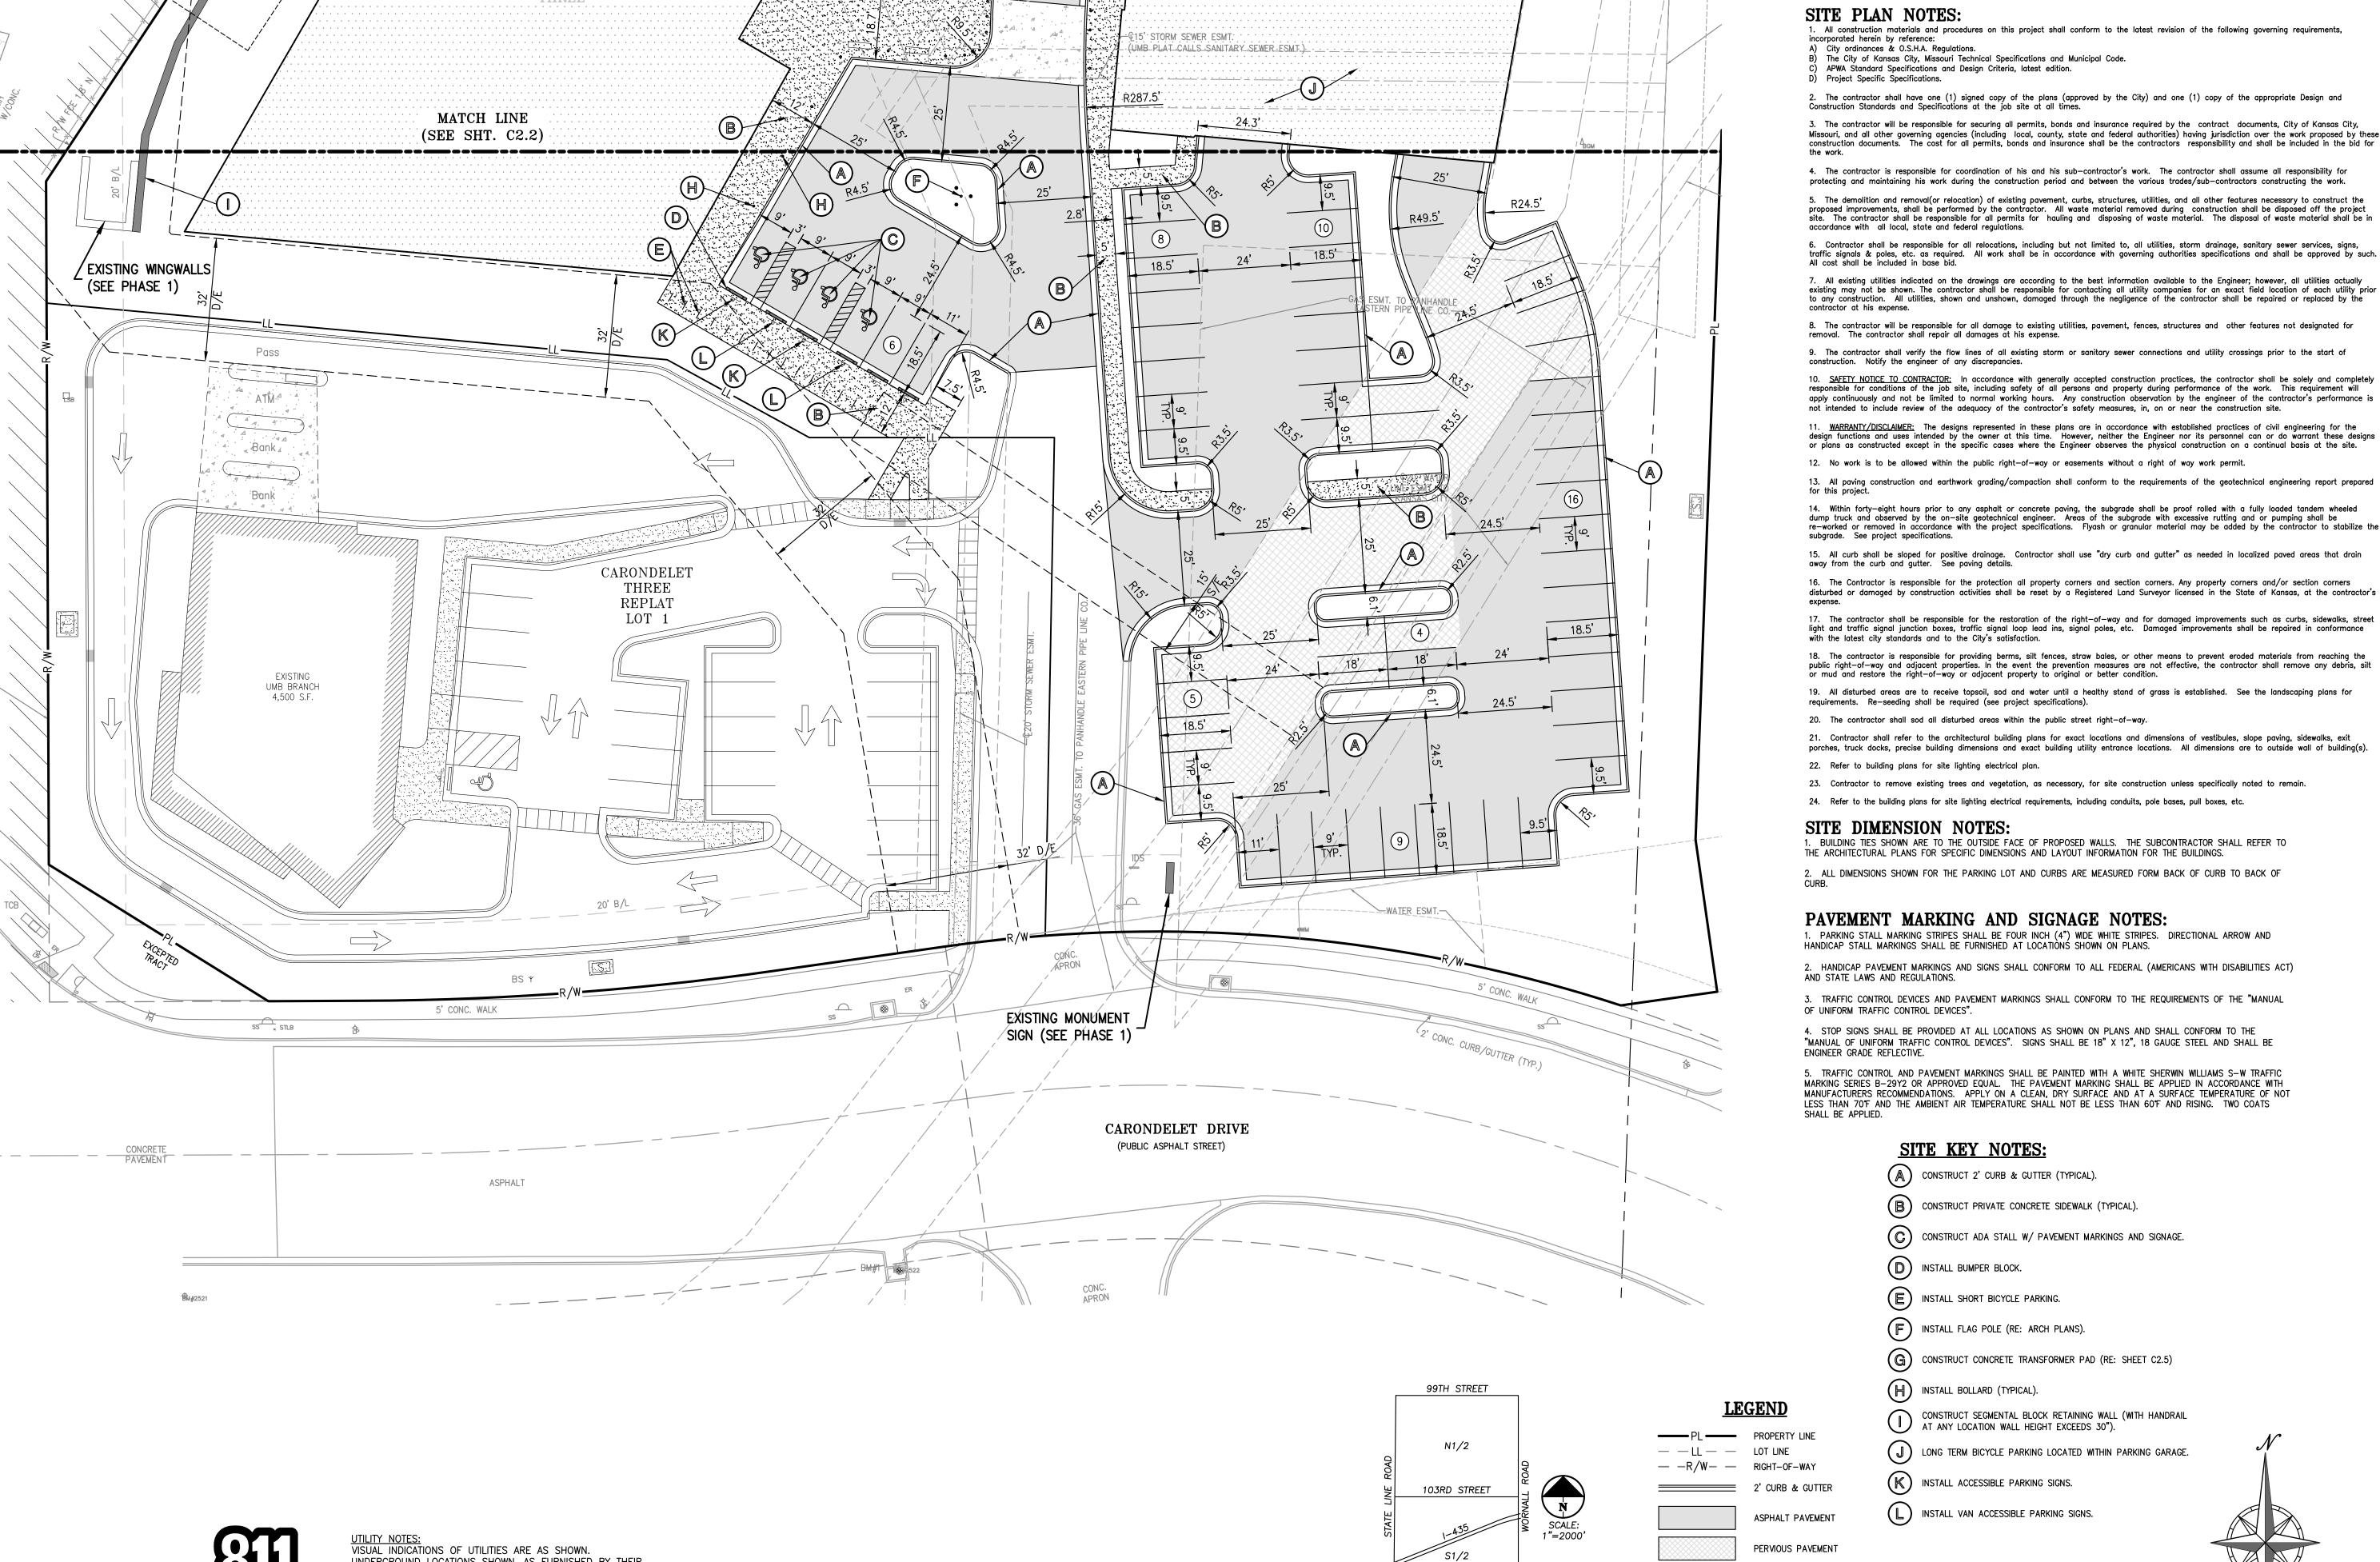

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#### **SITE KEY NOTES:**

(A) CONSTRUCT 2' CURB & GUTTER (TYPICAL).

(B) CONSTRUCT PRIVATE CONCRETE SIDEWALK (TYPICAL).

(C) CONSTRUCT ADA STALL W/ PAVEMENT MARKINGS AND SIGNAGE.

INSTALL BUMPER BLOCK.

(E) INSTALL SHORT BICYCLE PARKING.

(F) INSTALL FLAG POLE (RE: ARCH PLANS).

CONSTRUCT CONCRETE TRANSFORMER PAD (RE: SHEET C2.5)


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( J ) LONG TERM BICYCLE PARKING LOCATED WITHIN PARKING GARAGE.

(K) INSTALL ACCESSIBLE PARKING SIGNS.

ig( ig ig) install van accessible parking signs.





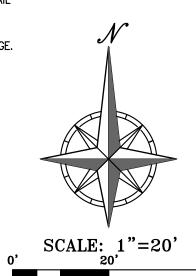

435 & STATE LINE 1310 Carondelet Dr, Kansas City, MO 64114

Prepared for

VanTrust Real Estate 4900 Main St. Ste 400, Kansas City, MO 64112 and

**UMB Financial Corportation** 1010 Grand Boulevard, Kansas City, MO 64106



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## GastingerWalker 6

UMB Retail Bank Architect 817 Wyandotte St, Kansas City, MO 64105 t +1 816 421 8200 f +1 816 421 1262

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1270 N Winchester St #5878, Olathe, KS 66061 Oppermann LandDesign LLC

Retail Bank Landscape Architect 22 Debra Lane, New Windsor, New York 12553

Lankford Fendler Associates **Engineering Consultant** 

1730 Walnet St, Kansas City, MO 64108

Professional Seals

No. Description

PDP SUBMITTAL **NOT FOR** CONSTRUCTION

1	PDP SUBMISSION	4.30.202
2	PDP RE-SUBMISSION	7.1.202
3	PDP RE-SUBMISSION	7.29.202
	1 DI TRE-CODIVIGOTOR	1.23.202

Project No: 20.70060.00 Sheet Title:

**ENLARGED SITE** PLAN - PHASE 2

Original is 36 x 24. Do not scale contents of this drawing. Sheet Number

PERVIOUS PAVEMENT PROPOSED BUILDING CARONDELET DRIVE CONCRETE PAVEMENT VICINITY MAP FRAC. SEC. 31-48-33 CONCRETE SIDEWALK PEI #210040

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UTILITY NOTES:
VISUAL INDICATIONS OF UTILITIES ARE AS SHOWN.
UNDERGROUND LOCATIONS SHOWN, AS FURNISHED BY THEIR

LESSORS, ARE APPROXIMATE AND SHOULD BE VERIFIED IN

THE FIELD AT THE TIME OF CONSTRUCTION. FOR ACTUAL

FIELD LOCATIONS OF UNDERGROUND UTILITIES CALL 811.

#### FLOOD NOTE:

THIS PROPERTY LIES WITHIN ZONE X, DEFINED AS AREAS DETERMINED TO BE OUTSIDE THE 0.2% ANNUAL CHANCE FLOODPLAIN, AS SHOWN ON THE FLOOD INSURANCE RATE MAP PREPARED BY THE FEDERAL EMERGENCY MANAGEMENT AGENCY FOR THE CITY OF KANSAS CITY, COMMUNITY NO. 290173, JACKSON COUNTY, MISSOURI, MAP NO. 29095C0386G, AND DATED JANUARY 20, 2017.

#### **BENCHMARK:**

VERTICAL DATUM = NAVD88 BASED ON GPS OBSERVATION USING (MODOT VRS) SET "□" CUT IN CENTER FRONT FACE OF CURB INLET AT APPROXIMATE MIDPOINT OF SOUTH PROPERTY LINE LOT 3, CORONDELET THREE ON THE SOUTH SIDE OF CORONDELET DRIVE AT THE WEST RETURN OF THE NORTH ENTRANCE TO GAS STATION ELEVATION = 845.67

SET PLUS CUT IN CONCRETE SIDEWALK IN THE SOUTHEAST QUADRANT OF CORONDELET DRIVE AND STATE LINE ROAD JUST EAST OF AN ELECTRIC MANHOLE LID ELEVATION = 848.97

#### **SITE GRADING NOTES:**

- CONTOURS AND ELEVATIONS: Existing and proposed contours are shown on plans at one foot (1') contour intervals, unless otherwise noted, proposed contours and elevations shown represent approximate finish grade. Contractor shall hold down subgrades to allow for pavement and sub-base thicknesses.
- If the contractor does not accept existing topography as shown on the plans, without exception, he shall have made at his expense, a topographic survey by a registered land surveyor and submit it to the owner for review.
- CLEARING AND GRUBBING: Prior to beginning preparation of subgrade, all areas under pavements or building shall be stripped of all topsoil, vegetation, large rock fragments (greater than 6 inches in any dimension) and any other deleterious material. The actual stripping depth should be based on visual examination during construction and the results of proof-rolling operations. The root systems of all trees (not designated to remain) shall be removed in their entirety. Stripping materials shall not be incorporated into structural fills.
- TOPSOIL STRIPPING: Prior to the start of site grading, the contractor shall strip all topsoil from areas to be graded, and stockpiled at a location on or adjacent to the site as directed by the owner. At completion of grading operations and related construction, the contractor will be responsible for redistribution of topsoil over all areas disturbed by the construction activities. Topsoil shall be placed to a minimum depth of six inches (6") and in accordance with specifications for landscaping. At that time, and prior to the installation of landscaping or irrigation, all topsoil graded areas shall be visually inspected and accepted by the owner and ITL.
- Contractor shall adjust and/or cut existing pavement as necessary to assure a smooth fit and continuous grade. Contractor shall assure positive drainage away from buildings for all natural and paved areas.
- SUBGRADE PREPARATION: Prior to placement of new fill material, the existing subgrade shall be proofrolled and approved under the direction of the Geotechnical Engineer or his representative.
- PROOFROLLING: Subsequent to completion of stripping and over—excavation, all building and pavement areas to receive engineered fill should be systematically proof—rolled using a tandem axle dump truck loaded to approximately 20,000 pounds per axle. Also, any finished subgrade areas to receive paving shall be proof—rolled within 48 hours of paving. Unsuitable soils that are detected and that can not be recompacted should be over-excavated and replaced with controlled structural fill.
- EARTHWORK:
  - A) GEOTECHNICAL: All earthwork shall conform to the recommendations of the Geotechnical report. Said report and its recommendations are herein incorporated into the project requirements by reference. Prior to beginning construction, the contractor shall obtain a copy of and become familiar with the geotechnical report. Unless specifically noted on the plans, the recommendations in the geotechnical report are hereby incorporated into the project requirements and specifications.
  - B) SURFACE WATER: Surface water shall be intercepted and diverted during the placement of fill.
  - C) FILLS: All fills shall be considered controlled or structural fill and shall be free of vegetation, organic matter, topsoil and debris. In areas where the thickness of the engineered fill is greater than five, feet building and pavement construction should not commence until so authorized by the on-site geotechnical engineer to allow for consolidation.
  - D) BUILDING SUBGRADE: As specified in the Geotechnical Engineering Report, the upper 24 inches of building subgrade shall consist of Low Volume Change (LVC) material defined as approved, compacted granular fill or low to moderate plasticity cohesive soil materials stabilized with Class C Flyash. Granular fill shall consist of compacted granular materials with a maximum particle size of two (2) inches or less, such as limestone screenings. Refer to geotechnical report for complete requirements.
  - E) EXISTING SLOPES: Where fill material is to be placed on existing slopes greater—than 5:1 (horizontal to vertical), existing slope shall be benched providing a minimum vertical face of twelve inches (12"). The benches should be cut wide enough to accommodate the compaction equipment. Fill material shall be placed and compacted in horizontal lifts not exceeding nine inches (9") (loose lift measurement), unless otherwise approved by the Geotechnical Engineer.
  - F) COMPACTION REQUIREMENTS: The upper 9 inches of pavement subgrade areas shall be compacted to a minimum density of ninety five percent (95%) of the material's maximum dry density as determined by ASTM D698 (standard proctor compaction). The moisture content at the time of placement and compaction shall within a range of 0% below to 4% above optimum moisture content as defined by the standard proctor compaction procedure. The moisture contents shall be maintained within this range until completion of the work. Where compaction of earth fill by a large roller is impractical or undesirable, the earth fill shall be hand compacted with small vibrating rollers or
- All cut or fill slopes shall be 3:1 or flatter. All asphalt parking areas shall be a minimum of 1% slope but not more than 5% slope unless otherwise noted. All pavements within ADA parking areas shall not exceed 2% total slope. All grades around building shall be held down 6" from finish floor and slope away another 6" in 10 feet. Contractor shall notify engineer prior to final subgrade construction of any areas not within this slope requirement.
- TESTING AND INSPECTION: Owner's Independent Testing Laboratory (ITL) shall make tests of earthwork during construction and observe the placement of fills and other work performed on this project to verify that work has been completed in accordance with Geotechnical Engineering Report, Project Specifications and within industry standards. The ITL will be selected by the owner and the cost of testing will be the owner's responsibility.
- 11. CLASSIFICATION: All excavation shall be considered unclassified. No separate or additional payments shall be made for rock excavation.
- 12. RESTORATION: All disturbed areas not in building or pavements shall be sodded, unless shown otherwise by the landscaping plan or erosion
- 13. UTILITIES: The contractor is specifically cautioned that the location and/or elevation of existing utilities as shown on these plans is based on records of the various utility companies, and where possible, measurements taken in the field. The information is not to be relied on as being exact or complete. The contractor must call the appropriate utility companies at least 48 hours before any excavation to request exact field location of utilities. It shall be the responsibility of the contractor to relocate all existing utilities which conflict with the proposed improvements shown on the plans.

**LEGEND** 

2' CURB & GUTTER

EXISTING CONTOURS

PROPOSED CONTOURS

EXISTING STORM SEWER

PROPOSED STORM PIPE

PROPOSED RETAINING WALL

PROPOSED WET CURB & GUTTER

PROPOSED DRY CURB & GUTTER

PL PROPERTY LINE

- - LL - LOT LINE — −R/W− — RIGHT−OF−WAY

**− −**920**− −** 

— — 918 — —

14. LAND DISTURBANCE: The contractor shall adhere to all terms & conditions as outlined in the EPA or applicable state N.P.D.E.S. permit for storm water discharge associated with construction activities. Refer to project S.W.P.P.P. requirements.





435 & STATE LINE 1310 Carondelet Dr, Kansas City, MO 64114

Prepared for VanTrust Real Estate 4900 Main St. Ste 400, Kansas City, MO 64112 and

UMB Financial Corportation 1010 Grand Boulevard, Kansas City, MO 64106



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Retail Bank Landscape Architect 22 Debra Lane, New Windsor, New York 12553

Lankford Fendler Associates **Engineering Consultant** 

1730 Walnet St, Kansas City, MO 64108

Professional Seals

No. Description

### PDP SUBMITTAL **NOT FOR CONSTRUCTION**

<u>1 F</u>	PDP SUBMISSION	4.30.202
2 F	PDP RE-SUBMISSION	7.1.202
3 F	PDP RE-SUBMISSION	7.29.202
-		
Project No:	20.70060.00	

**OVERALL GRADING PLAN -**PHASE 2

Original is 36 x 24. Do not scale contents of this drawing

PEI #210040

Sheet Number

FIELD LOCATIONS OF UNDERGROUND UTILITIES CALL 811.

Know what's below.

Call before you dig.

#### UTILITY NOTES:

1. The contractor is specifically cautioned that the location and/or elevation of existing utilities as shown on these plans is based on records of the various utility companies, and where possible, measurements taken in the field. The information is not to be relied on as being exact or complete. The contractor must call the appropriate utility companies at least 48 hours before any excavation to request exact field location of utilities. It shall be the responsibility of the contractor to coordinate with and relocate &/or remove all existing utilities which conflict with the proposed improvements shown on the plans.

- 2. The construction of storm sewers on this project shall conform to the requirements of the City's Technical Specifications and Design Criteria.
- 3. The contractor shall field verify the exact location and elevation of the existing storm sewer lines and the existing elevation at locations where the proposed storm sewer collects or releases to existing ground. If discrepancies are encountered from the information shown on the plans, the contractor shall contact the design engineer. No pipes shall be laid until direction is received from the design engineer.
- 4. It will be the contractors responsibility to field adjust the top of all manholes and boxes as necessary to match the grade of the adjacent area. Tops of existing manholes shall be raised as necessary to be flush with proposed pavement elevations, and to be 6-inches above finished ground elevations in non-paved areas. No separate or additional compensation will be made to the contractor for making final adjustments to the
- 5. Inlet locations, horizontal pipe information and vertical pipe information is shown to the center of the structure. Deflection angles shown for storm sewer pipes are measured from the center of curb inlets and manholes. The contractor shall adjust the horizontal location of the pipes to go to the face of the boxes. All roof drains shall be connected to storm sewer structures. Provide cleanouts on roof drain lines at 100' max. Spacing and at all bend points. Do not connect roof drains directly to storm sewer pipe.
- 6. The contractor shall be responsible for furnishing and installing all fire and domestic water lines, meters, backflow devices, pits, valves and all other incidentals required for a complete operable fire protection and domestic water system. All costs associated with the complete water system for the buildings shall be the responsibility of the contractor. All work shall conform to the requirements of City.
- 7. The contractor shall be responsible for furnishing and installing all sanitary sewer service lines from the buildings to the public line. All work shall conform to the requirements of the City.
- 8. The contractor will be responsible for securing all permits, bonds and insurance required by the contract documents, City, and all other governing agencies (including local, county, state and federal authorities) having jurisdiction over the work proposed by these construction documents. The cost for all permits bonds and insurance shall be the contractors responsibility and shall be included in the bid for the work.

10. The Contractor shall be responsible for furnishing all materials, tools and equipment and installation of electrical power, telephone and gas service

- 9. By the use of these construction documents the contractor hereby agrees that he/she shall be solely responsible for the safety of the construction workers and the public. The contractor agrees to hold the engineer and owner harmless for any and all injuries, claims, losses or damages related
- from a point of connection from the public utility lines to the building structures. This will include all conduits, service lines, meters, concrete pads and all other incidentals required for a complete and operational system as required by the owner and the public utilities. Refer to building plans for exact tie-in locations of all utilities. Contractor shall verify connection points prior to installation of utility line.
- 11. All fill material is to be in place, compacted, and consolidated before installation of proposed utilities. On-site geotechnical engineer shall provide written confirmation that this requirement has been met and that utilities may proceed in the fill areas. All utilities are to be placed in trench
- 12. Contractor shall notify the utility authorities inspectors 48 hours before connecting to any existing line.
- 13. Water lines shall be as follows (unless otherwise shown on plans):
- Pipe sizes less than 3-inches that are installed below grade and outside building shall comply with the following: 1. Seamless Copper Tubing: Type "K" soft copper, ASTM B88. 2. Fittings: Wrought copper (95\_5 Tin Antimony solder joint), ASME B 16.22.
- 15. Contractor shall maintain a minimum of 42" cover on all waterlines. All water line joints are to be mechanical joints with thrust blocking as called out in specifications and construction plans. Water mains and service lines shall be constructed in accordance to City's specifications for
- 16. All waterlines shall be kept min. ten (10') apart (parallel) from sanitary sewer lines or manholes. Or when crossing, an 24" vertical clearance (outside edge of pipe to outside edge of pipe) of the water line above the sewer line is required.
- 17. Sanitary conflicts will be resolved prior to permit issuance.
- 18. All underground storm, sanitary, water and other utility lines shall be installed, inspected and approved before backfilling. Failure to have inspection approval prior to backfill will constitute rejection of work.
- 19. All necessary inspections and/or certifications required by codes and/or utility service companies shall be performed prior to announced building possession and the final connection of service. Contractor shall coordinate with all utility companies for installation requirements and specifications.
- 20. Refer to building plans for site lighting electrical plan, irrigation, parking lot security system and associated conduit requirements. Coordinate with Owner that all required conduits are in place & tested prior to paving.
- 21. When a building utility connection from site utilities leading up to the building cannot be made immediately, temporarily mark all such site utility

CITY OF KANSAS CITY

414 E. 12TH STREET

PUBLIC WORKS DEPARTMENT

CITY OF KANSAS CITY (GENERAL NUMBER)

AMY BUNNELL (LAND DEVELOPMENT DIVISION) (816) 513-2552

KANSAS CITY, MO. 64106

CARLA HASKINS (WATER)

EMAIL: carla.haskins@kcmo.org

EMAIL: amy.bunnell@kcmo.org 4800 E. 63RD STREET

KANSAS CITY, MO. 64130

KANSAS CITY, MO. 64155

TIME WARNER CABLE

15 NW BARRY ROAD


22. Refer to the building plans for site lighting electrical requirements, including conduits, pole bases, pull boxes, etc.



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Lankford Fendler Associates

**Engineering Consultant** 

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Professional Seals
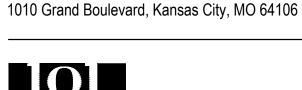
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(816) 513-1313

(816) 513-2133

(816) 358-8833

PEI #210040

## PDP SUBMITTAL **NOT FOR CONSTRUCTION**

No.	Description	Date
1	PDP SUBMISSION	4.30.2021
2	PDP RE-SUBMISSION	7.1.2021
3	PDP RE-SUBMISSION	7.29.2021

Project No: 20.70060.00

**UTILITY PLAN -**PHASE 2

Original is 36 x 24. Do not scale contents of this drawing. Sheet Number

**UTILITY COMPANIES:** SPIRE ENERGY

**BEVERLY PASSANTINO** 7500 E. 35TH TERRACE KANSAS CITY, MO. 64129 EMAIL: beverly.passantino@spireenergy.com

**EVERGY** MELISSA FELTES 8325 N. PLATTE PURCHASE DRIVE KANSAS CITY, MO. 64118 E-MAIL: Melissa.Feltes@kcpl.com

AT&T JILL SCHROEDER 9556 N. MCGEE COURT KANSAS CITY, MO 64155 EMAIL: jb0311@att.com

(816) 734-8700

(816) 472-3434

(816) 420-4721

**LEGEND** PL PROPERTY LINE - - LL - LOT LINE — −R/W− — RIGHT−0F−WAY EXISTING CABLE TELEVISION LINE EXISTING FIBER OPTIC LINE EXISTING GAS LINE EXISTING BURIED ELECTRIC LINE EXISTING OVERHEAD POWER LINE EXISTING OVERHEAD TELEPHONE LINE EXISTING SANITARY SEWER LINE 24"HDPE EXISTING STORM SEWER LINE (& SIZE) BT———BT———— EXISTING BURIED TELEPHONE LINE


————w——6"— EXISTING WATER LINE (& SIZE) PROPOSED BURIED ELECTRIC LINE ----- SS ----- PROPOSED SANITARY SEWER LINE PROPOSED STORM SEWER LINE (& SIZE)

N1/2103RD STREET CARONDELET DRIVE

99TH STREET

VICINITY MAP FRAC. SEC. 31-48-33



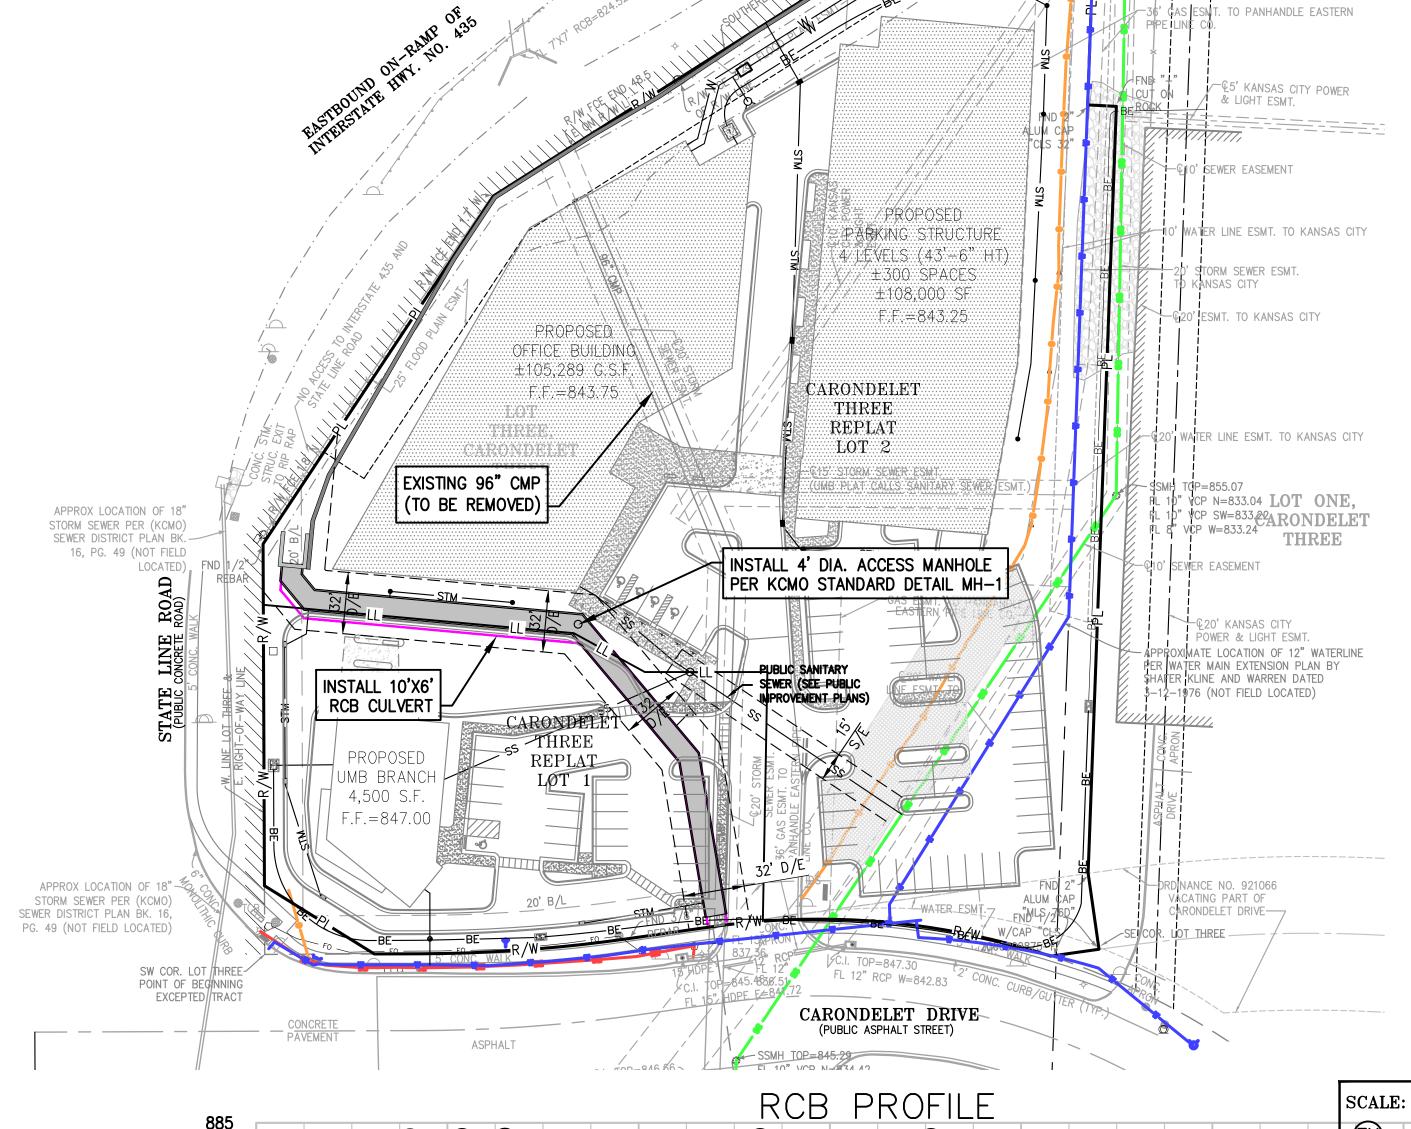

995	RCB PROFILE	SCALE	: 1"=50' HORIZ. 1"=10' VER85
885	<ul><li>Ф</li><li>Ф</li><li>Ф</li><li>Ф</li></ul>	<b>(</b>	1 -10 (F1983)
880		N S	880
875	RCB PROFILE  RCB PROFILE  A 5' BEND  SO' BEND  SO' BEND  A 5' BEND  A 5' BEND  A 5' BEND  SO' BE	PROFILE 45 BEND	875
870		Ä.	870
865		4+81.39	865
860	STA. 0+0  HEADWALL  STA. 0+0  HEADWALL  STA. 0+07.8  STA. 3+36.7  CMO STANDA  CONNECT	STA.	860
855	$ \begin{array}{c ccccccccccccccccccccccccccccccccccc$		855
850	FL=841.30 FL=841.30 6" SERVICE LINE		850
845			845
840	100-YEAR HGL		840
835			835
830	EX.		830
825			825
820	10'X6' RCB 83.83 L.F. 0'X6' RCB 10'X6' RCB		820
815			815
810	10'X6' RCB \_89.83 L.F. \\ © 1.35% \ 10'X6' RCB \\ 0 1.35%		810
805			805
800	8 8 0 1.35%		800
795		2	795
790	832.56 (2 (2 (2 (2 (2 (2 (2 (2 (2 (2 (2 (2 (2	5.41 (N)	790
785	3 8 8 $ 3 8$	\$2 5+	785





Project
435 & STATE LINE
1310 Carondelet Dr, Kansas City, MO 64114

Prepared for
VanTrust Real Estate
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and

UMB Financial Corportation 1010 Grand Boulevard, Kansas City, MO 64106



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Lankford Fendler Associates

Engineering Consultant 1730 Walnet St, Kansas City, MO 64108

\_\_\_\_\_

Watershed Analysis

EXISTING 96" CMP CAPACITY=680 CFS PROPOSED 10'X6' RCB CAPACITY=1,212 CFS

Storm Event

Total Area (A.C.)

Slope

Time of Conc. (min)
Intensity (in/hr)
% Impervious

Q (CFS)

Length

25-YR 100-YR 240 240

4,340

30%

0.48

1.88% 1.88%

680 953

Professional Seals

# PDP SUBMITTAL NOT FOR CONSTRUCTION

1	PDP SUBMISSION	4.30.2021
2	PDP RE-SUBMISSION	7.1.2021
3	PDP RE-SUBMISSION	7.29.2021

Project No: 20.70060.00

STORM SEWER PLAN & PROFILE

Original is 36 x 24. Do not scale contents of this drawing.

Sheet Number

PEI #210040

**C**3

SCALE: 1"=20' HORIZ. 1"=20' VERT.

SCALE: 1"=20' HORIZ. 1"=20' VERT.

890

870

850

840

835

830

825

820

815

810

805

800


795

790

785

780

775

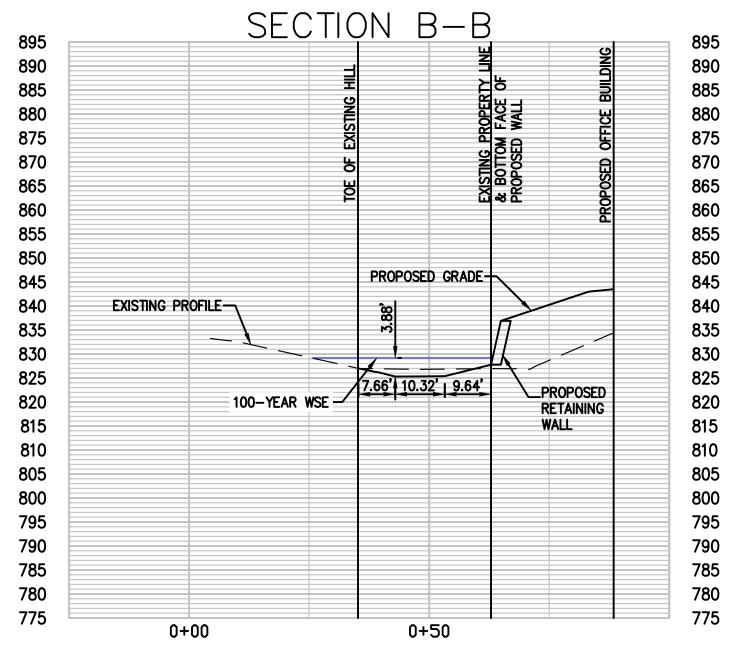

SECTION A-A

PROPOSED GRADE-

0+50

\_\_PROPOSED

RETAINING

890

885

880

875 870

865 860

855

850

845

840

835

830

825

820

810

805

800

795

790


785

780

775

EXISTING PROFILE—

0+00

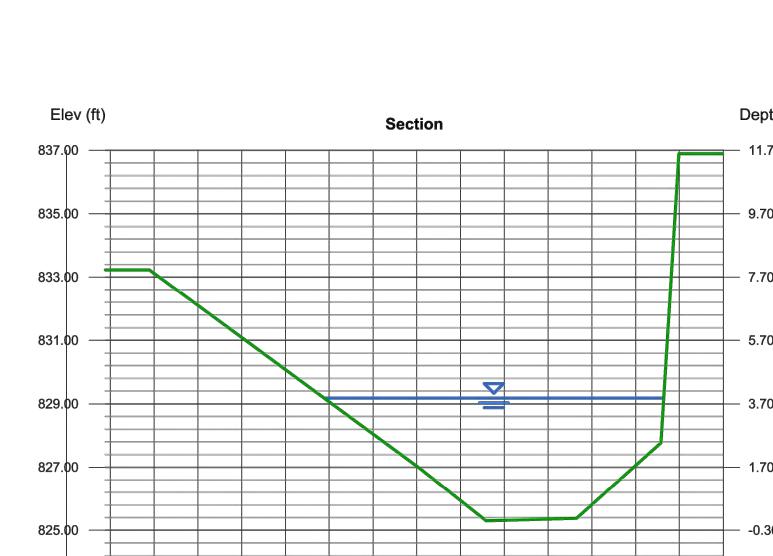


#### **Channel Report**

Hydraflow Express Extension for Autodesk® Civil 3D® by Autodesk, Inc.

Swale Secton A-A			
User-defined		Highlighted	
Invert Elev (ft)	= 827.28	Depth (ft)	= 3.81
Slope (%)	= 1.20	Q (cfs)	= 1,190
N-Value	= 0.025	Area (sqft)	= 105.18
		Velocity (ft/s)	= 11.31
Calculations		Wetted Perim (ft)	= 45.72
Compute by:	Known Q	Crit Depth, Yc (ft)	= 4.27
Known Q (cfs)	= 953.00	Top Width (ft)	= 42.59

EGL (ft) = 5.80 (Sta, El, n)-(Sta, El, n)... (6.07, 834.37)-(16.70, 830.89, 0.025)-(45.88, 827.28, 0.025)-(56.55, 827.34, 0.025)-(57.86, 827.50, 0.025)-(59.88, 836.34, 0.025)

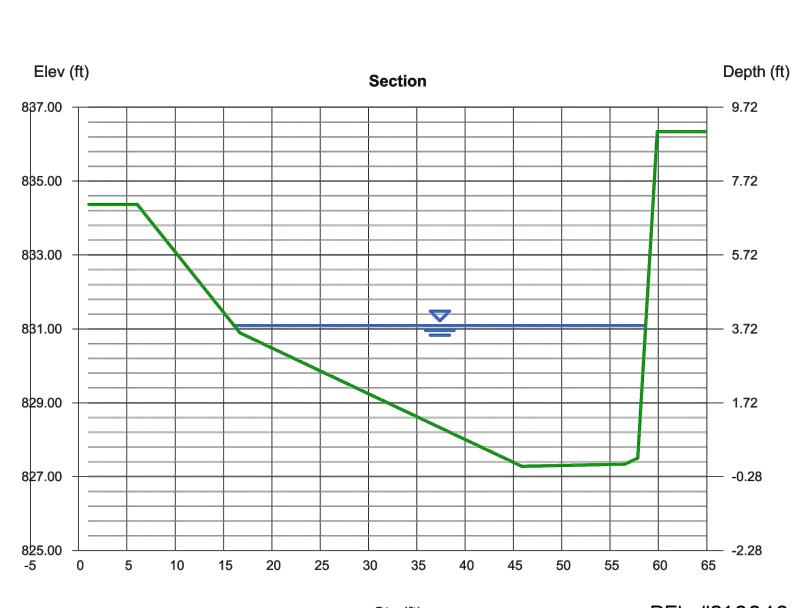




Hydraflow Express Extension for Autodesk® Civil 3D® by Autodesk, Inc.


Swale Secton B-B

Highlighted Depth (ft) **User-defined** = 825.30 = 3.88 Invert Elev (ft) = 1,190 = 1.20 Q (cfs) Slope (%) N-Value = 0.025Area (sqft) = 100.19 Velocity (ft/s) Wetted Perim (ft) = 11.88 = 40.61 **Calculations** Compute by: Known Q Crit Depth, Yc (ft) = 4.44 = 953.00 Top Width (ft) = 38.79 Known Q (cfs) EGL (ft) = 6.07

(Sta, El, n)-(Sta, El, n)... (4.44, 833.23)-(35.27, 826.98, 0.025)-(42.93, 825.30, 0.025)-(53.25, 825.38, 0.025)-(62.89, 827.77, 0.025)-(64.93, 836.89, 0.025)

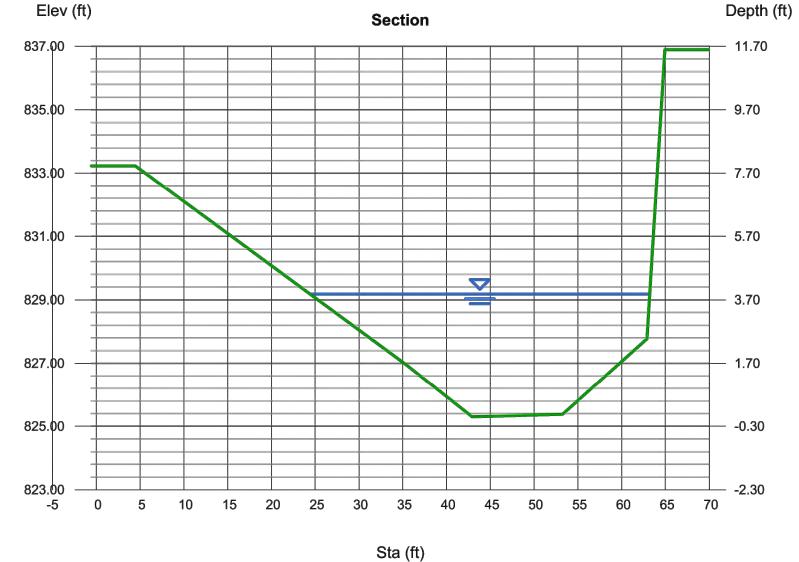

Swale Secton A-A				
	Highlighted			
= 827.28	Depth (ft)	= 3.81		
= 1.20	Q (cfs)	= 1,190		
= 0.025	Area (sqft)	= 105.18		
	Velocity (ft/s)	= 11.31		
	Wetted Perim (ft)	= 45.72		
Known Q	Crit Depth, Yc (ft)	= 4.27		
= 953.00	Top Width (ft)	= 42.59		
	= 827.28 = 1.20 = 0.025	### Highlighted  = 827.28		

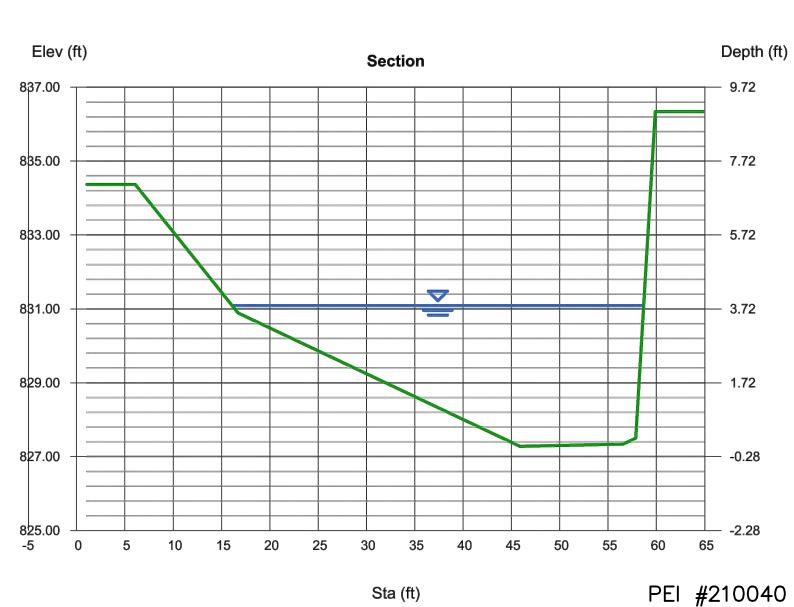



Thursday, Apr 1 2021



Project 435 & STATE LINE 1310 Carondelet Dr, Kansas City, MO 64114

Prepared for VanTrust Real Estate 4900 Main St. Ste 400, Kansas City, MO 64112 and

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Thursday, Apr 1 2021


## PDP SUBMITTAL **NOT FOR** CONSTRUCTION


F	DP SUBMISSION	4.30.2021
F	DP RE-SUBMISSION	7.1.2021
	DP RE-SUBMISSION	7.29.2021
	00 70000 00	
ect No:	20 70060 00	

**STORM SEWER SECTIONS** 

Original is 36 x 24. Do not scale contents of this drawing. Sheet Number

C3.1

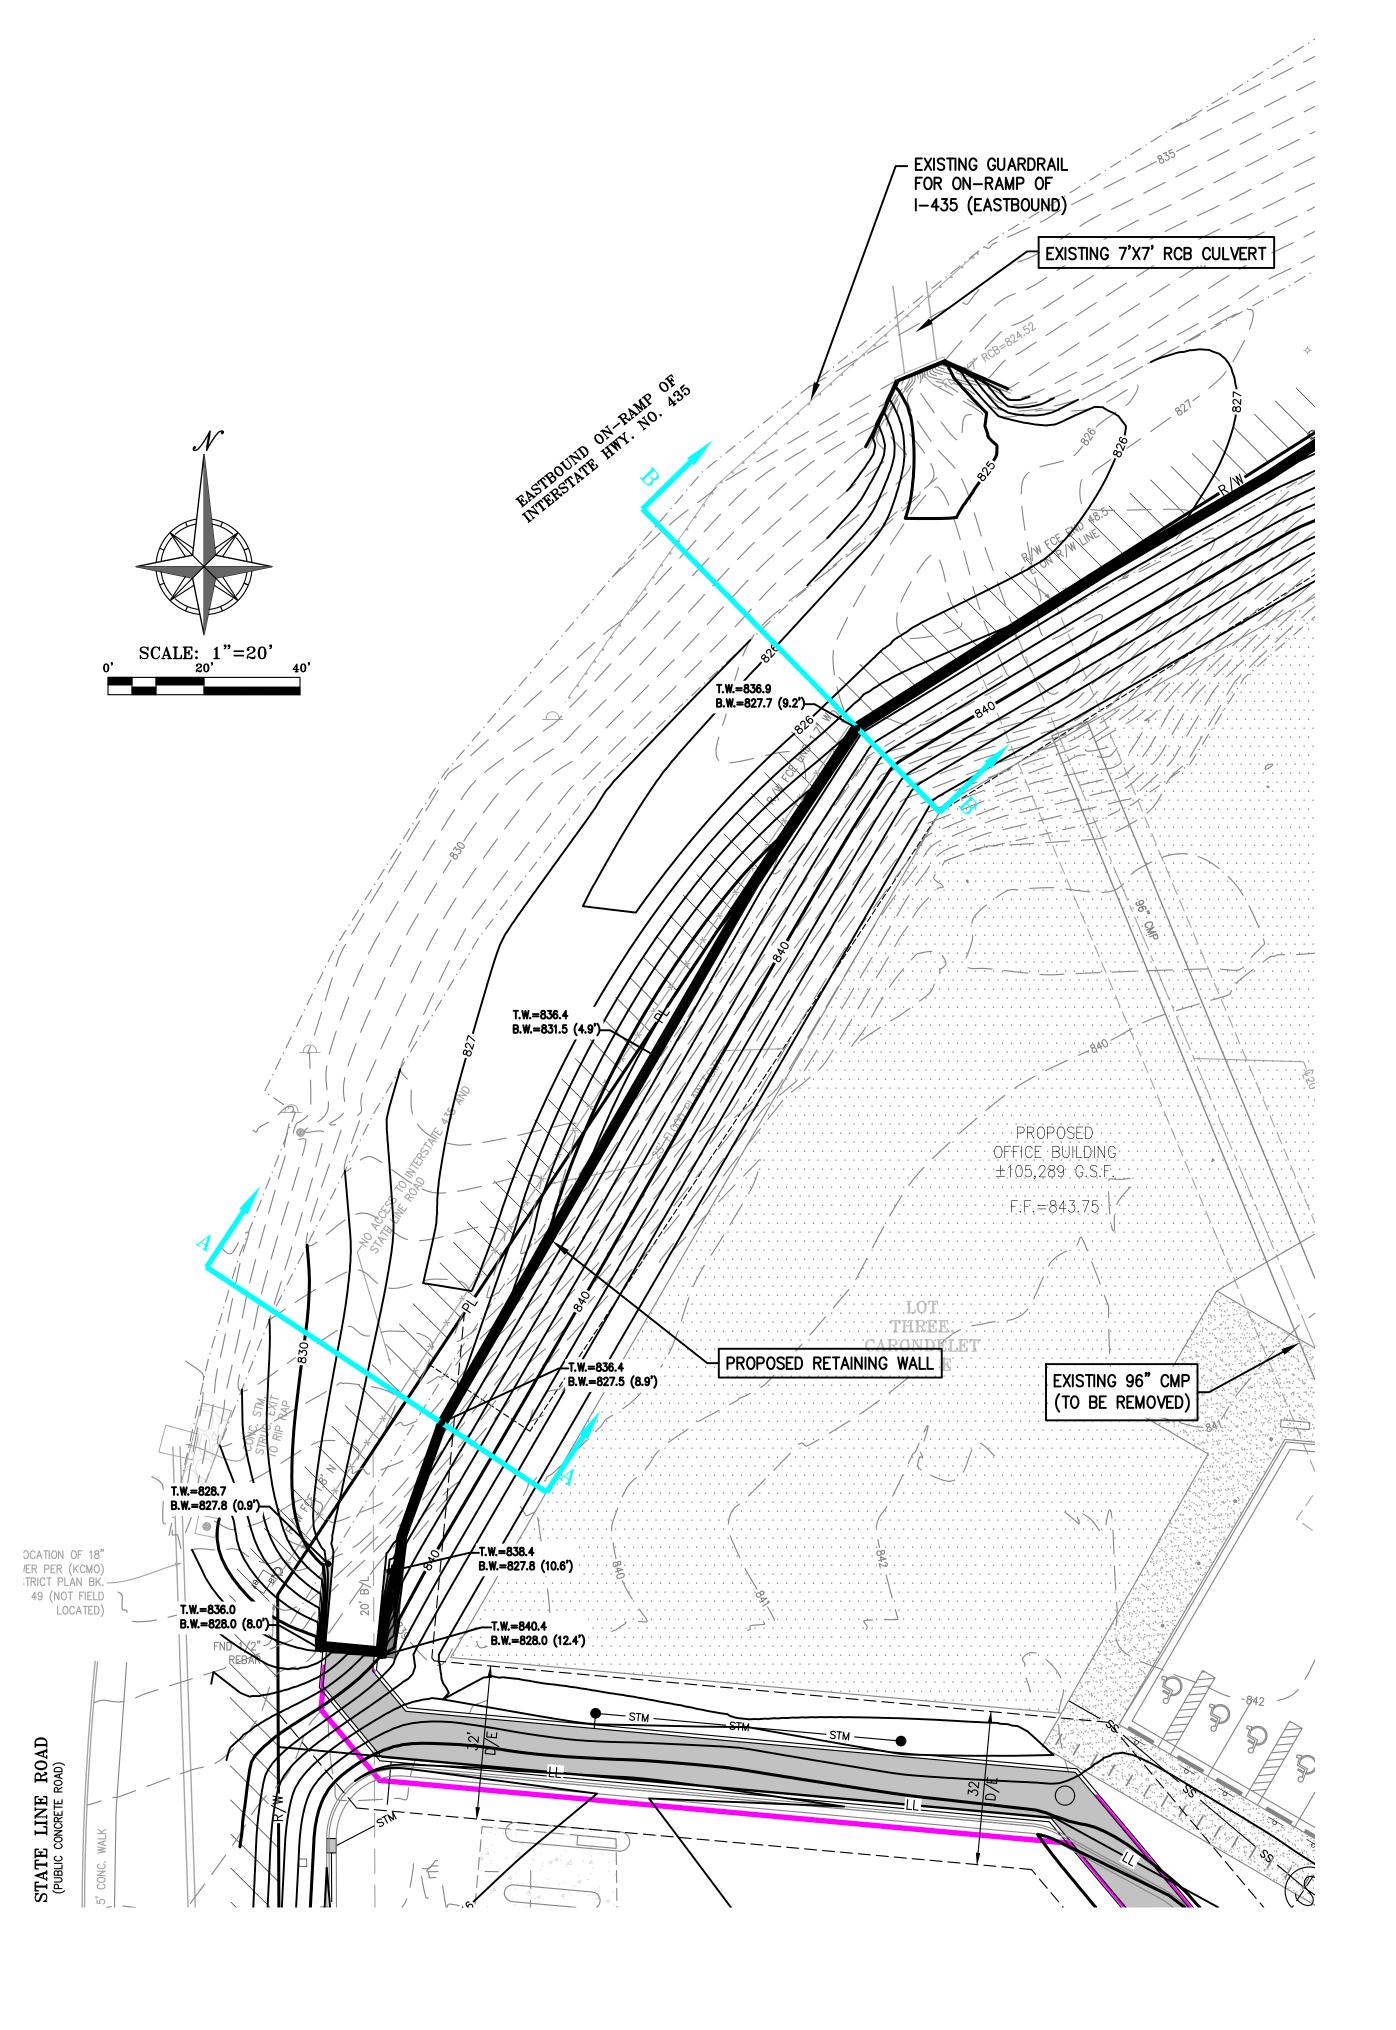

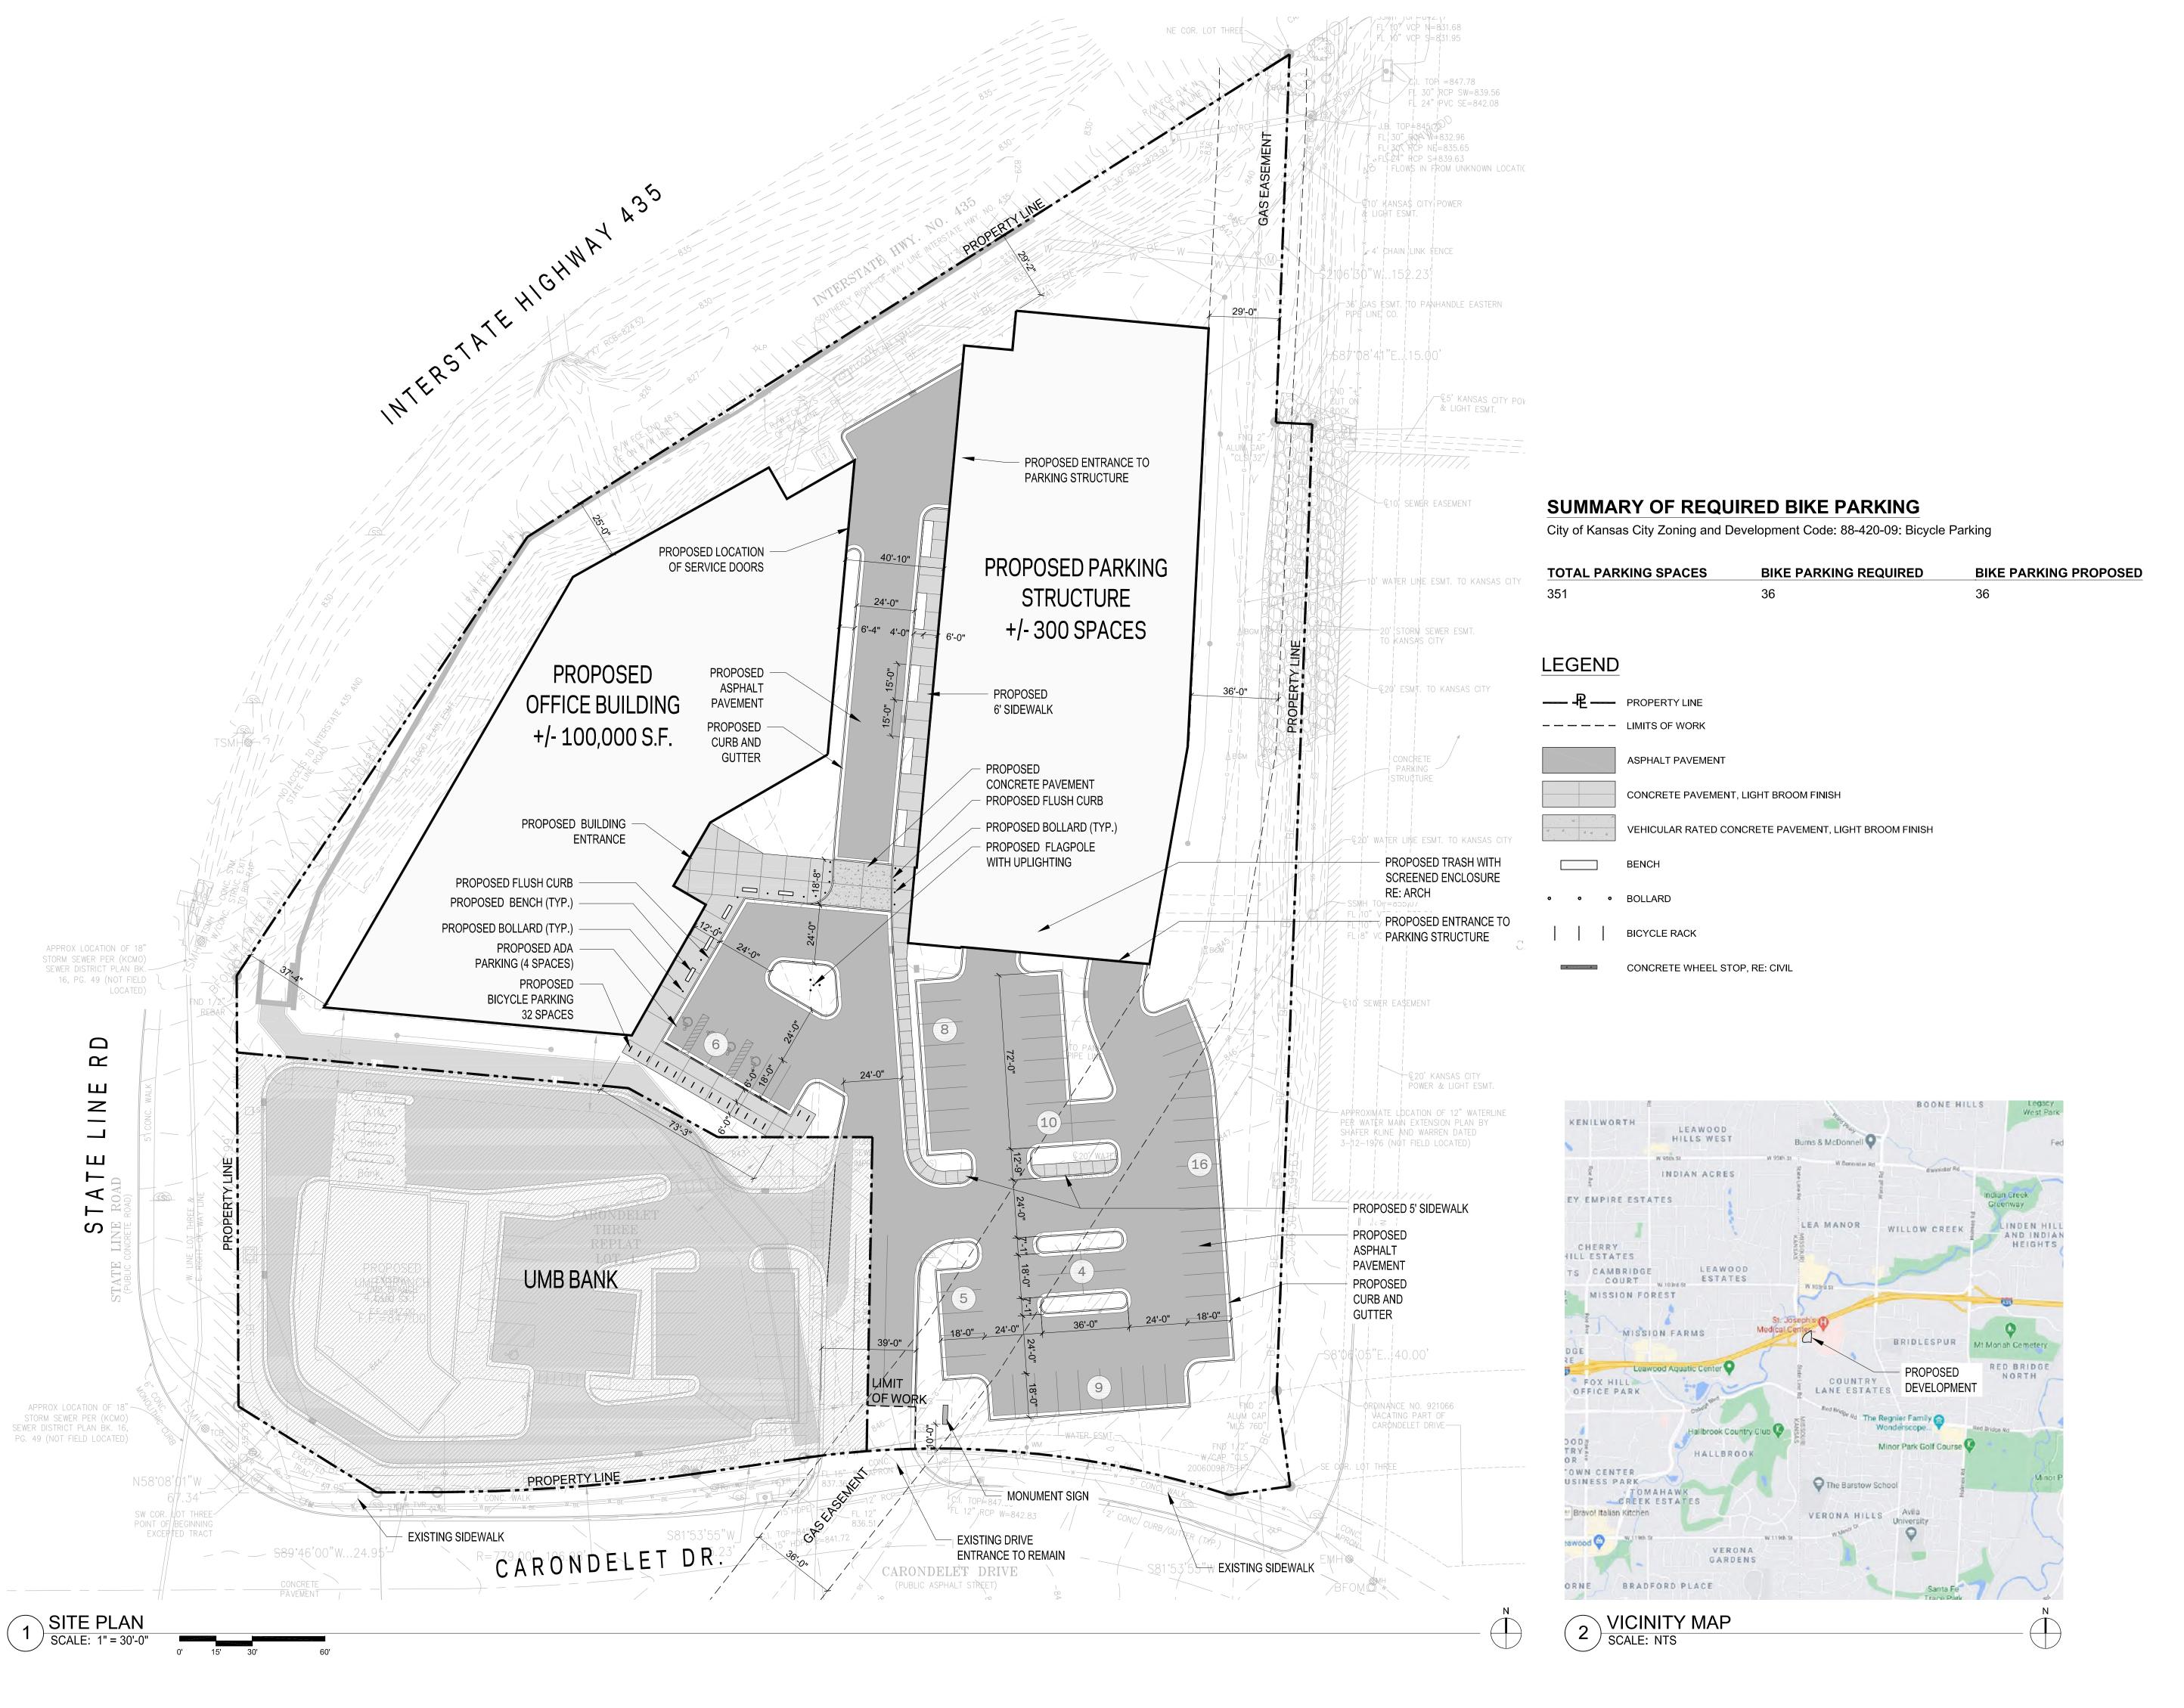





Project
435 & STATE LINE
1310 Carondelet Dr, Kansas City, MO 64114

Prepared for

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4900 Main St. Ste 400, Kansas City, MO 64112

and

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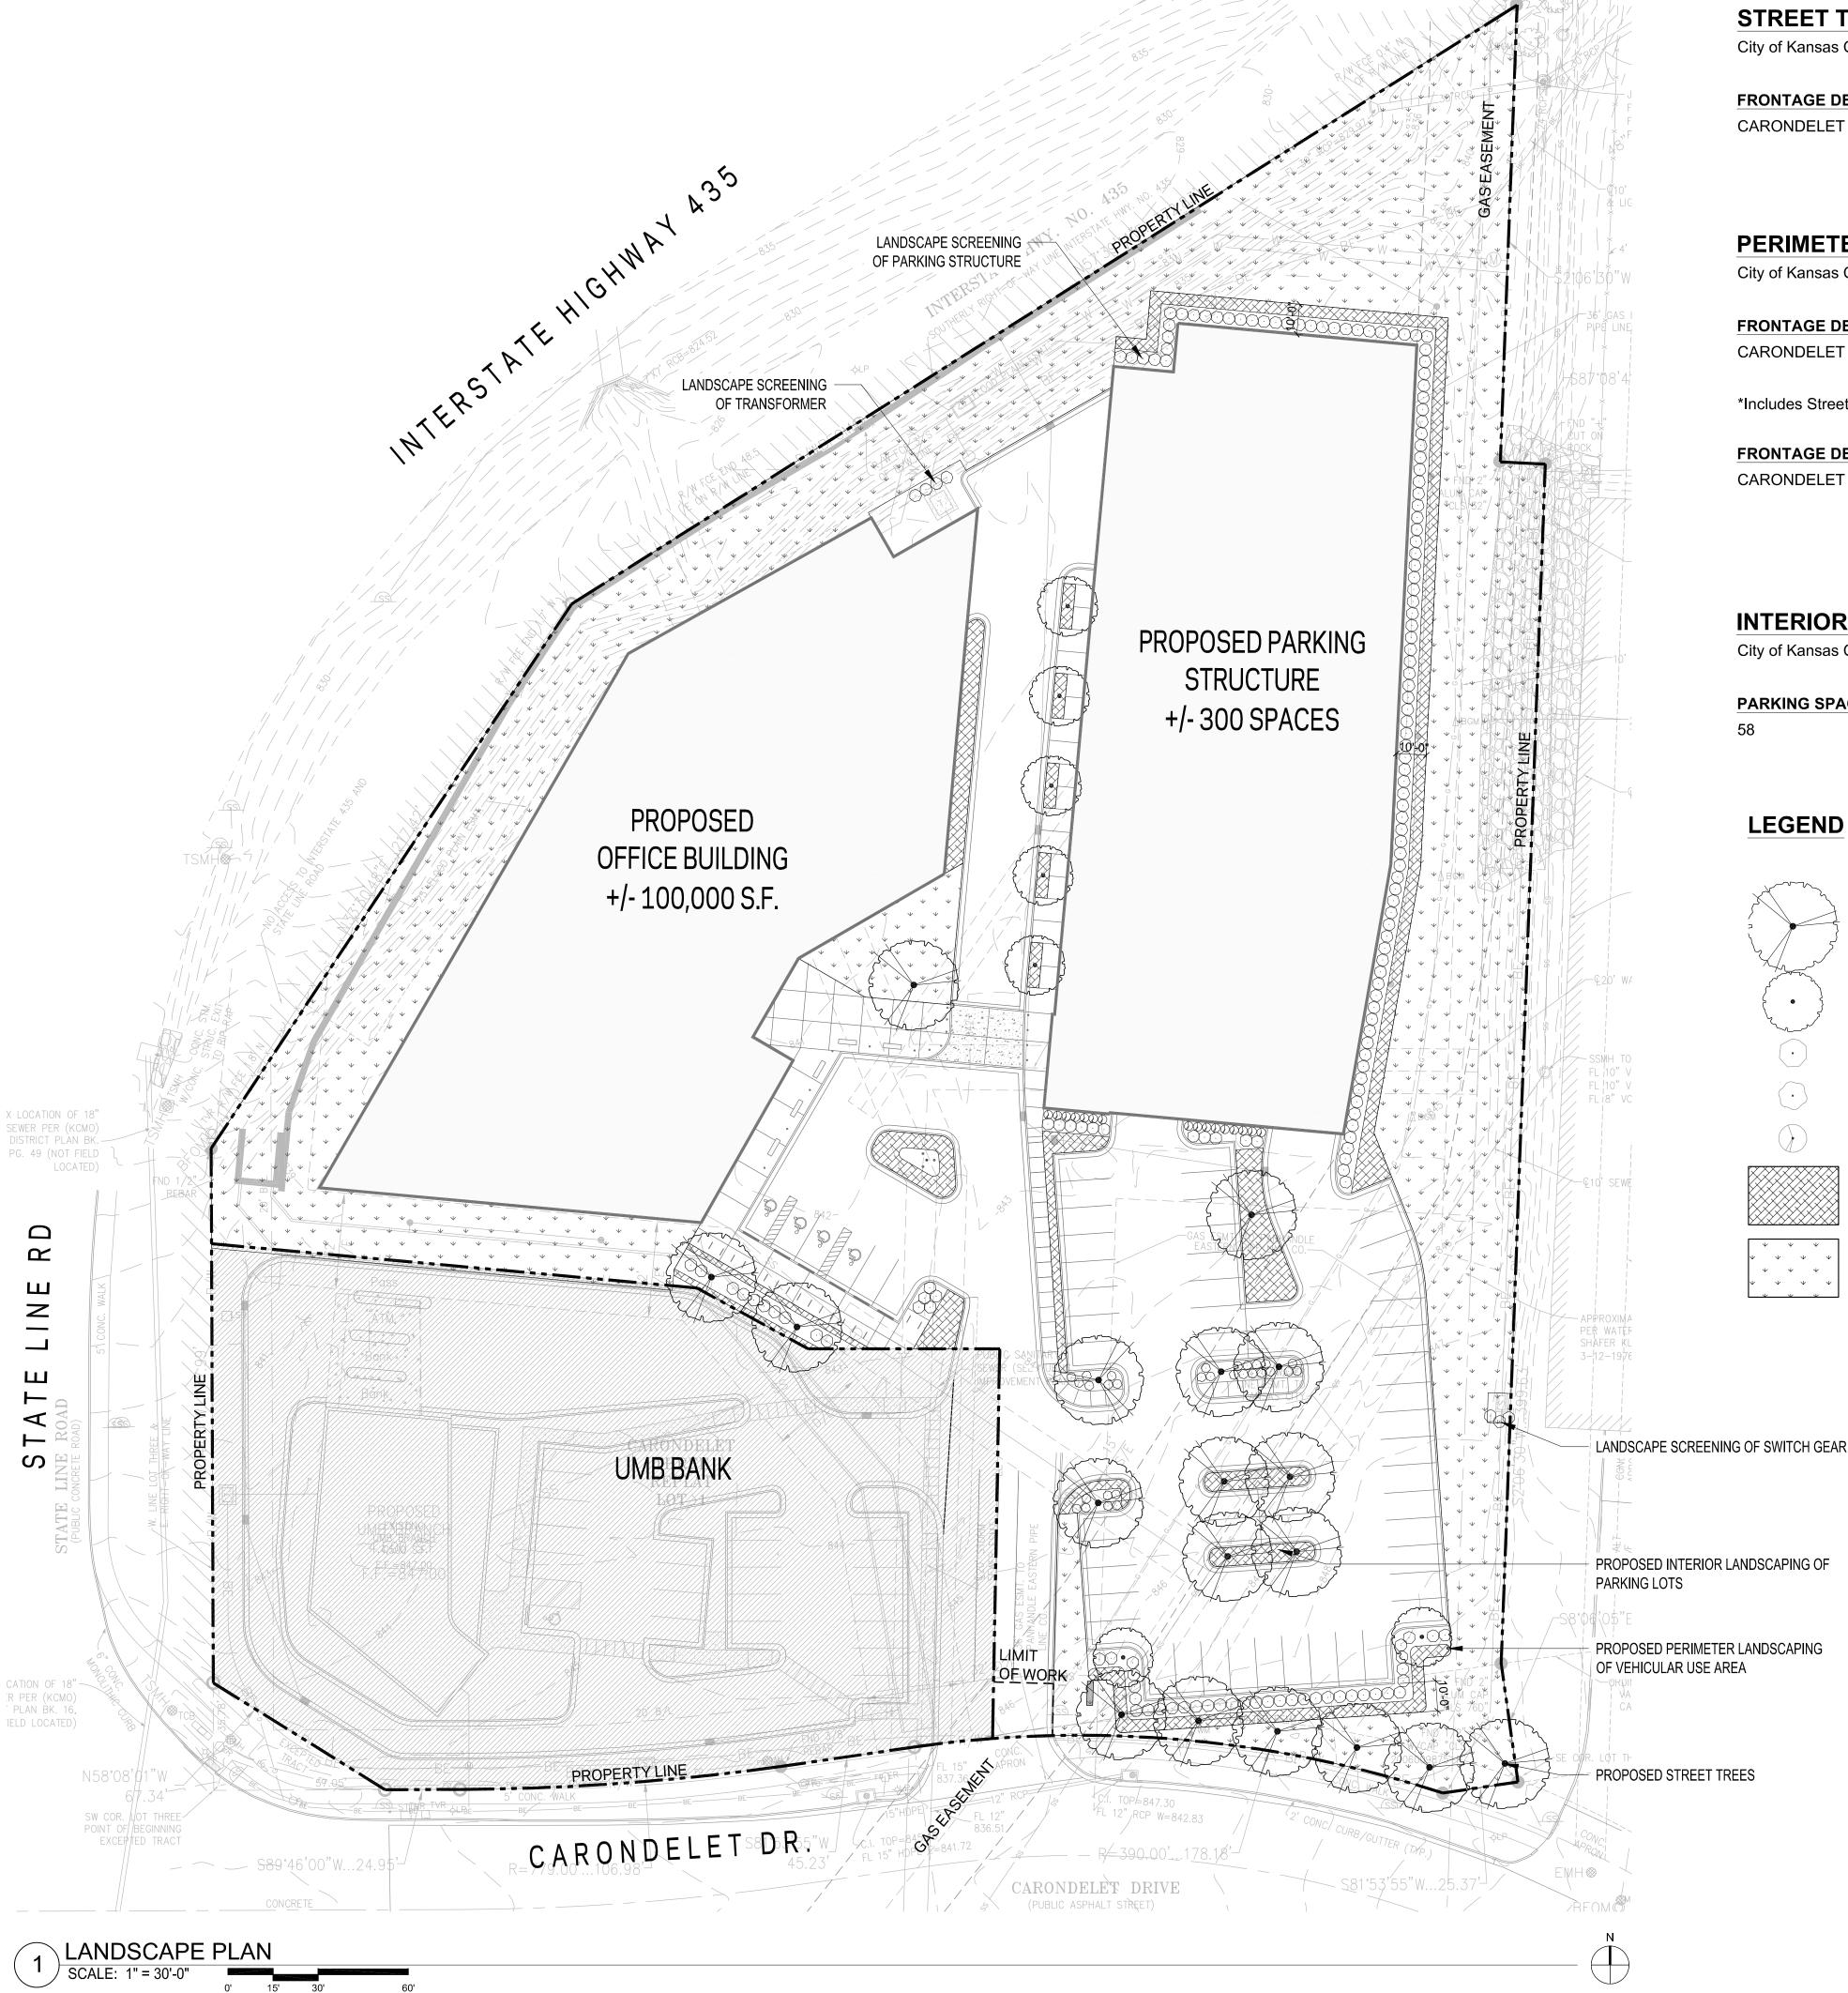
# NOT FOR CONSTRUCTION

No.	Description	Date
	PDP SUBMISSION	4,30,2021
2	PDP RESUBMITTAL	7.1.2021
roject No:	20.70060.00	
Sheet Title:		
	E PLAN	
OI I		

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Sheet Number

L-100



#### STREET TREE PLANTING SUMMARY

City of Kansas City Zoning and Development Code: 88-425-03: Street Trees

FRONTAGE DESCRIPTIONLOT FRONTAGE (LF)TREES REQUIREDPROPOSEDCARONDELET DR.17666

#### PERIMETER LANDSCAPING OF VEHICULAR USE AREAS SUMMARY

City of Kansas City Zoning and Development Code: 88-425-05: Perimeter Landscaping of Vehicular Use Areas

FRONTAGE DESCRIPTION	FRONTAGE (LF)	TREES REQUIRED	PROPOSED
CARONDELET DR.	120	4	4*

\*Includes Street Trees Applied Toward Perimeter Landscaping Requirement

FRONTAGE DESCRIPTION	LANDSCAPE REQUIRED	LANDSCAPE PROPOSED
CARONDELET DR.	Evergreen Shrubs: Continuous Row 3' Tall	Evergreen Shrubs: Continuous Row 3' Tall
	Min 10' Bed Groundcover	10' Bed Groundcover

#### INTERIOR LANDSCAPING OF PARKING LOTS SUMMARY

City of Kansas City Zoning and Development Code: 88-425-06: Interior Landscaping of Parking Lots

PARKING SPACES	TREES REQUIRED	PROPOSED	SHRUBS REQUIRED	SHRUBS PRPOSED
59	10	12	50	71

LEGEND		CONCEPTUAL PLANT PALETTE				
			BOTANICAL NAME	COMMON NAME		
	MEDIUM SHADE TREE	SHADE TREES	ACER SACCHARUM 'BALISTA' GINKGO BILOBA 'AUTUMN GOLD' QUERCUS RUBRA ULMUS X 'FRONTIER'	FALL FIESTA SUGAR MAPL MAIDENHAIR TREE RED OAK AMERICAN ELM		
	SMALL SHADE TREE	ORNAMENTAL TREES	CERCIS CANADENSIS CORNUS FLORIDA 'KOUSA' MAGNOLIA VIRGINIANA	EASTERN REDBUD KOUSA DOGWOOD SWEETBAY MAGNOLIA		
•	EVERGREEN SHRUB					
$\bigcirc$	DECIDUOUS SHRUB	DECIDUOUS SHRUBS	ITEA VIRGINICA 'HENRY'S GARNET' PHYSOCARPUS OPULIFOLIUS 'SUMMERWINE' SPIRAEA JAPONICA 'LITTLE PRINCESS'	HENRY'S GARNET SWEETS SUMMER WINE NINEBARI LITTLE PRINCESS SPIREA		
	ORNAMENTAL GRASS	EVERGREEN SHRUBS	BUXUS MICROPHYLLA 'WINTERGREEN' JUNIPERUS PFITZERIANA 'SEA GREEN'	WINTERGREEN BOXWOOL		
	GROUNDCOVER	ORNAMENTAL GRASSES	CALAMAGROSTIS ACUTIFLORA 'KARL FOERSTER' PANICUM VIRGATUM 'HEAVY METAL' SCHIZACHYRIUM SCOPARIUM 'THE BLUES'	FEATHER REED GRASS SWITCHGRASS LITTLE BLUESTEM		
\tau \tau \tau \tau \tau \tau \tau \tau	TURF SOD	GROUNDCOVER	EUONYMUS FORTUNEI 'COLORATUS' LIRIOPE MUSCARI VINCA MINOR	WINTERCREEPER BIG BLUE LILYTURF PERIWINKLE		





Project
435 & STATE LINE
1310 Carondelet Dr, Kansas City, MO 64114

Prepared for
VanTrust Real Estate
4900 Main St. Ste 400, Kansas City, MO 64112

UMB Financial Corportation 1010 Grand Boulevard, Kansas City, MO 64106



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## GastingerWalker 6

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Oppermann LandDesign LLC

Retail Bank Landscape Architect
22 Debra Lane, New Windsor, New York 12553

Lankford Fendler Associates

Engineering Consultant 1730 Walnet St, Kansas City, MO 64108

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No Description

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1	PDP SUBMISSION	4.30.20
2	PDP RESUBMITTAL	
-		
-		

OFFICE LANDSCAPE PLAN

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Sheet Number

L-101





435 & STATE LINE 1310 Carondelet Dr, Kansas City, MO 64114 B & B 2"Cal

CONT CAL

B & B 1.5"Cal

B & B

CONT

5 gal

5 gal

5 gal

3 gal

CONT

3 gal

3 gal

BOTANICAL / COMMON NAME

**BOTANICAL / COMMON NAME** 

Male Only

18"-24" hgt. & sp.

24"-30" sp. & hgt.

24"-30" hgt. & sp.

24"-30" sp.

18"-24" sp.

18"-24" hgt.

18"-24" hgt.

18"-24" hgt.

18"-24" sp.

394 ft. of road frontage divided by 30 equals 13 trees. 13 trees provided.

Street Tree Requirements:

BOTANICAL / COMMON NAME

BOTANICAL / COMMON NAME

Acer saccharum 'Bailsta' TM / Fall Fiesta Sugar Maple

Cercis canadensis `Oklahoma` / Oklahoma Redbud

Buxus microphylla `Wintergreen` / Korean Boxwood

Juniperus virginiana `Grey Owl` / Grey Owl Juniper

Juniperus x pfitzeriana `Sea Green` / Sea Green Juniper

Rhus aromatica `Gro-Low` / Gro-Low Fragrant Sumac

Spiraea x bumalda `Gold Flame` / Gold Flame Spirea

Ceratostigma plumbaginoides `Blue Plumbago` / Blue Plumbago

Calamagrostis acutiflora `Karl Foerster` / Feather Reed Grass

Miscanthus sinensis `Morning Light` / Eulalia Grass

Physocarpus opulifolius `Seward` TM / Summer Wine Ninebark

Spiraea x bumalda `Anthony Waterer` / Anthony Waterer Spiraea 3 gal

Quercus robur x alba `Crimschmidt` TM / Crimson Spire Oak

Ginkgo biloba `Autumn Gold` TM / Autumn Gold Maidenhair Tree B & B 2" cal.

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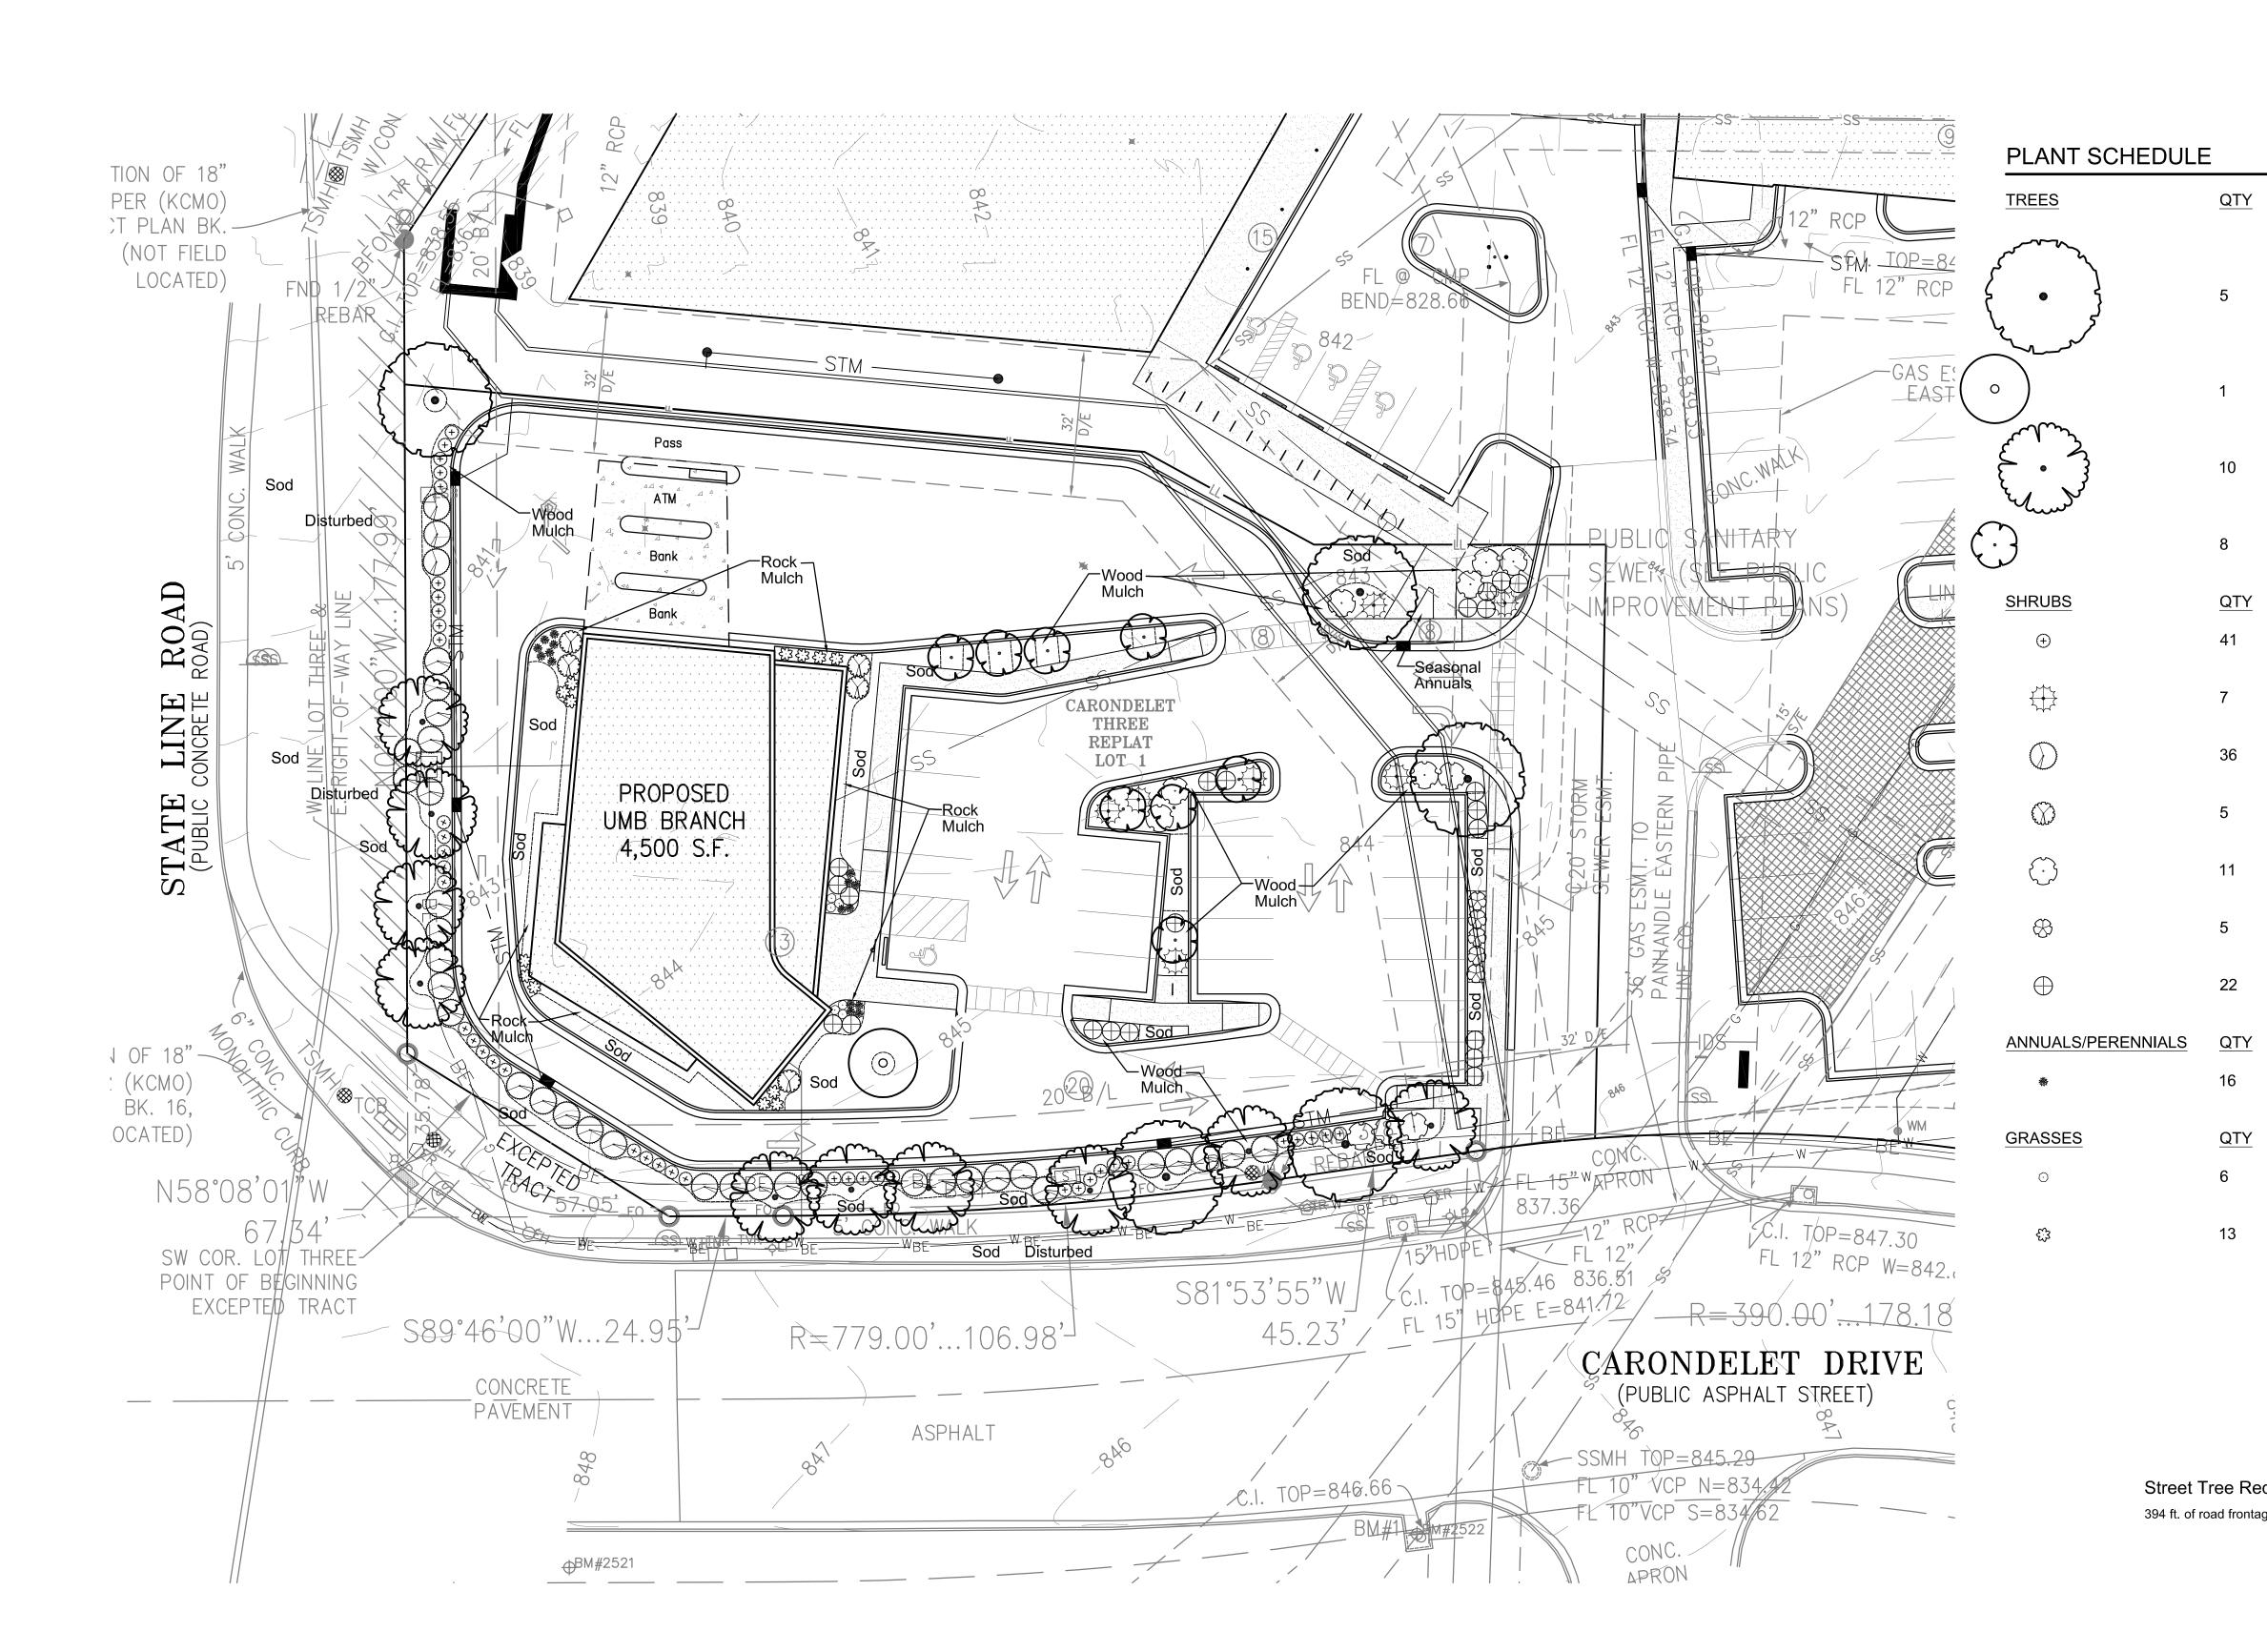
No.	Description	Da
1	PDP RESUBMITTAL	7.1.2
Project No:	20.70060.00	
Sheet Title:		

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BANK LANDSCAPE PLAN


L-102







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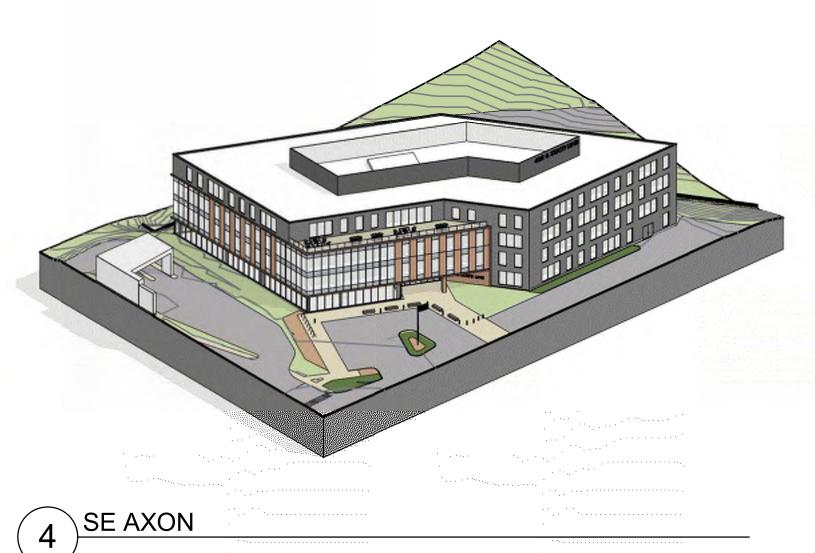





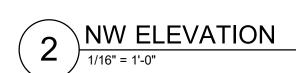

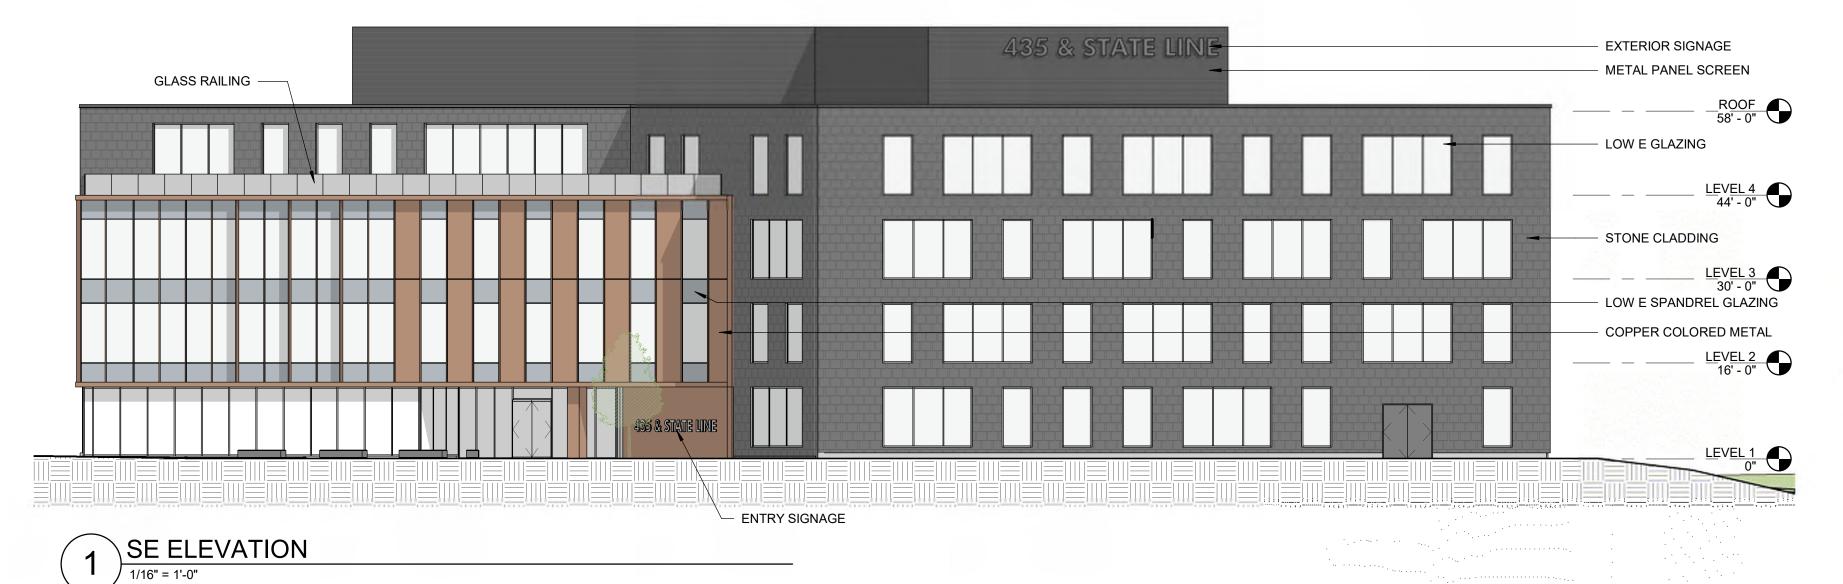



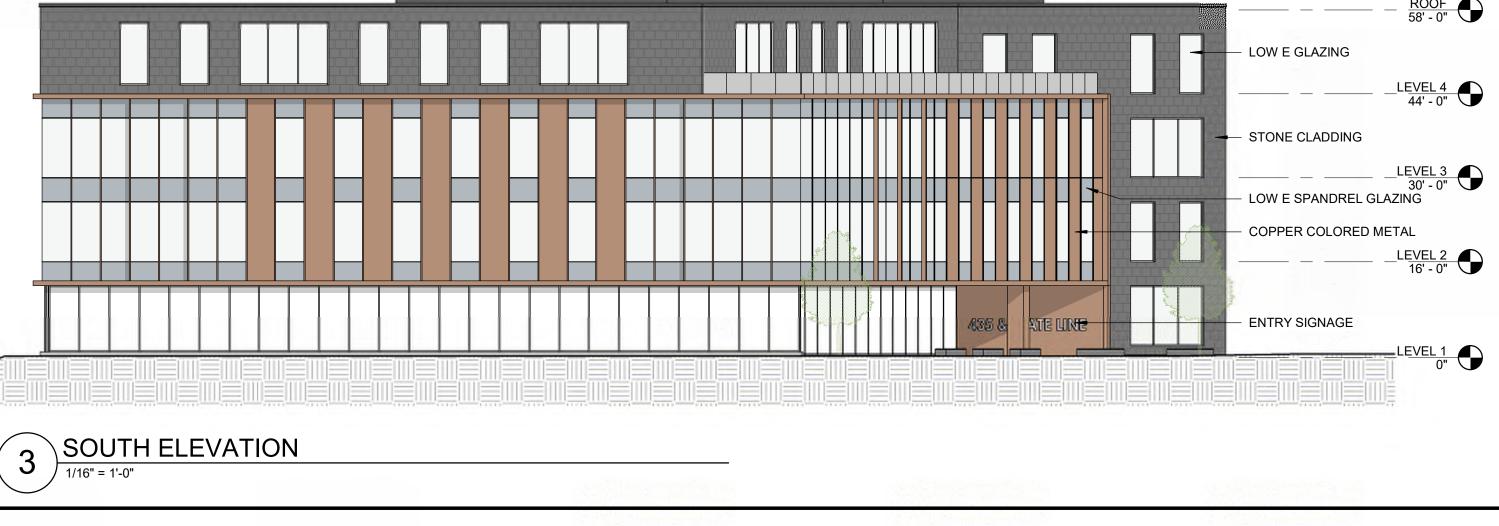

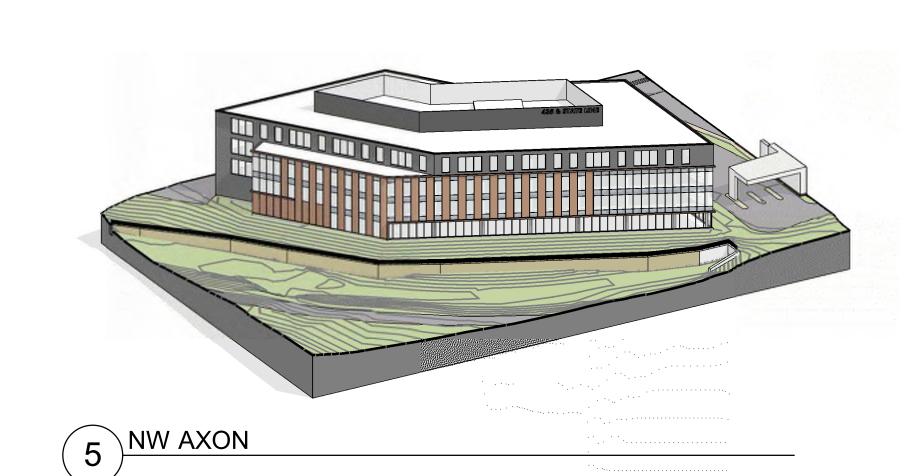





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No.	Description	Da
1	PDP SUBMISSION	4.30.2
2	PDP RE- SUBMISSION	7.1.2
roject No:	20.70060.00	


OFFICE ELEVATIONS


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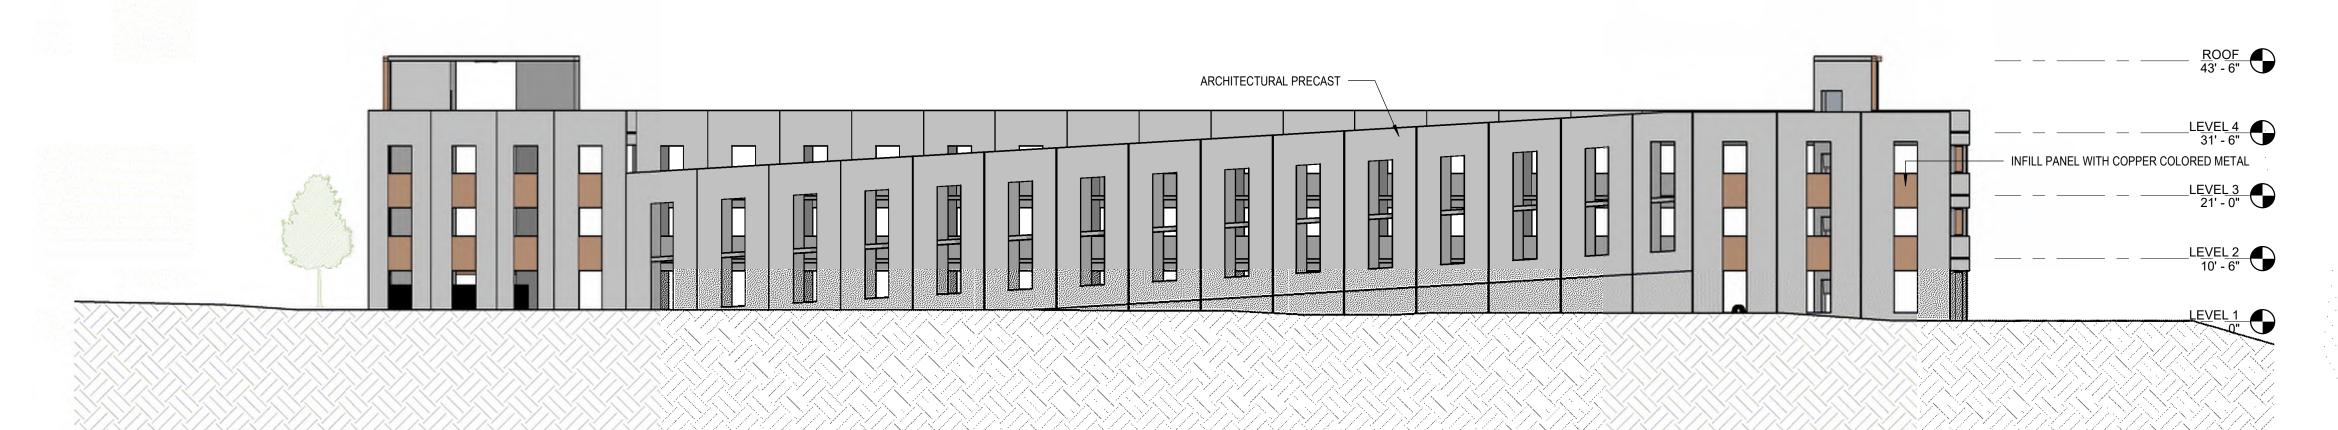





SOUTH ELEVATION


1/16" = 1'-0"

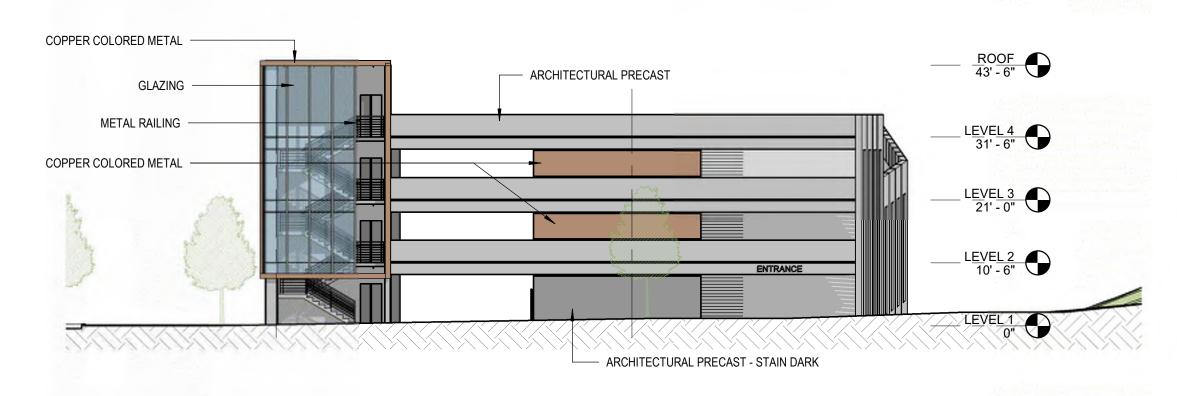


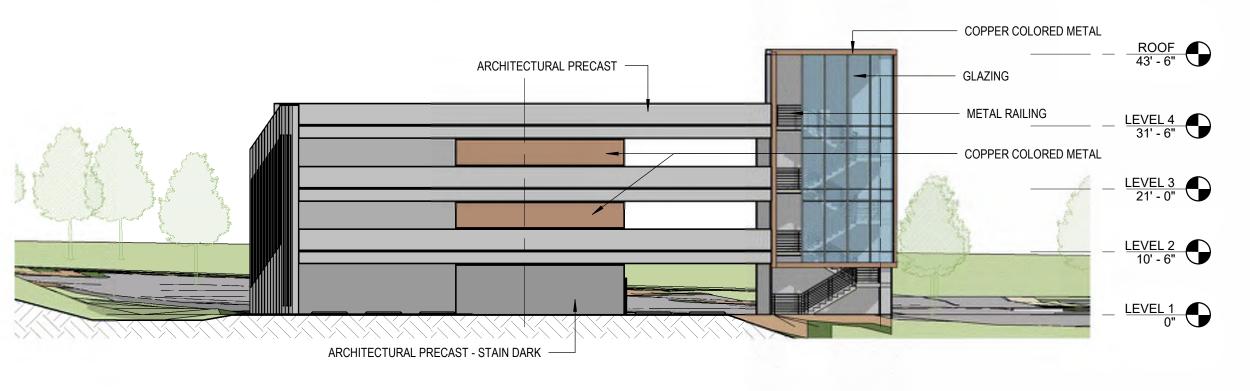



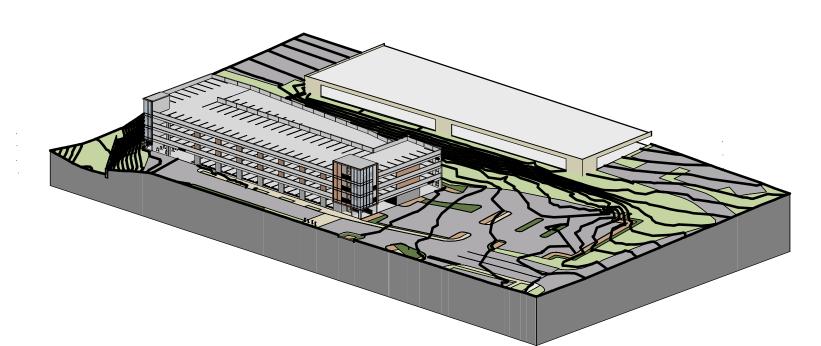

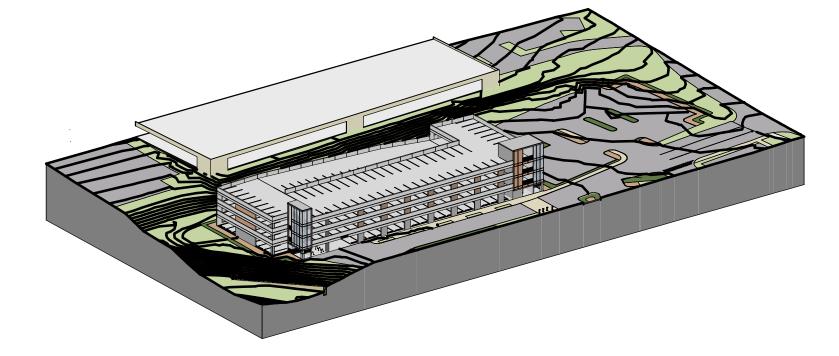

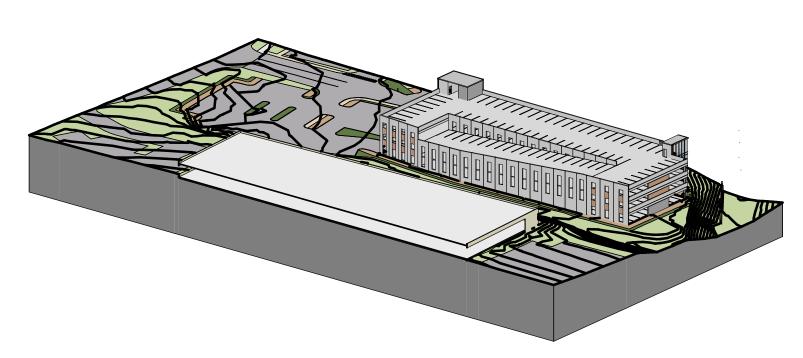

5 SW AXON

GARAGE ELEVATIONS SHOWN FOR DESIGN INTENT - PENDING VERIFICATION FROM PRECAST DESIGN ENGINEER

CON .

7 NE AXON





Project
435 & STATE LINE
Project Address

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and

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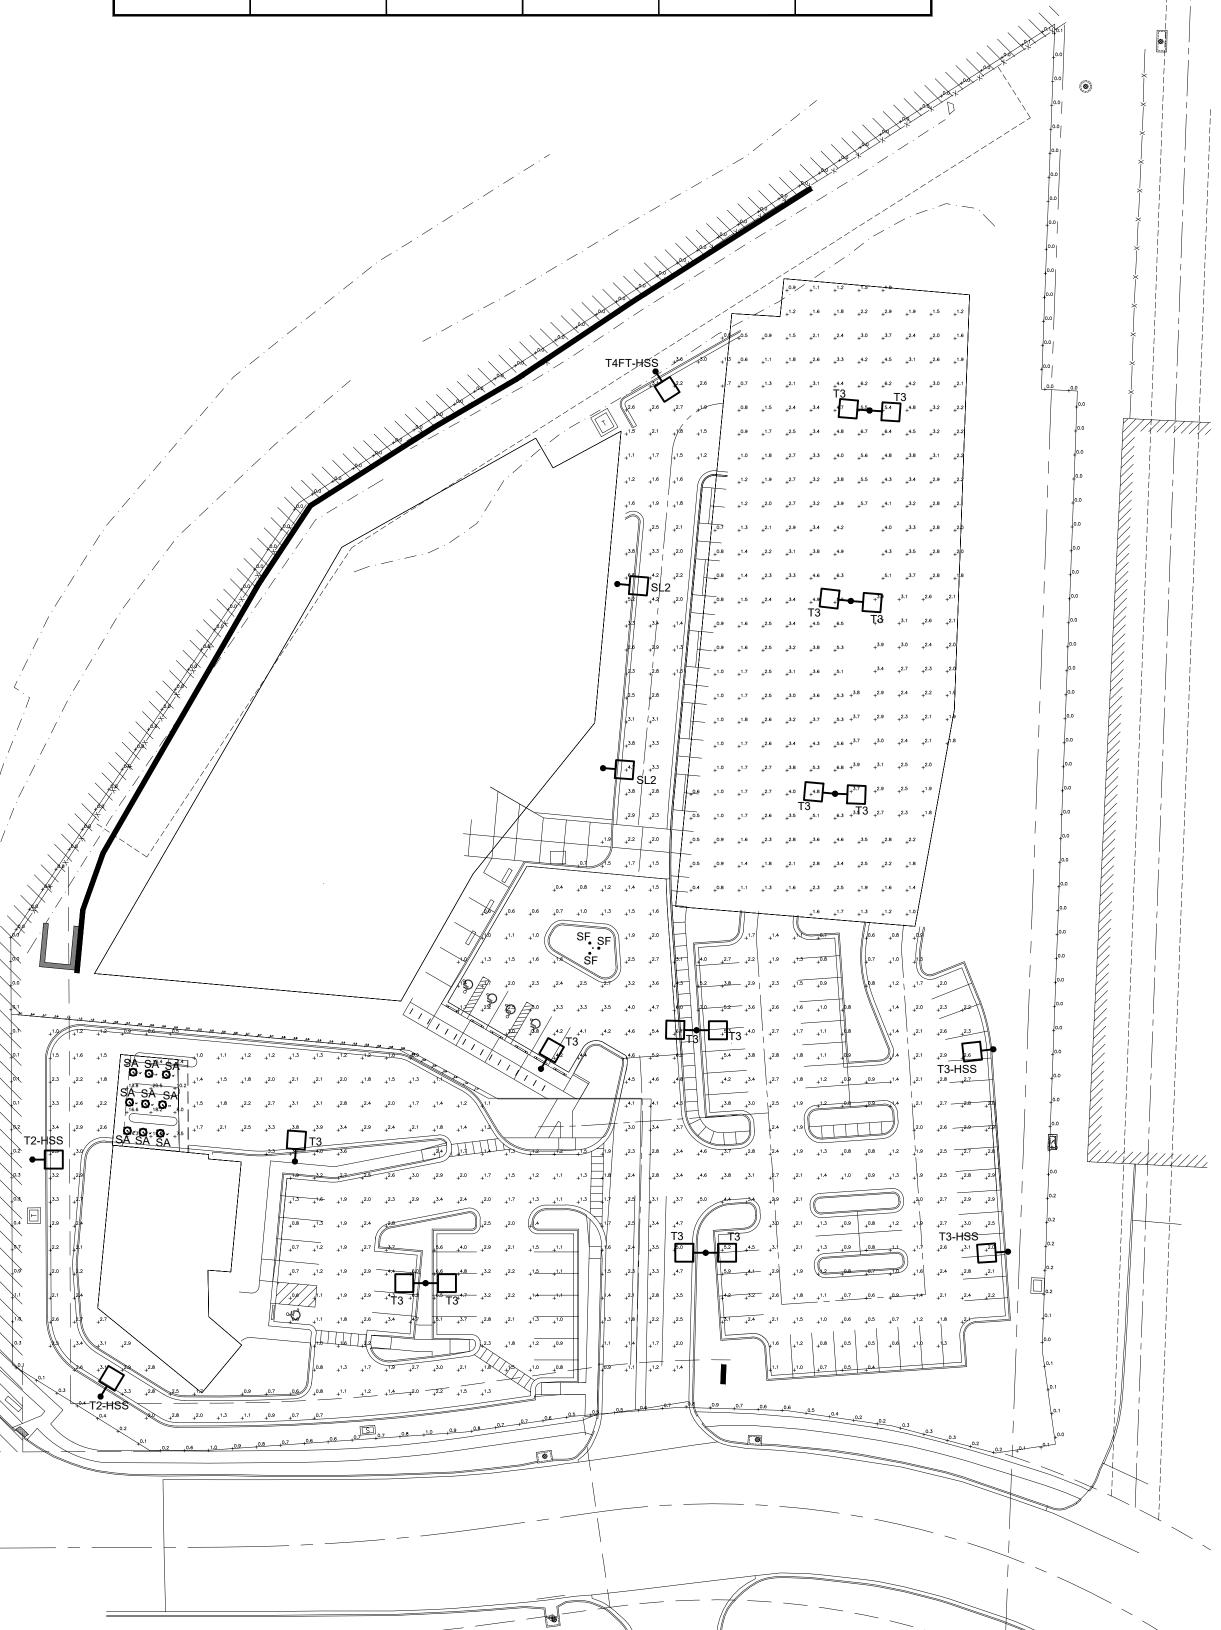
No.	Description		Date
1	PDP SUBMISSION		4.30.2021
2	PDP RE- SUBMISS		7.1.2021
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	•		
Project No:	20.70060.00		
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Garage Elevations

Sheet Number

PHOTO	PHOTOMETRIC STATISTICS						
	AVERAGE	MAXIMUM	MINIMUM	NIMUM MAX/MIN AVERAGI			
PARKING AREA	2.3 FC	7.0 FC	0.4 FC	17.5:1	5.8:1		
GARAGE ROOF	2.8 FC	6.9 FC	0.4 FC	17.3:1	7.0:1		



#### **FEATURES**

- Compact LED flood with a variety of NEMA distributions for lighting applications such as: safety/security, accent, flag pole, columns or signs
- Part of the Ratio flood series, this luminaire was designed in cohesion with the site/area products to provide a sleek and
- Features a dense optical array, providing reduced pixelation and increased visual comfort without compromising performance









INSTALLATION

**ELECTRICAL** 

knuckle mounting

back of fixture housing

• 120–277V operation, 50/60Hz

• 10kV surge protector optional

easy connection

20% THD

Driver IP66 and RoHS compliant driver

• 0–10V dimming driver standard, continuous

over-current protection and short circuit

• Dimming drivers are standard, but must

purpose of external dimming controls

contact factory to request wiring leads for

protection with auto recovery

dimming option to have leads pulled out for

LOCATION: PROJECT: CATALOG #:

#### **RATIO**



RELATED PRODUCTS 8 RATIO Family 8 Boxes and Covers

#### SPECIFICATIONS

CONSTRUCTION Corrosion resistant, rugged die-cast aluminum housing with powder coat paint finish

 High impact UV stabilized acrylic outer lens protects LEDs and allows for cleaning and debris removal

• Internal venting fins create optimal heat dissipation and allow all water to drain from the face of the luminaire

 Lens hardware is internal to the fixture allowing for uniform pressure on the gasket for an optimal water tight seal

OPTICS 44 or 90 midpower LEDs

 Stock Versions: 4000K and 5000K CCT Variety of NEMA distributions: - N (2x2), M (4x4) and W (6x6) - Stock version Wide (6x6) only

• Entire optical aperture illuminates to create a larger luminous surface area resulting in a low glare appearance without sacrificing optical performance

CERTIFICATIONS

• Traditional ½" x 14 NPS threaded adjustable Fixture is IP66 rated • Listed to UL1598 for use in wet locations • Easy maintenance access to electrical

• This product qualifies as a "designated components with removal of 4 screws from country construction material" per FAR 52.225-11 Buy American-Construction Trunnion mount available (sold separately) Materials under Trade Agreements effective 04/23/2020. See Buy American Solutions

> WARRANTY 5 year limited warranty • See <u>HLI Standard Warranty</u> for

• Drivers have 90% power factor and less than • LED drivers have output power over-voltage,

> KEY DATA 3245-6823 Lumen Range 26-52 Wattage Range Efficacy Range (LPW) Fixture Projected Life (Hours)

Weights lbs. (kg)

Page **1/4** Rev. **08/14/20 RATIO 2/3-FLOOD-SPEC** 

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3.7–5.5 (6.12–10.8)


TYPE	MANUFACTURER	LAMPS	WATTS	DIMMING	DESCRIPTION	NOTES
			VOLTS	PROTOCOL		
SA	H.E. WILLIAMS 4DR-TL-L20-840-DIM-UNV-	2,000 LUMENS 4.000K	19.8	N/A	4" LED DOWNLIGHT WITH OPEN REFLECTOR, WIDE DISTRIBUTION, 1/2" STANDARD FLANGE, CLEAR SEMI-SPECULAR ANODIZE	
	OW-OF-CS-WET-CC	80+ CRI	120	-	AND WET LOCATION LISTED.	
SF	HUBBELL OUTDOOR LIGHTING RATIO FLOOR COMPACT	LED / 4,000K		N/A 	FLAG POLE LIGHT	2
SL2	McGRAW EDISON GLEON-SA2A-740-U-SL2	9,357 LUMENS 4,000K 70+ CRI	66 208	N/A	LED PARKING LOT LUMINAIRE WITH TYPE 2 DISTRIBUTION AND SPILL CONTROL. MOUNTED AT 15FT.	1,2
T2-HSS	McGRAW EDISON GLEON-SA3B-740-U-T2-HSS	17,121 LUMENS 4,000K 70+ CRI	<u>124</u> 208	N/A 	LED PARKING LOT LUMINAIRE WITH TYPE 2 DISTRIBUTION AND HOUSE SIDE SHIELD. MOUNTED AT 25FT.	1,2
T3-HSS	McGRAW EDISON GLEON-SA3B-740-U-T3-HSS	17,450 LUMENS 4,000K 70+ CRI	<u>124</u> 208	N/A 	LED PARKING LOT LUMINAIRE WITH TYPE 3 DISTRIBUTION AND HOUSE SIDE SHIELD. MOUNTED AT 25FT.	1,2
Т3	McGRAW EDISON GLEON-SA3B-740-U-T3	17,450 LUMENS 4,000K 70+ CRI	124 208	N/A 	LED PARKING LOT LUMINAIRE WITH TYPE 3 DISTRIBUTION.  MOUNTED AT 25FT.	1,2
T4FT-HSS	McGRAW EDISON GLEON-SA2A-740-U-T4FT-HSS	9,591 LUMENS 4,000K 70+ CRI	<u>66</u> 208	N/A 	LED PARKING LOT LUMINAIRE WITH TYPE 4 DISTRIBUTION AND HOUSE SIDE SHIELD. MOUNTED AT 15FT.	1,2

1 HEIGHT OF LUMINAIRE INDICATED IS HEIGHT FROM GRADE TO BOTTOM OF LUMINAURE. ORDER POLE TO ACCOMMODATE BASE HEIGHT. 2 VERIFY FINISH COLOR WITH ARCHITECT.

THE LIGHTING DESIGN FOR THIS PROJECT IS BASED UPON THE MANUFACTURERS SPECIFIED. IF AN ADDITIONAL SUBSTITUTION IS DESIRED BY THE CONTRACTOR, A SUBSTITUTION REQUEST SUBMITTAL MUST BE PROVIDED AS FOLLOWS:

S1. SUBSTITUTION REQUEST MUST BE RECEIVED BY THE ENGINEER IN WRITING 10 DAYS PRIOR TO BID. FAILURE TO SUBMIT CONSTITUTES A GUARANTEE TO SUPPLY THE SPECIFIED FIXTURES.

S2. INFORMATION IS TO BE SUPPLIED COMPARING PHOTOMETRY, (WITH FLOOR PLANS INDICATING POINT BY POINT CALCULATIONS) DIMENSIONS, MATERIAL COMPOSITION, FINISH, VISUAL APPEARANCE AS WELL AS THE "CONTRACTOR NET" PRICING. SAMPLES ARE TO BE PROVIDED UPON REQUEST.

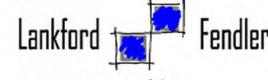

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COA No. 2006001168





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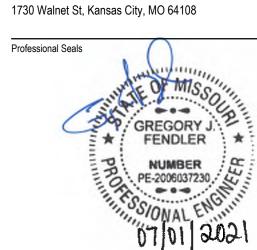
Oppermann LandDesign LLC Retail Bank Landscape Architect

22 Debra Lane, New Windsor, New York 12553

Lankford Fendler Associates **Engineering Consultant** 

No. Description

PDP SUBMISSION PDP RESUBMISSION





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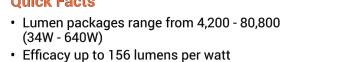
SITE LIGHTING-**PHOTOMETRICS** 


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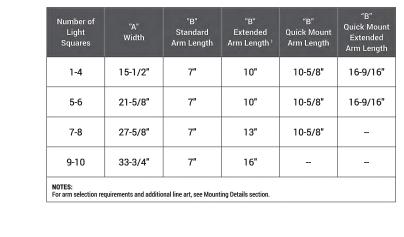
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4.30.2021









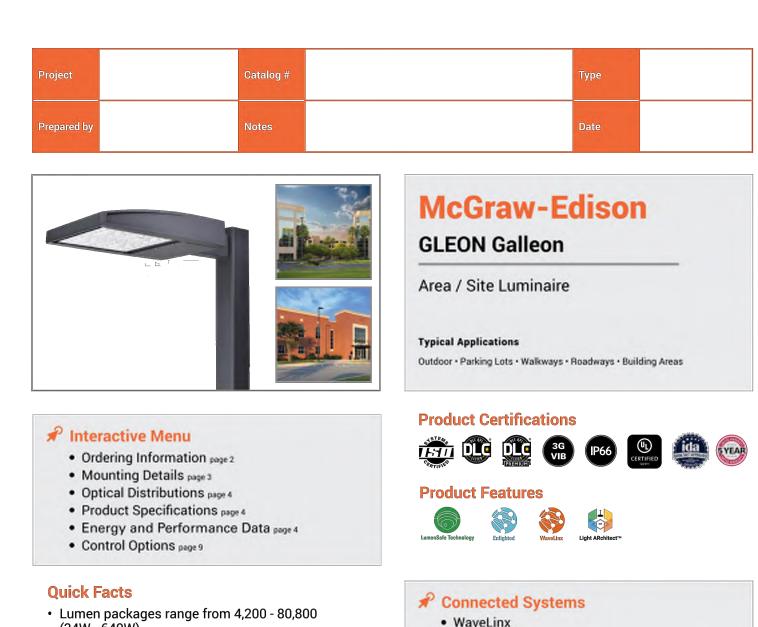

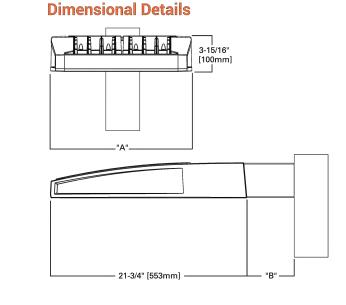
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**COOPER** PS500020EN page 1 April 12, 2021 1:45 PM



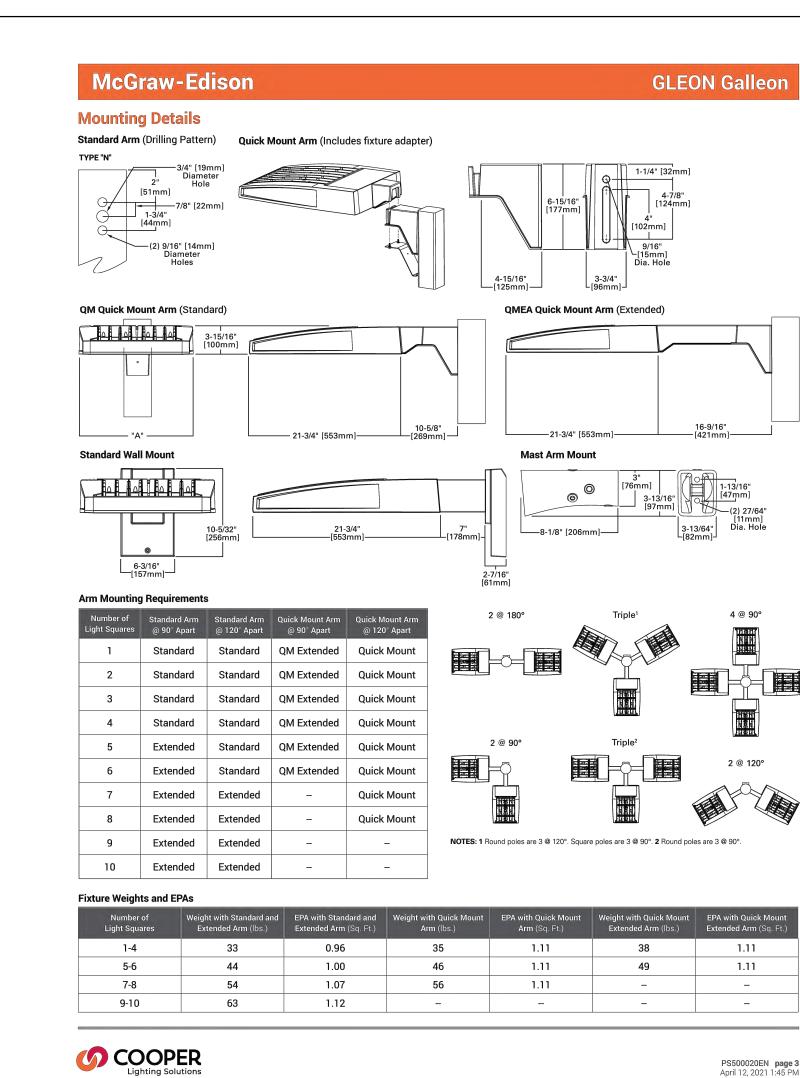

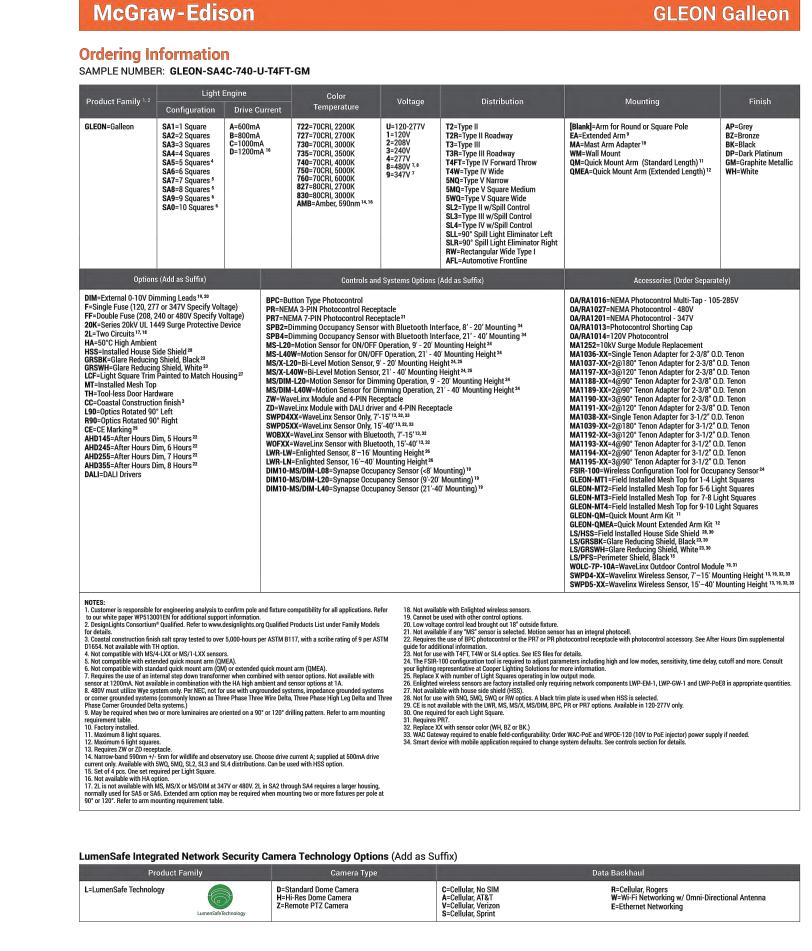**OOOPER** 

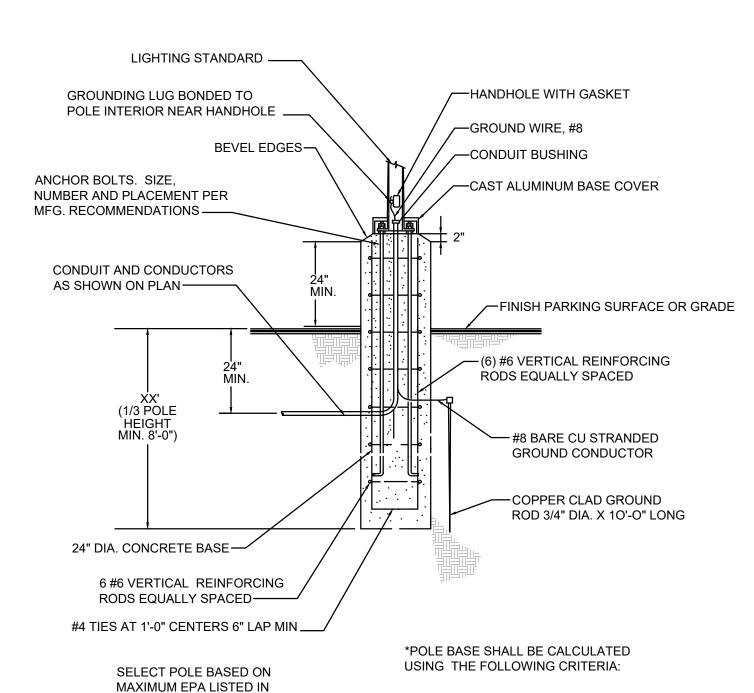

LIGHTING POLE BASE DETAIL NO SCALE

TOTAL EPA OF LUMINARIES

**+TOTAL EPA OF BRACKETS** 

=TOTAL EPA OF LUMINAIRES/BRACKETS


MANUFACTURERS CATALOG

IN ANY CASE MIN. POLE BASE DEPTH SHALL BE 81". FINAL


DEPTH OF POLE BASE SHALL BE

ENGINEER PRIOR TO PLACEMENT.

VERIFIED WITH STRUCTURAL

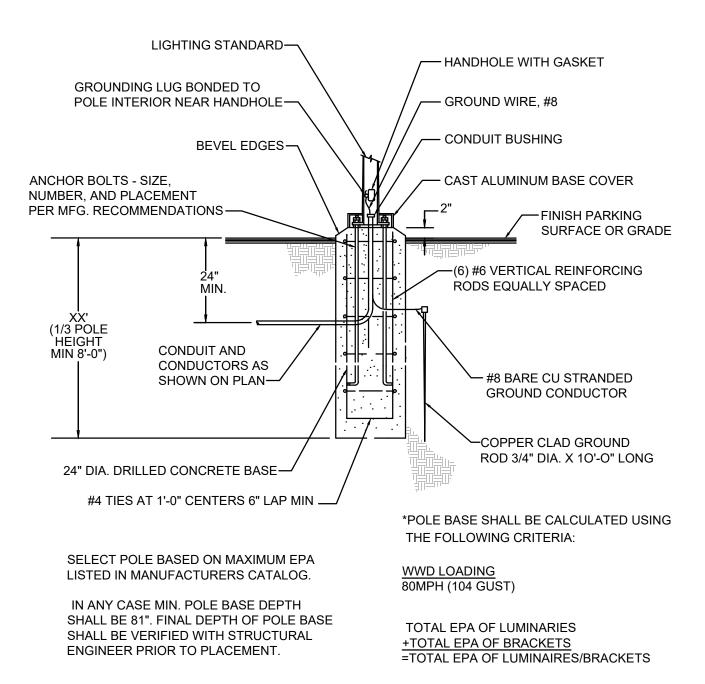

#### LIGHTING POLE BASE DETAIL NO SCALE

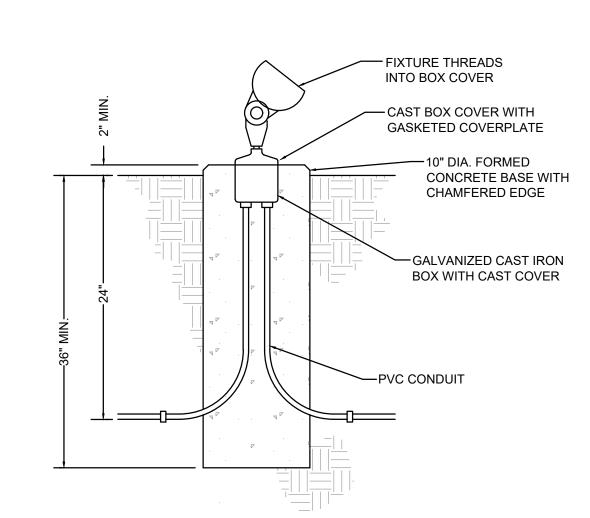

SUPPORT FOR GROUND MOUNTED LIGHTS DETAIL NO SCALE



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Lankford Fendler Associates **Engineering Consultant** 

No. Description

PDP SUBMISSION

PDP RESUBMISSION

1730 Walnet St, Kansas City, MO 64108 Professional Seals PE-2006037230 . . ---


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4.30.2021

Project No: 20.70060.00

SITE LIGHTING-**DETAILS** 


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MATERIAL LEGEND: 1. Brick Veneer 2. Glazing 3. Architectural Aluminum Composite Wall Panel 4. Sheet Metal Coping

2 South Elevation

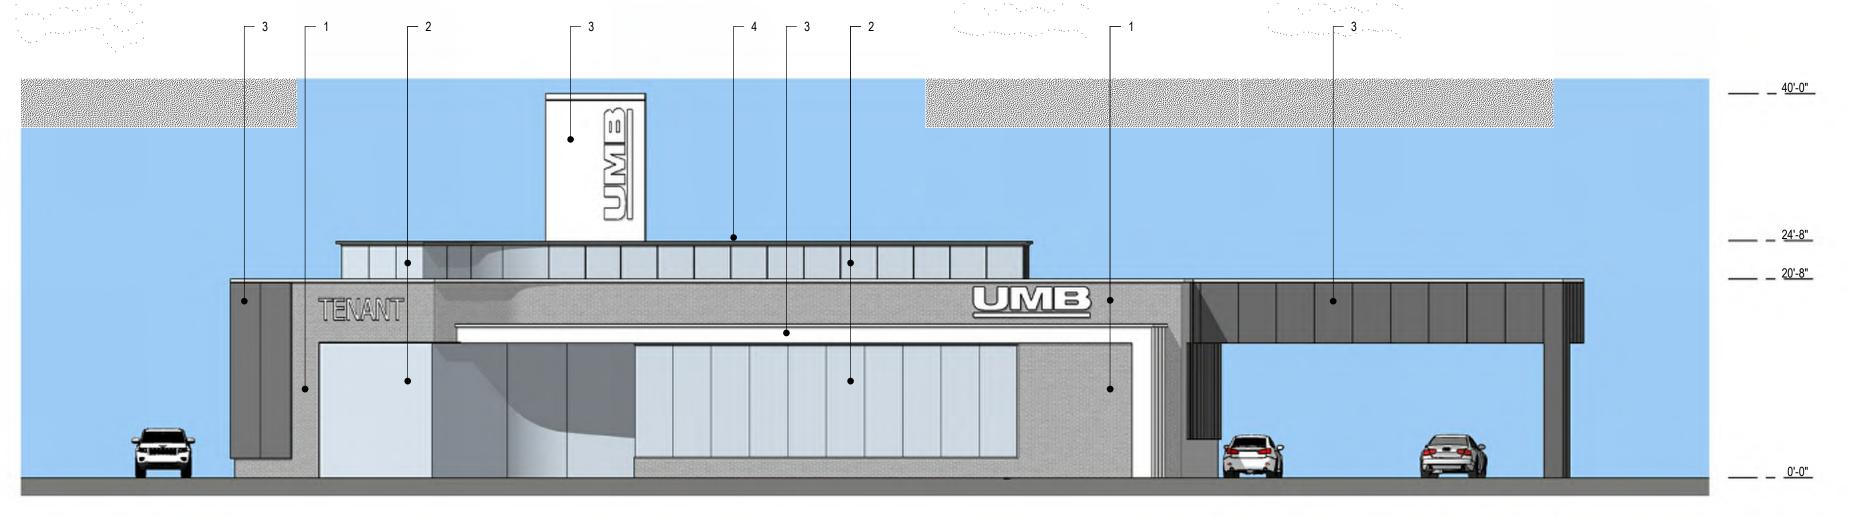1" = 10'-0"



4 North Elevation
1" = 10'-0"

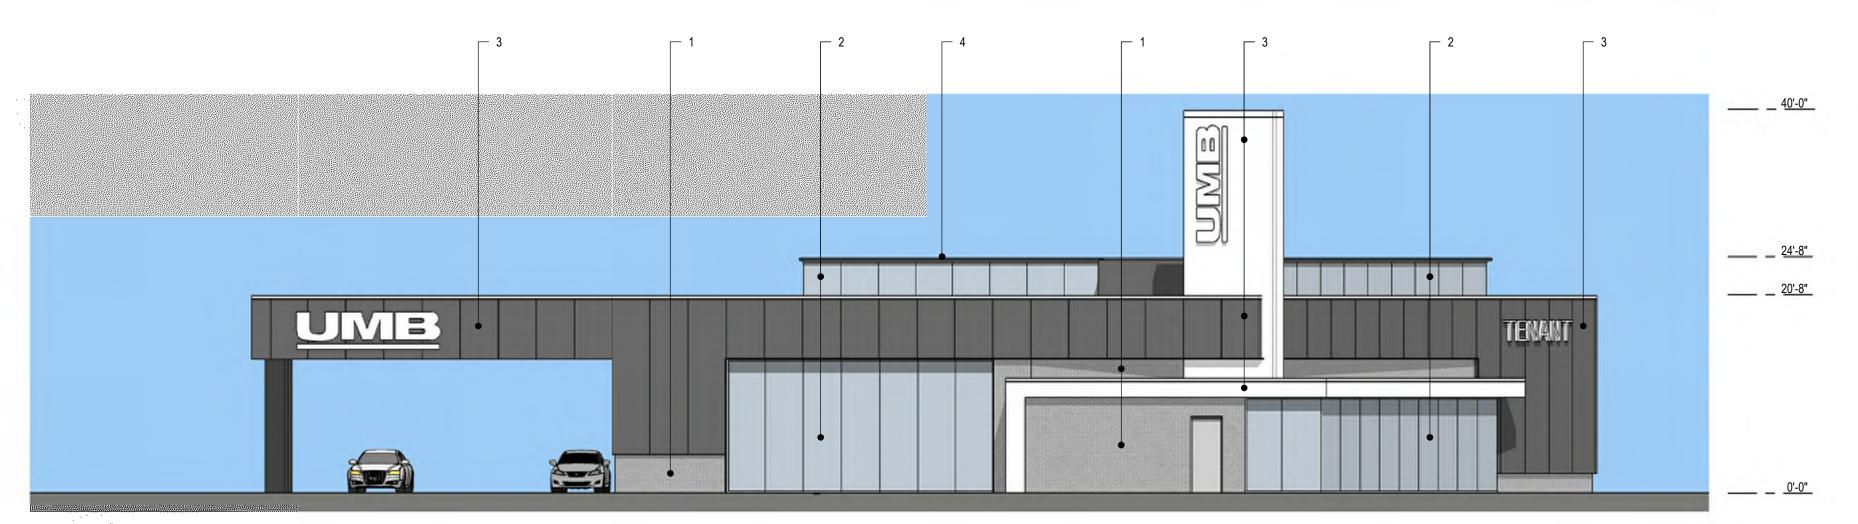3 West Elevation 1" = 10'-0"

East Elevation



Southwest Perspective
1" = 10'-0"



6 Southeast Perspective

1" = 10'-0"

VanTrust REAL ESTATE LLC



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435 & STATE LINE
1310 Carondelet Dr, Kansas City, MO 64114

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 No.
 Description
 Date

 1
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 4.30.2021

 2
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 7.1.2021

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Sheet Title:

UMB Bank Exterior Elevations

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A03