
VIVA BENE - AVENUE

A TRACT OF LAND IN THE FRACTIONAL SOUTHWEST QUARTER OF SECTION 10, TOWNSHIP 51 NORTH, RANGE 33 WEST CITY OF KANSAS CITY, PLATTE COUNTY, MISSOURI

DEVELOPMENT PLAN

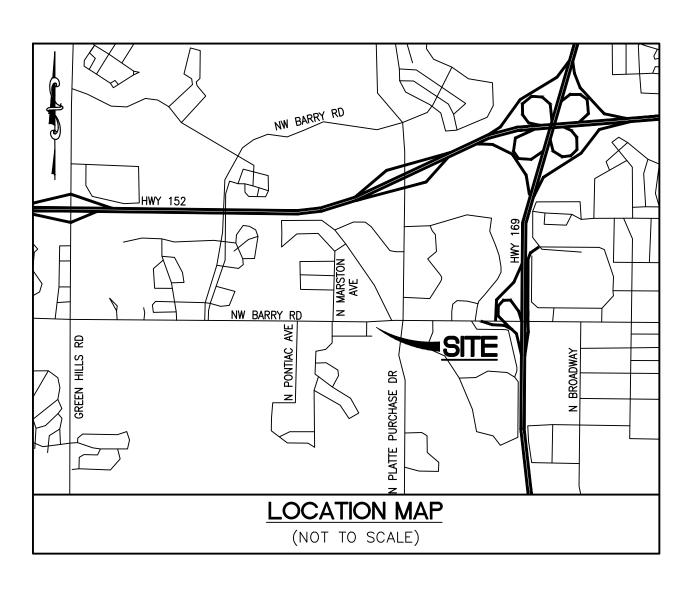

PERTINENT DATA

SITE ADDRESS

- = 1801 NW BARRY ROAD KANSAS CITY, MO 64151
- PARCEL ID FIRE DISTRICT
- FEMA MAP PANEL GROSS SITE AREA
- = KANSAS CITY FIRE DEPARTMENT
- = 29095C0126G, DATE: JAN 20, 2017 = 6.394 AC.

UTILITIES

SEWER SERVICE

CITY OF KANSAS CITY SEWER 4800 E 63RD STREET

KANSAS CITY, MO 64130 CONTACT: ---

PH. 816.513.1313 OR 311

FIRE DISTRICT

FIRE DEPARTMENT CITY OF KANSAS CITY, MO. 635 WOODLAND AVE. SUITE 2103 KANSAS CITY, MO 64106

CONTACT: MIKE SCHROEDER PH. 816.513.4604

WATER SERVICE

4800 E 63RD STREET KANSAS CITY, MO 64130 CONTACT: ---

CITY OF KANSAS CITY SEWER

PH. 816.513.1313 OR 311

ELECTRIC SERVICE

EVERGY 1200 MAIN ST KANSAS CITY, MO 64105 CONTACT: ---PH. 888.471.5275

INDEX

REVISIONS

preliminary review only

under the authority of

P.E. -2018021213

on 09/30/2022.

construction or permitting

DATE: 09/30/2022

LFD

AS SHOWN

8/26/2022

Job Number

22-0119

Sheet Number

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DRAWING SCALE

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		1	2	3	4	5	6	7	8	9
P1.0	COVER SHEET									
50.0	EVICTING CONDITIONS		ı	1						
P2.0	EXISTING CONDITIONS	-							\square	
P3.0	PRELIMINARY SITE PLAN									
1 3.0	TILLIMINARY SHE LEAN									
P4.0	PRELIMINARY GRADING AND UTILITY PLAN									
P5.0	DETAIL SHEET									
DC O	DETAIL CLIEFT									
P6.0	DETAIL SHEET	\vdash								
	PHOTOMETRIC PLAN - BY OTHERS									
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L1.0	OVERALL LANDSCAPE PLAN									
	LANDONADE EN ADOEMENT			I	1					
L1.1	LANDSCAPE ENLARGEMENT									
L1.2	LANDSCAPE ENLARGEMENT									
L1.Z					<u> </u>					
L1.3	LANDSCAPE ENLARGMENT									
L1.4	PLANT SCHEDULE AND NOTES	_								
120	STDEET TOEE DIANI	\vdash								
L2.0	STREET TREE PLAN								\square	

DEVELOPMENT NOTES

= 6.394 ACEXISTING ZONING = B3-2= B3-2PROPOSED ZONING

= VACANT/AGRICULTURAL EXISTING USE

= ELDERLY HOUSING/MEDICAL OFFICES PROPOSED USE = PLATTE PURCHASE PLAZA LLC CURRENT OWNERS = AVENUE DEVELOPMENT, LLC

- 2. AS DETERMINED THROUGH GRAPHIC PLOTTING ONLY, SUBJECT TRACT FALLS IN ZONE X, AREA DETERMINED TO BE OUTSIDE THE 0.2% ANNUAL CHANCE FLOODPLAIN PER THE FEDERAL EMERGENCY MANAGEMENT AGENCY AND FLOOD INSURANCE RATE MAP FOR PLATTE COUNTY, MISSOURI AND INCORPORATED AREAS, PANEL 126 OF 625, MAP NUMBER 29095C0126G, EFFECTIVE DATE OF
- 3. UNDERGROUND UTILITIES AND FACILITIES HAVE BEEN SHOWN BASED ON RECORD DRAWINGS AND VISIBLE EVIDENCE FOUND. NO WARRANTY IS MADE REGARDING THE COMPLETENESS OR ACCURACY OF SUCH INFORMATION. TO DETERMINE THE EXACT LOCATION OF UNDERGROUND FACILITIES AND UTILITIES, AND PRESERVE THEM FROM DAMAGE, CALL MISSOURI ONE CALL (1-800-DIG-RITE) FOR UTILITY LOCATIONS. CONTRACTORS TO PROVIDE THREE DAYS NOTICE. THE CONTRACTOR MUST COMPLY WITH ALL UTILITY LAWS AND PAY ANY AND ALL DAMAGES ASSOCIATED WITH HIS FAILURE TO EXACTLY LOCATE AND PRESERVE UNDERGROUND FACILITIES AND UTILITIES.
- 4. ALL UTILITIES SHALL BE INSTALLED UNDERGROUND.
- 5. THE DEVELOPER WILL BE REQUIRED TO INSTALL THE NECESSARY SEWER LINES, WATER LINES, FIRE HYDRANTS AND
- 6. DETENTION APPEARS TO BE PROVIDED PER THE PLATTE PURCHASE PLAZA MACRO DRAINAGE STUDY IN THE EXISTING BASIN TO THE SOUTH WEST OF THE SITE. THE EXISTING BASIN WILL BE ANALYZED FOR REMAINING CAPACITY AND IF REQUIRED, MODIFICATIONS WILL BE PERFORMED ACCORDINGLY. STORM WATER QUALITY WILL BE PROVIDED VIA AN ONSITE BIORETENTION BASIN, PERVIOUS PAVEMENT, PROPRIETARY DEVICE OR COMBINATION THEREOF AND SPECIFIED IN A MICRO DRAINAGE REPORT PER CITY CODE.
- 7. BACKFILL PER GEOTECHNICAL ENGINEER RECOMMENDATIONS.
- 8. SETBACKS: FRONT YARD BUILDING SETBACK: NONE SIDE YARD BUILDING SETBACK: REAR YARD BUILDING SETBACK: NONE
- 9. ALL SIGNAGE SHALL BE BY A SEPARATE REVIEW AND PERMIT PROCESS.
- 10. ALL NATURAL FEATURES AND WATER COURSES SHALL BE LEFT UNDISTURBED. 11. LIGHTING SHALL BE IN ACCORDANCE WITH THE CITY OF KANSAS CITY.
- 12. REFER TO PHOTO METRIC PLAN FOR LOCATION OF PARKING LOT LIGHTS.
- 13. AN AUTOMATIC PERMANENT IRRIGATION SYSTEM SHALL BE INSTALLED TO COVER ALL LANDSCAPED ARES OF
- 14. THE SITE ADDRESS IS 1801 NW BARRY ROAD, KANSAS CITY, MO.

City Plan Commission

Recommends Approval with Conditions of Case No. __CD-CPC-2022-00162 on __11/15/2022

Secretary of the Commission

CITY PLANNING

AND DEVELOPMENT

UTILITY INFORMATION:

UTILITIES SHOWN HAVE BEEN TAKEN FROM AVAILABLE SURVEYS, UTILITY COMPANY MAPS AND PHYSICAL PROPERTY INSPECTION. THE LOCATIONS AND FACILITIES SHALL BE CONSIDERED APPROXIMATE ONLY. THERE MAY BE ADDITIONAL UTILITIES THAT HAVE NOT BEEN SHOWN ON THIS SURVEY. THE CONTRACTOR WILL BE RESPONSIBLE FOR THE LOCATIONS OF ALL UTILITIES PRIOR TO EXCAVATION OR



CALL 1-800-DIG-RITE (MISSOURI ONE CALL) TO HAVE LOCATIONS MARKED IN THE FIELD (SUBSCRIBING UTILITIES REQUIRE 48 HOURS

CONSTRUCTION.




NOTICE PRIOR TO CONSTRUCTION).


SITE BENCHMARK INFORMATION PROJECT: CL-05 MISSOURI DNR GRS ALUMINUM DISK SET IN A 12" DIAMETER CONCRETE BASE.


SITE BENCHMARK #1: "O" IN OPEN ATOP A FIRE HYDRANT ON THE SOUTH SIDE OF NW BARRY ROAD AS SHOWN ON THE SURVEY.

NORTH PLATTE PURCHASE DRIVE AS SHOWN ON THE SURVEY.

NAVD88 ELEV = 919.58NAVD88 ELEV = 1012.48SITE BENCHMARK #2: CUT SQUARE ON SOUTHWEST CORNER OF A CURB INLET ON THE WEST SIDE OF NAVD88 ELEV = 991.02

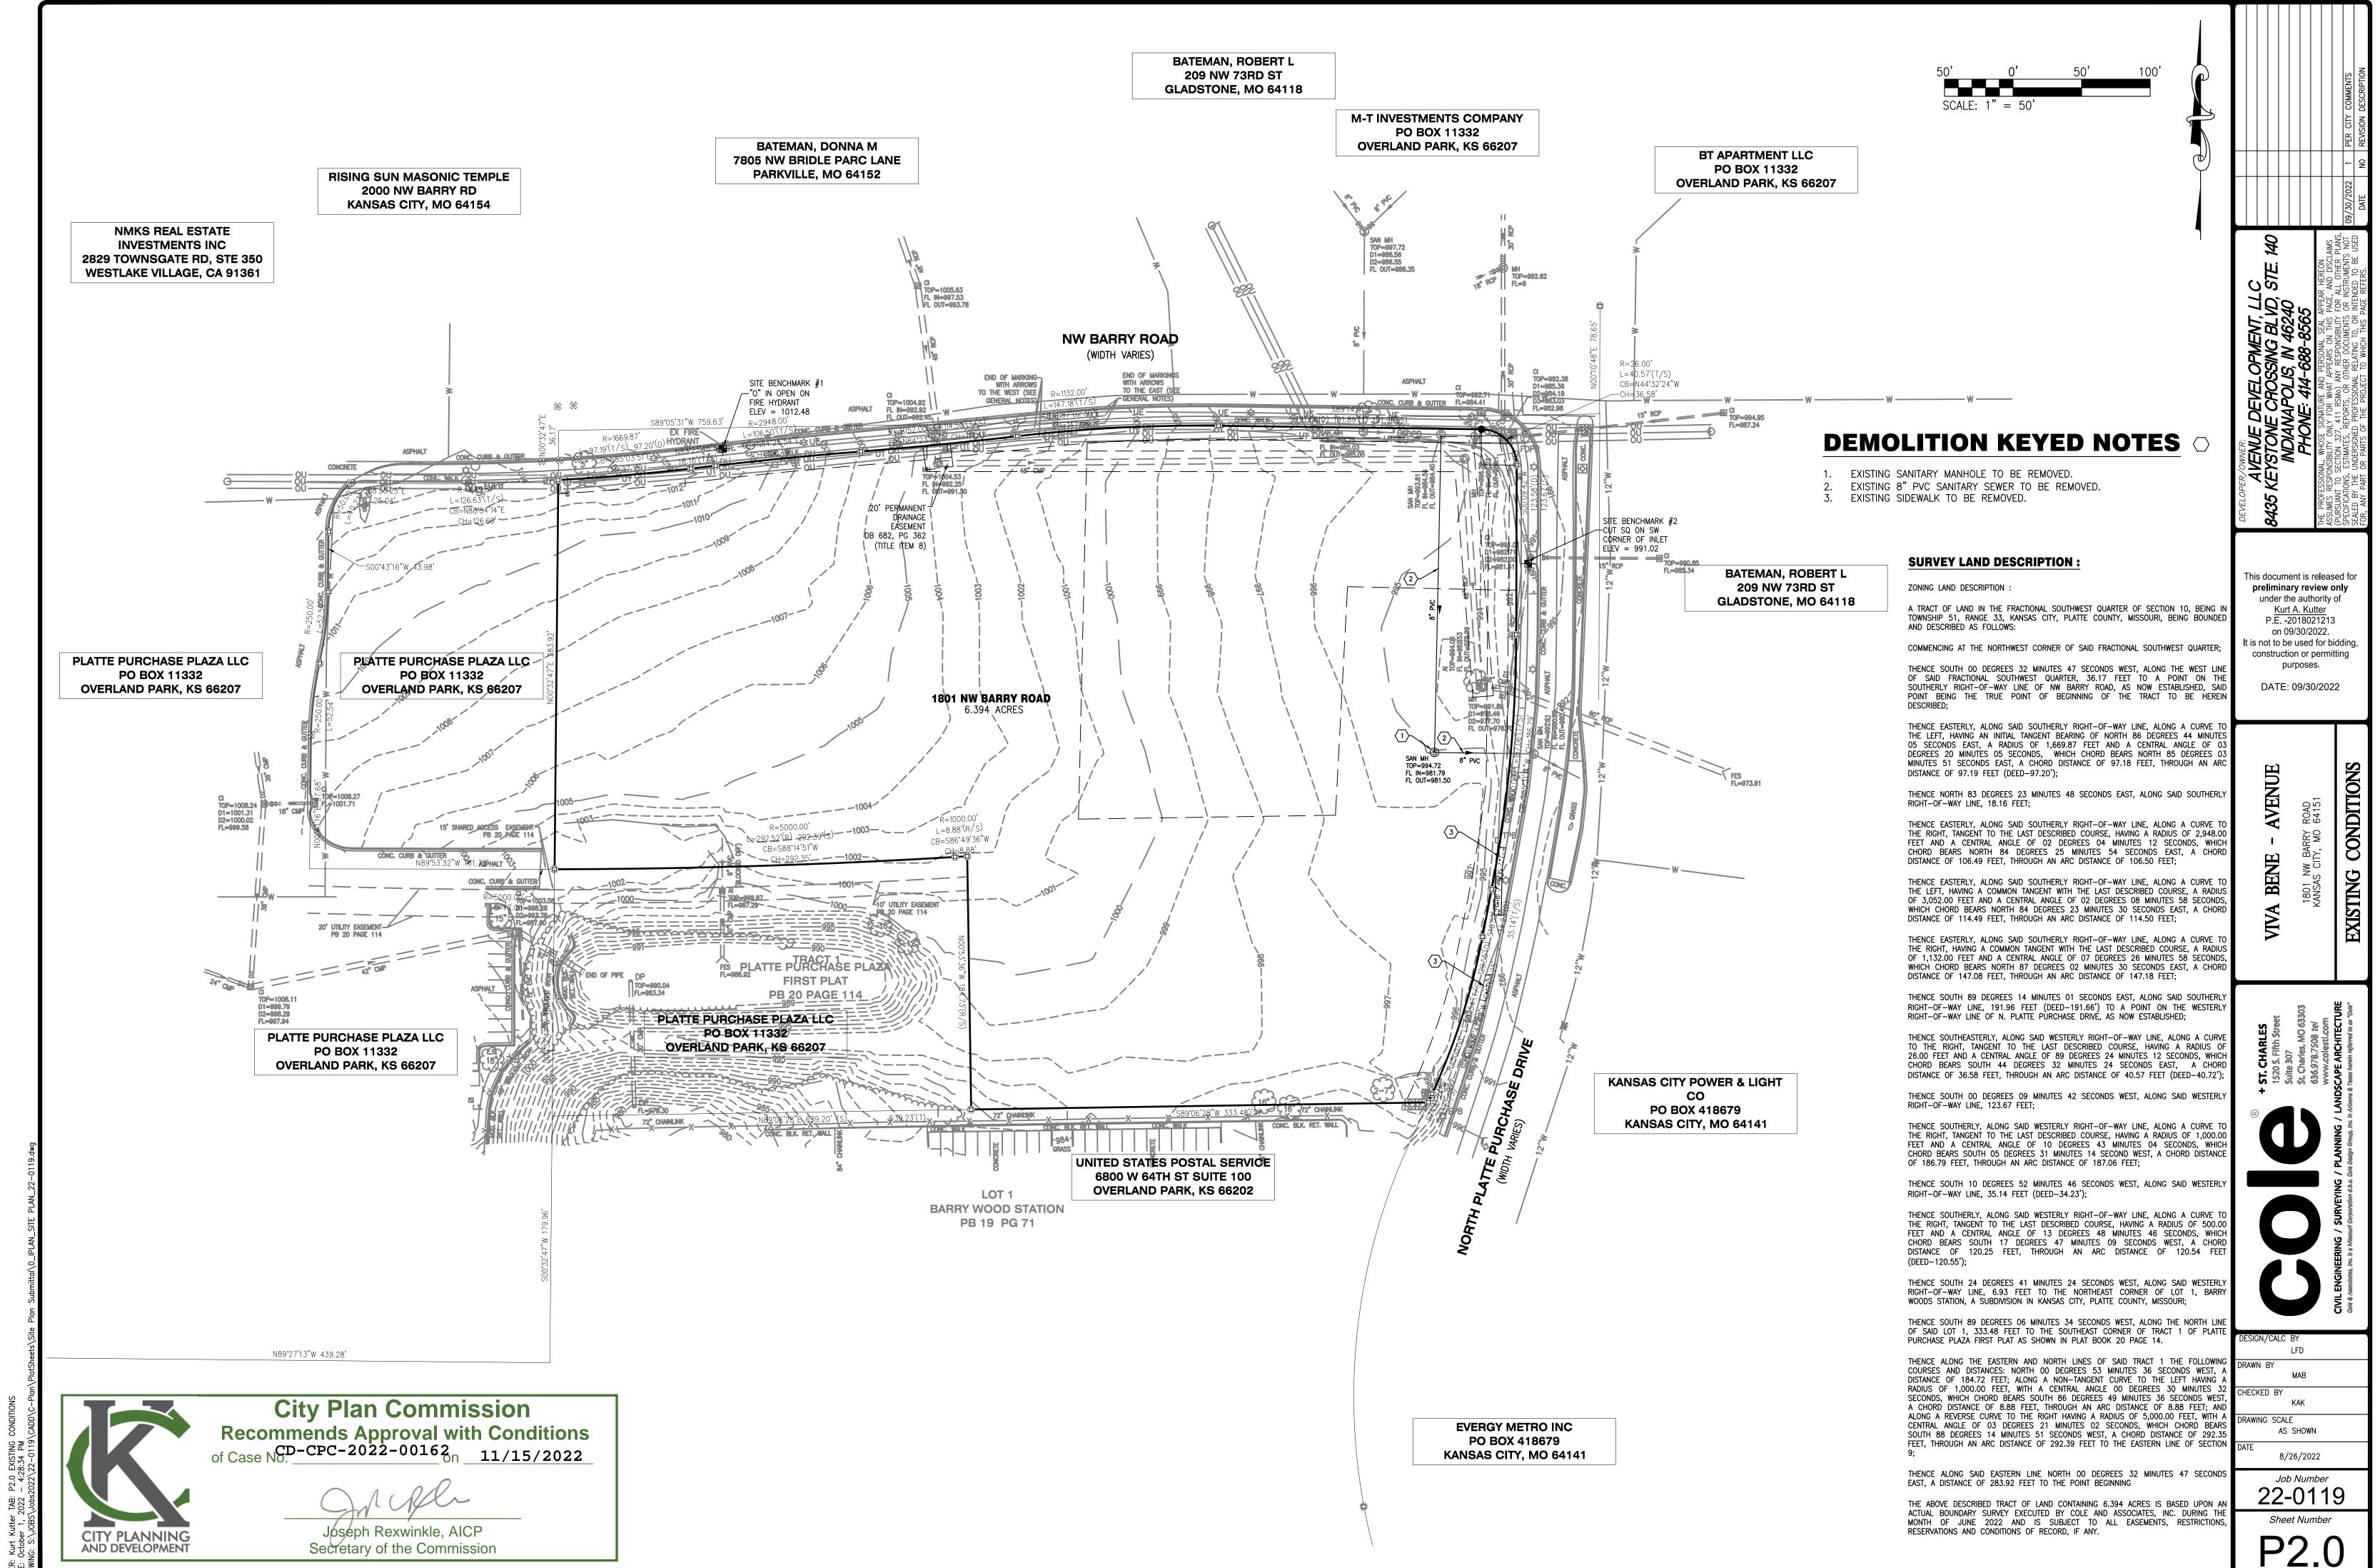

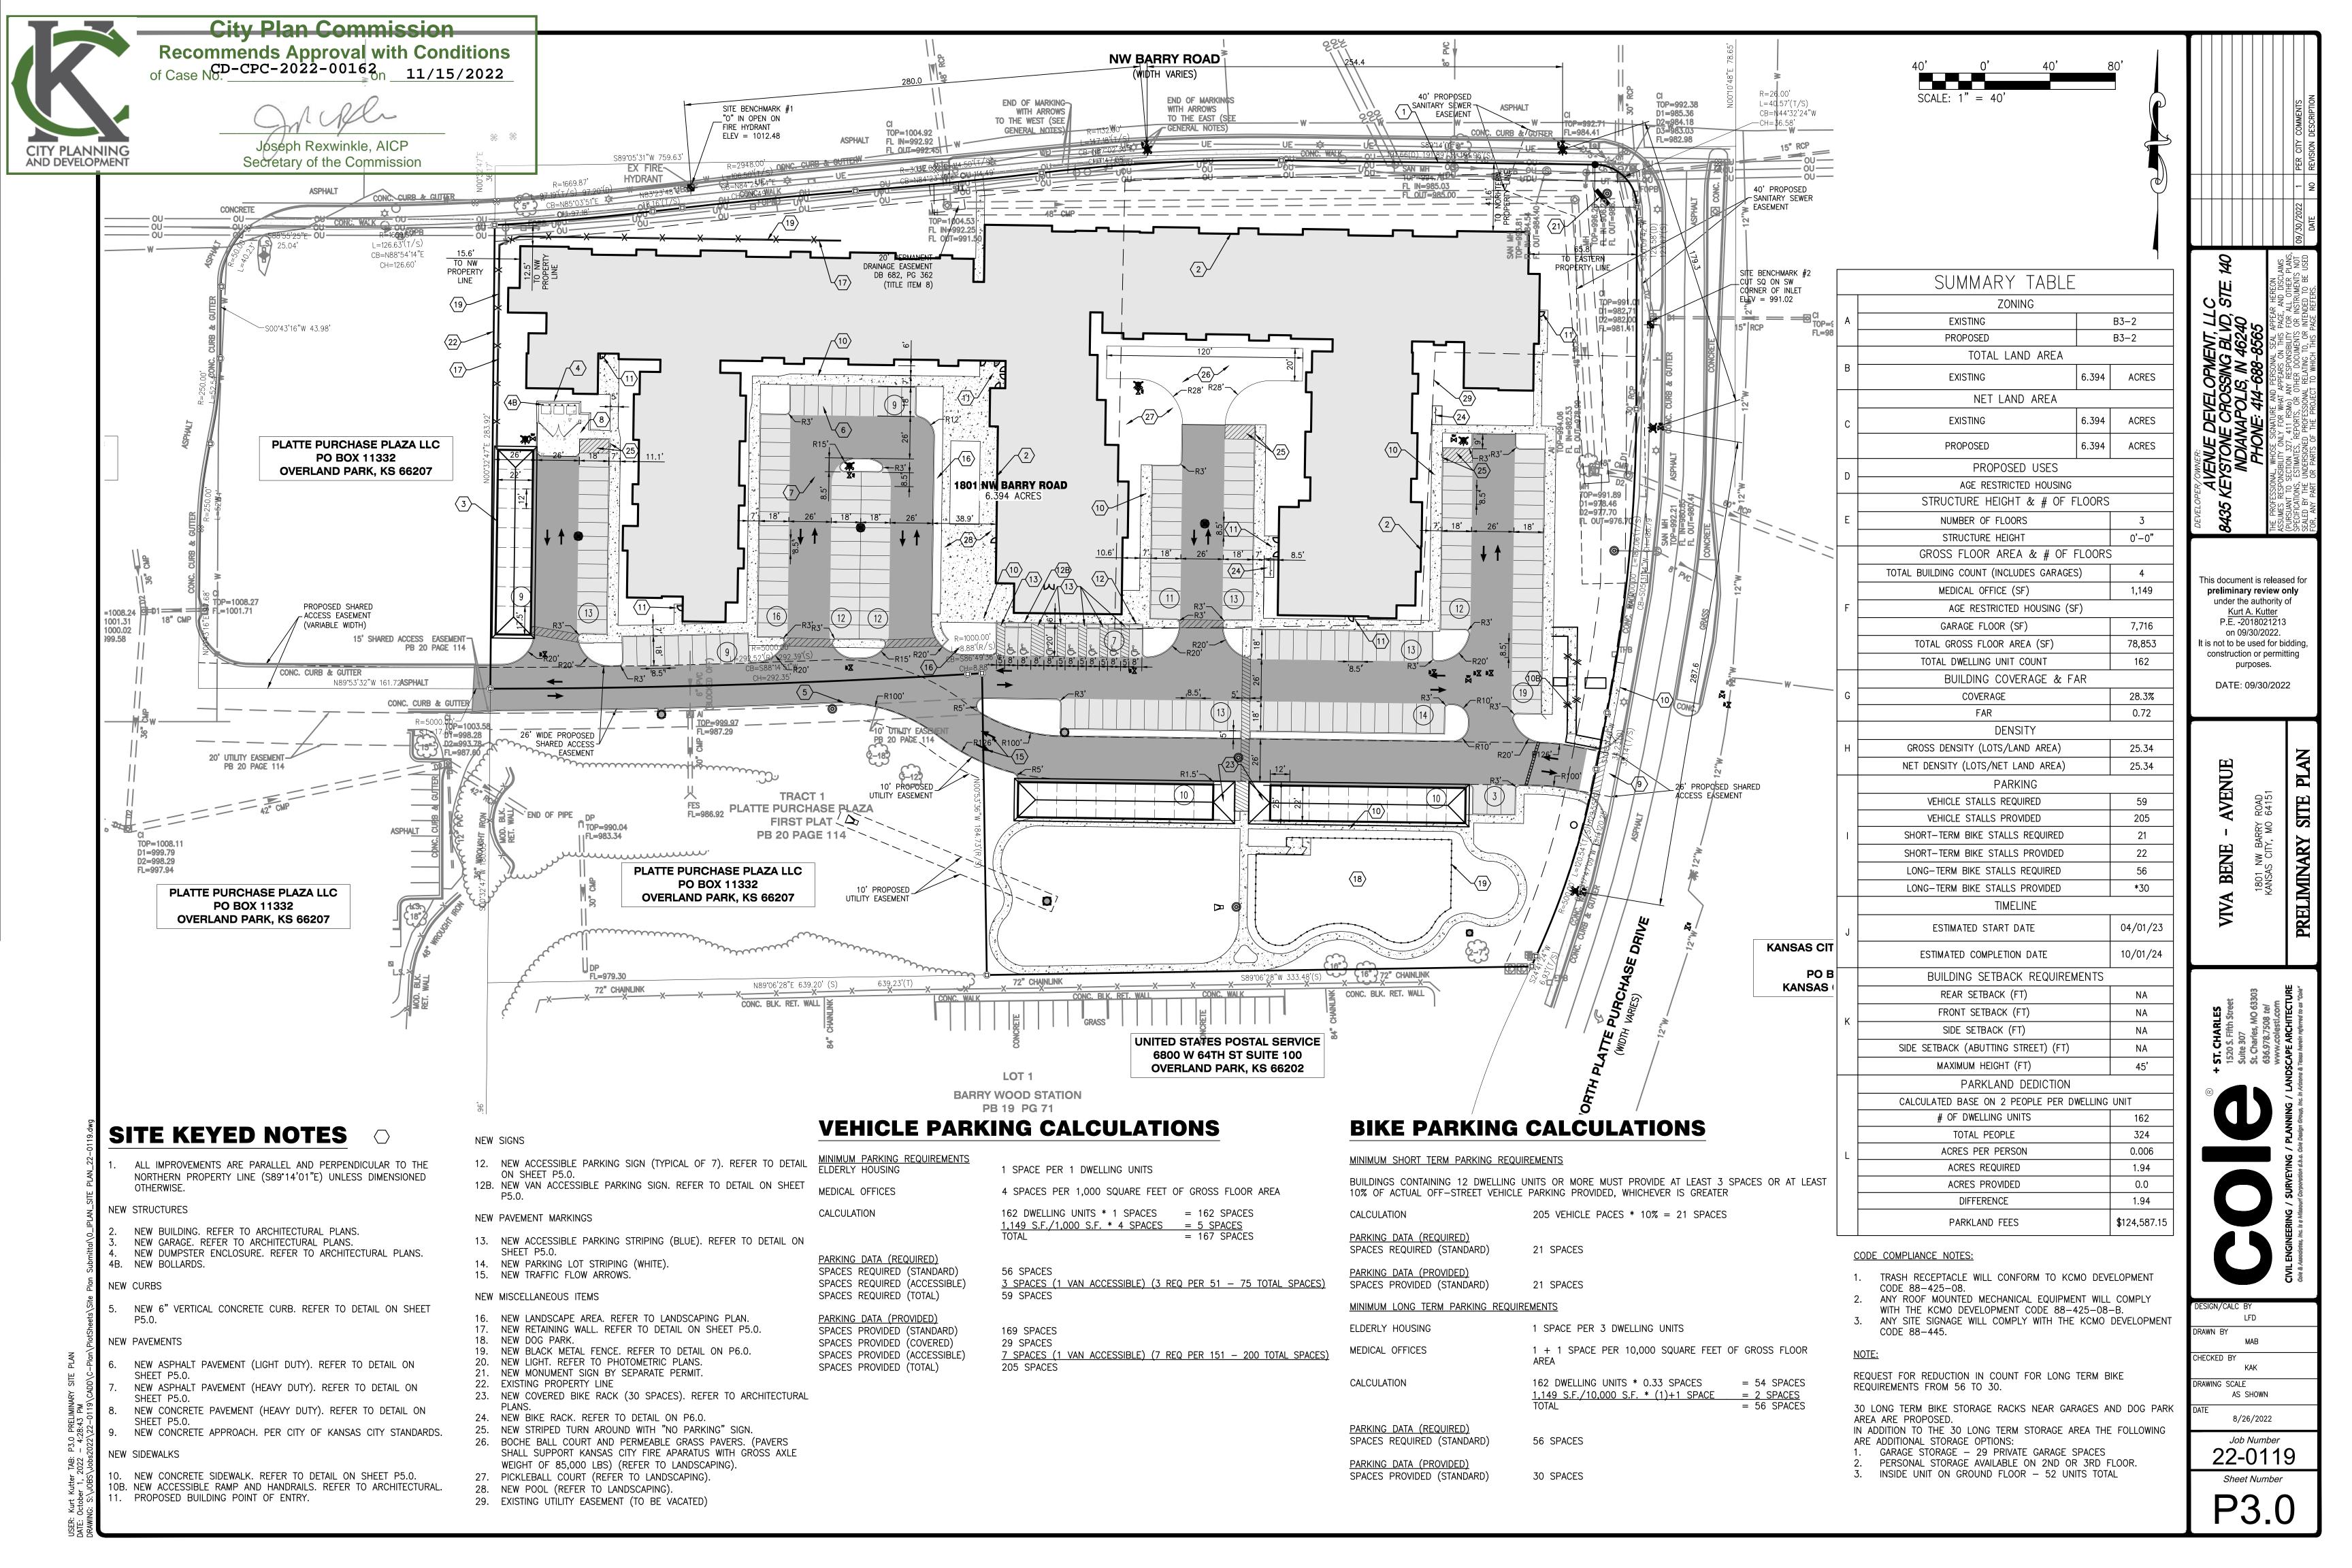

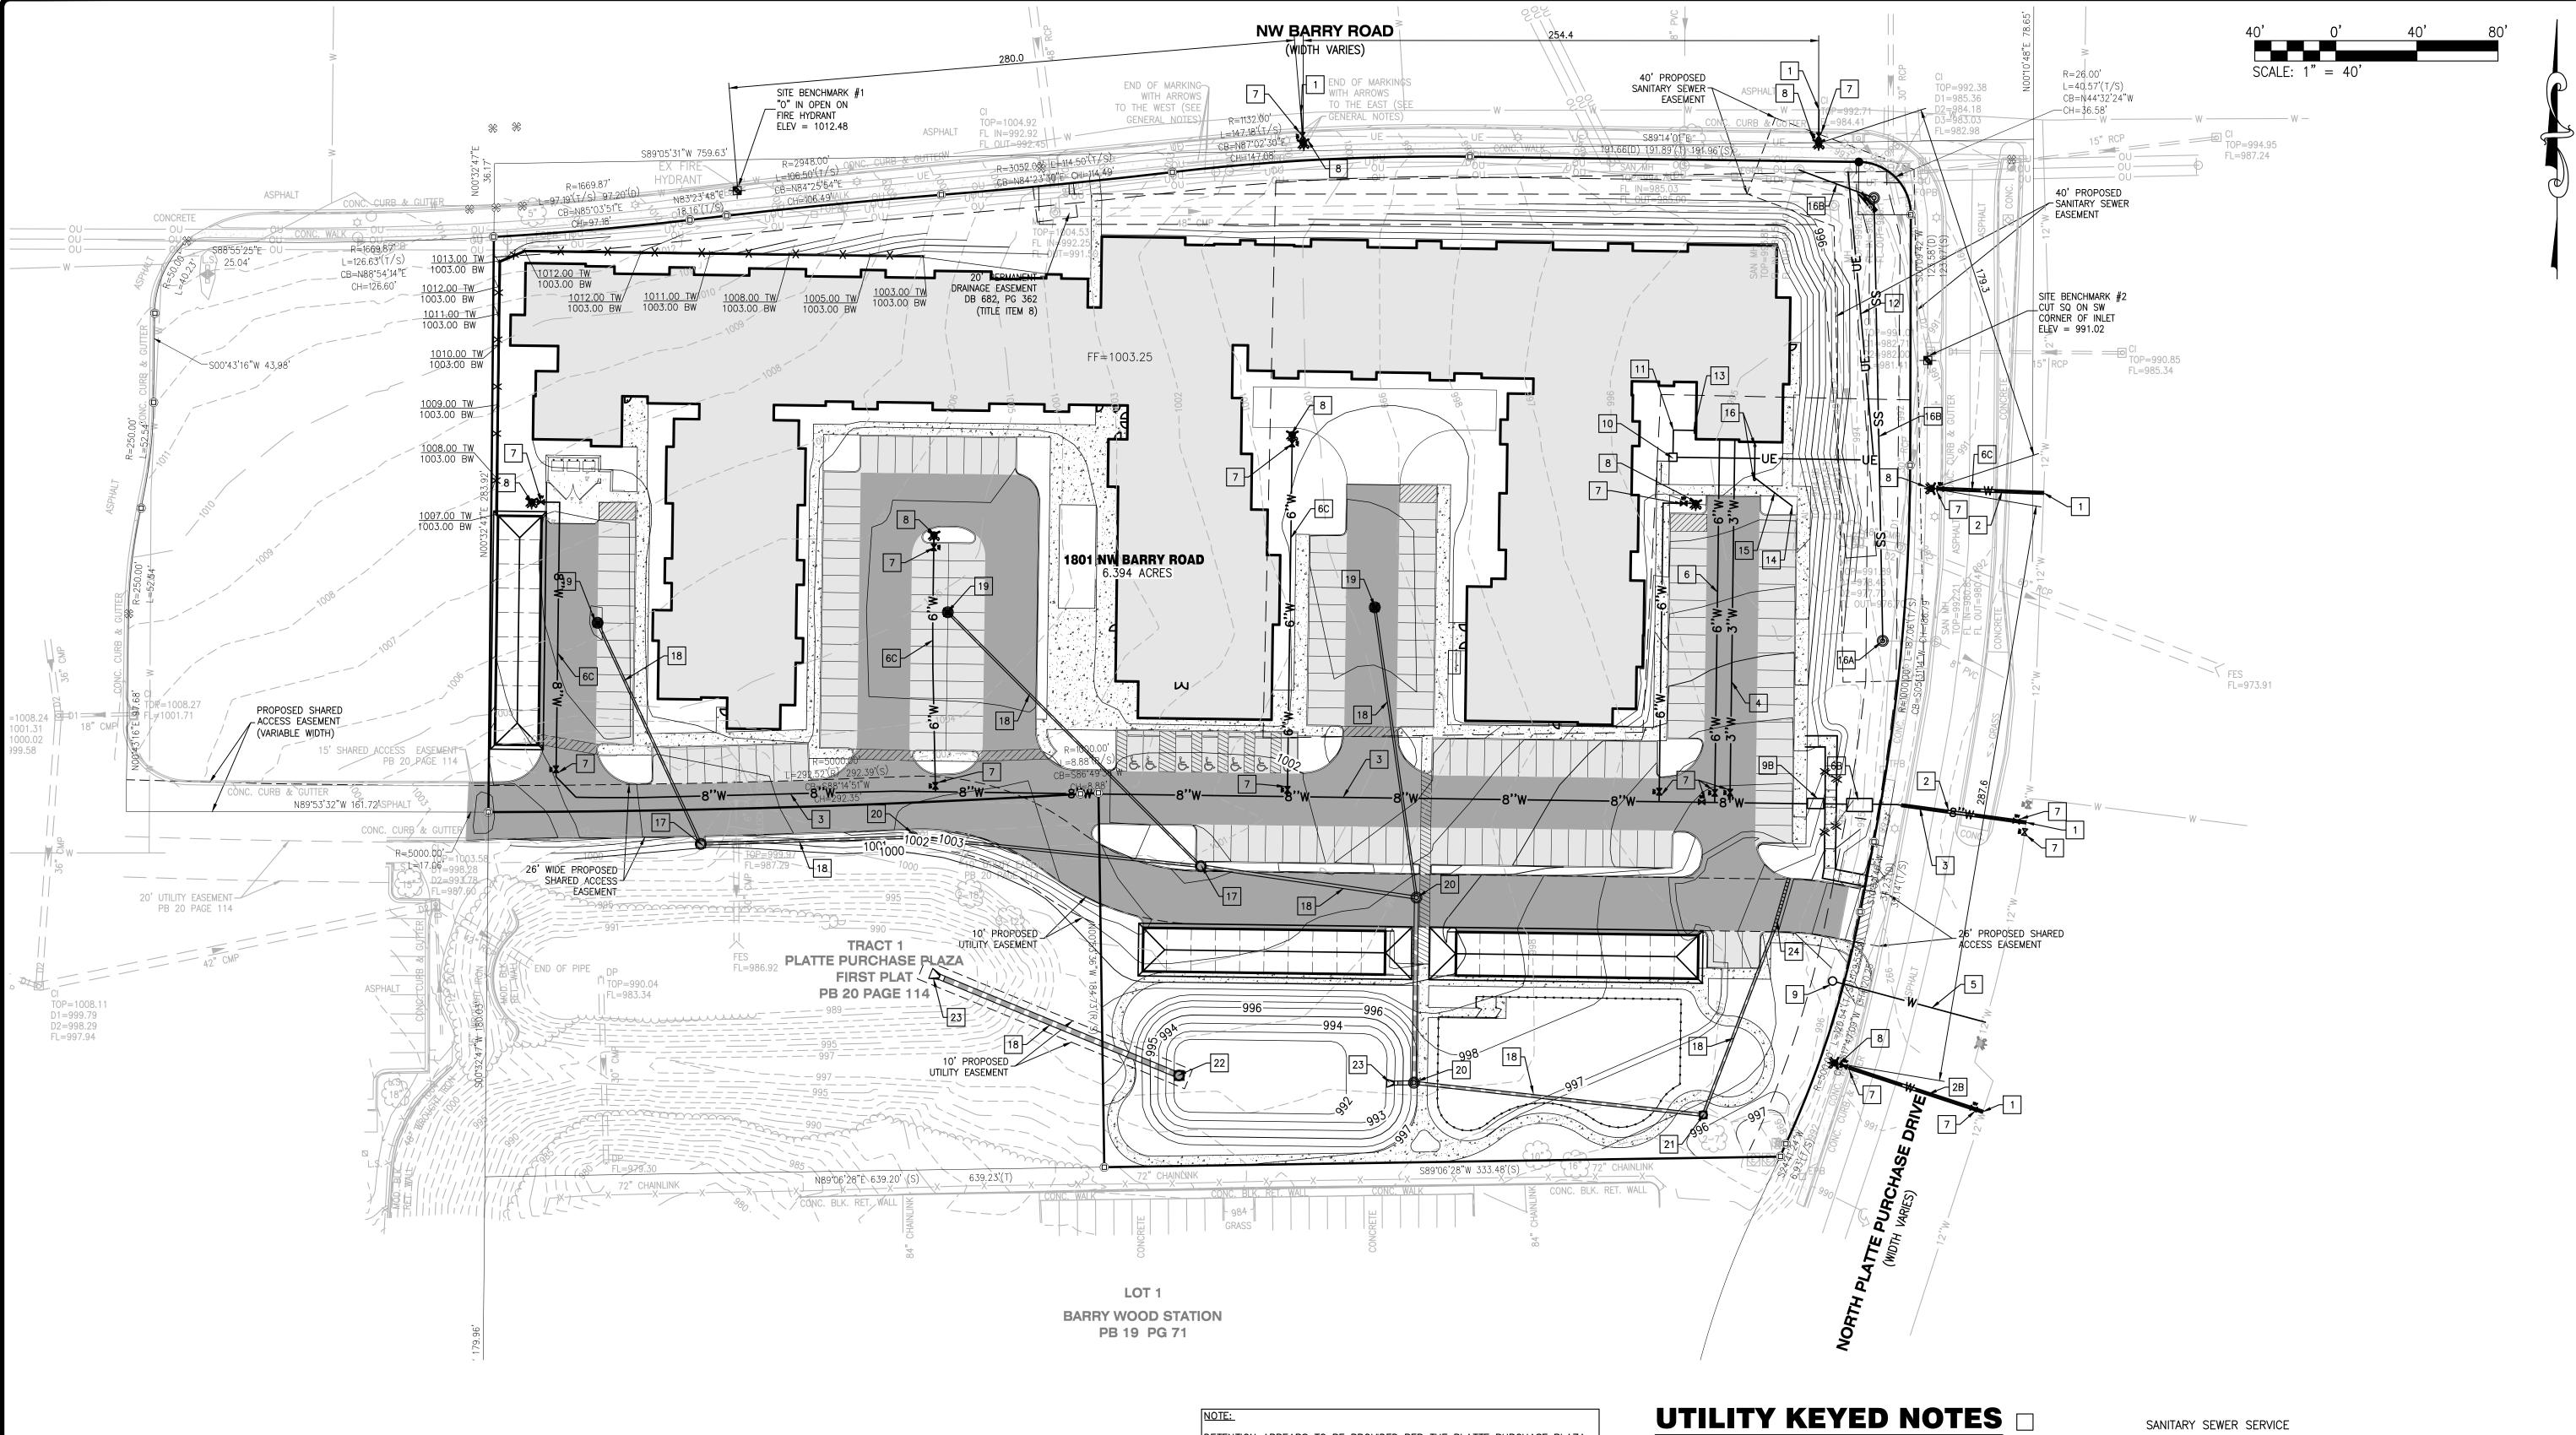

DETENTION APPEARS TO BE PROVIDED PER THE PLATTE PURCHASE PLAZA MACRO DRAINAGE STUDY IN THE EXISTING BASIN TO THE SOUTH WEST OF THE SITE. THE EXISTING BASIN WILL BE ANALYZED FOR REMAINING CAPACITY AND IF REQUIRED, MODIFICATIONS WILL BE PERFORMED ACCORDINGLY. STORM WATER QUALITY WILL BE PROVIDED VIA AN ONSITE BIORETENTION BASIN, PERVIOUS PAVEMENT, PROPRIETARY DEVICE OR COMBINATION THEREOF AND SPECIFIED IN A MICRO DRAINAGE REPORT PER

WATER SERVICE

- NEW WATER SERVICE POINT OF CONNECTION TO EXISTING WATER MAIN.
- NEW 8" WATER BORE AND PIPE ENCASEMENT PER CITY OF KANSAS CITY
- NEW 6" WATER BORE AND PIPE ENCASEMENT PER CITY OF KANSAS CITY
- STANDARDS. NEW PRIVATE 8" WATER MAIN.
- NEW PRIVATE 3" DOMESTIC WATER SERVICE.
- NEW 1" WATER BORE PER CITY OF KANSAS CITY STDS. . NEW PRIVATE 6" FIRE SERVICE.
- 6B. NEW 8" WATER METER AND BACKFLOW IN HEATED ENCLOSURE PIT PER CITY OF KANSAS CITY STANDARDS.
- 6C. NEW PRIVATE 6" WATER MAIN.
- NEW GATE VALVE. NEW PUBLIC FIRE HYDRANT PER CITY OF KANSAS CITY STANDARDS.
- 8B. NEW PRIVATE FIRE HYDRANT PER CITY OF KANSAS CITY STANDARDS. NEW 1" TAP AND IRRIGATION METER PER CITY OF KANSAS CITY STANDARDS.
- 9B. NEW DOUBLE CHECK VALVE AND BACKFLOW PREVENTER ENCLOSURE.

- 10. NEW TRANSFORMER AND PAD.
- 11. NEW SECONDARY ELECTRIC SERVICE. 12. NEW PRIMARY ELECTRIC SERVICE. 13. NEW ELECTRIC METERS.

ELECTRIC SERVICE

- 14. NEW WYE CONNECTION TO EXISTING SANITARY MAIN.
- 15. NEW 6" SDR35 SANITARY SEWER LATERAL AT 2.0% MIN SLOPE.
- 16. NEW SANITARY CLEANOUT, TYP.
- 16A. NEW SANITARY MANHOLE. 16B. NEW 8" SDR 26 SANITARY SEWER.

STORM SEWER SERVICE

- 17. NEW STORM SEWER CURB INLET.
- 18. NEW STORM SEWER.
- 19. NEW STORM SEWER GRATED INLET.
- 20. NEW STORM SEWER MANHOLE. 21. NEW NYLOPLAST YARD DRAIN.
- 22. NEW OUTFALL STRUCTURE.
- 23. NEW FLARED END SECTION.

24. NEW TRENCH DRAIN.

ALL PROPOSED WATER AND FIRE SERVICE LINES SHOULD MEET

CURRENT WATER SERVICES DEPARTMENT RULES AND REGULATIONS. ALL PROPOSED WATER LINES SHALL HAVE A COVER OF NOT LESS THAN 4 FEET NOR MORE THAN 5 FEET.

CITY PLANNING AND DEVELOPMENT

City Plan Commission
Recommends Approval with Conditions
of Case No. CD-CPC-2022-00162 on 11/15/2022

Joseph Rexwinkle, AICP Secretary of the Commission 22-0119 Sheet Number

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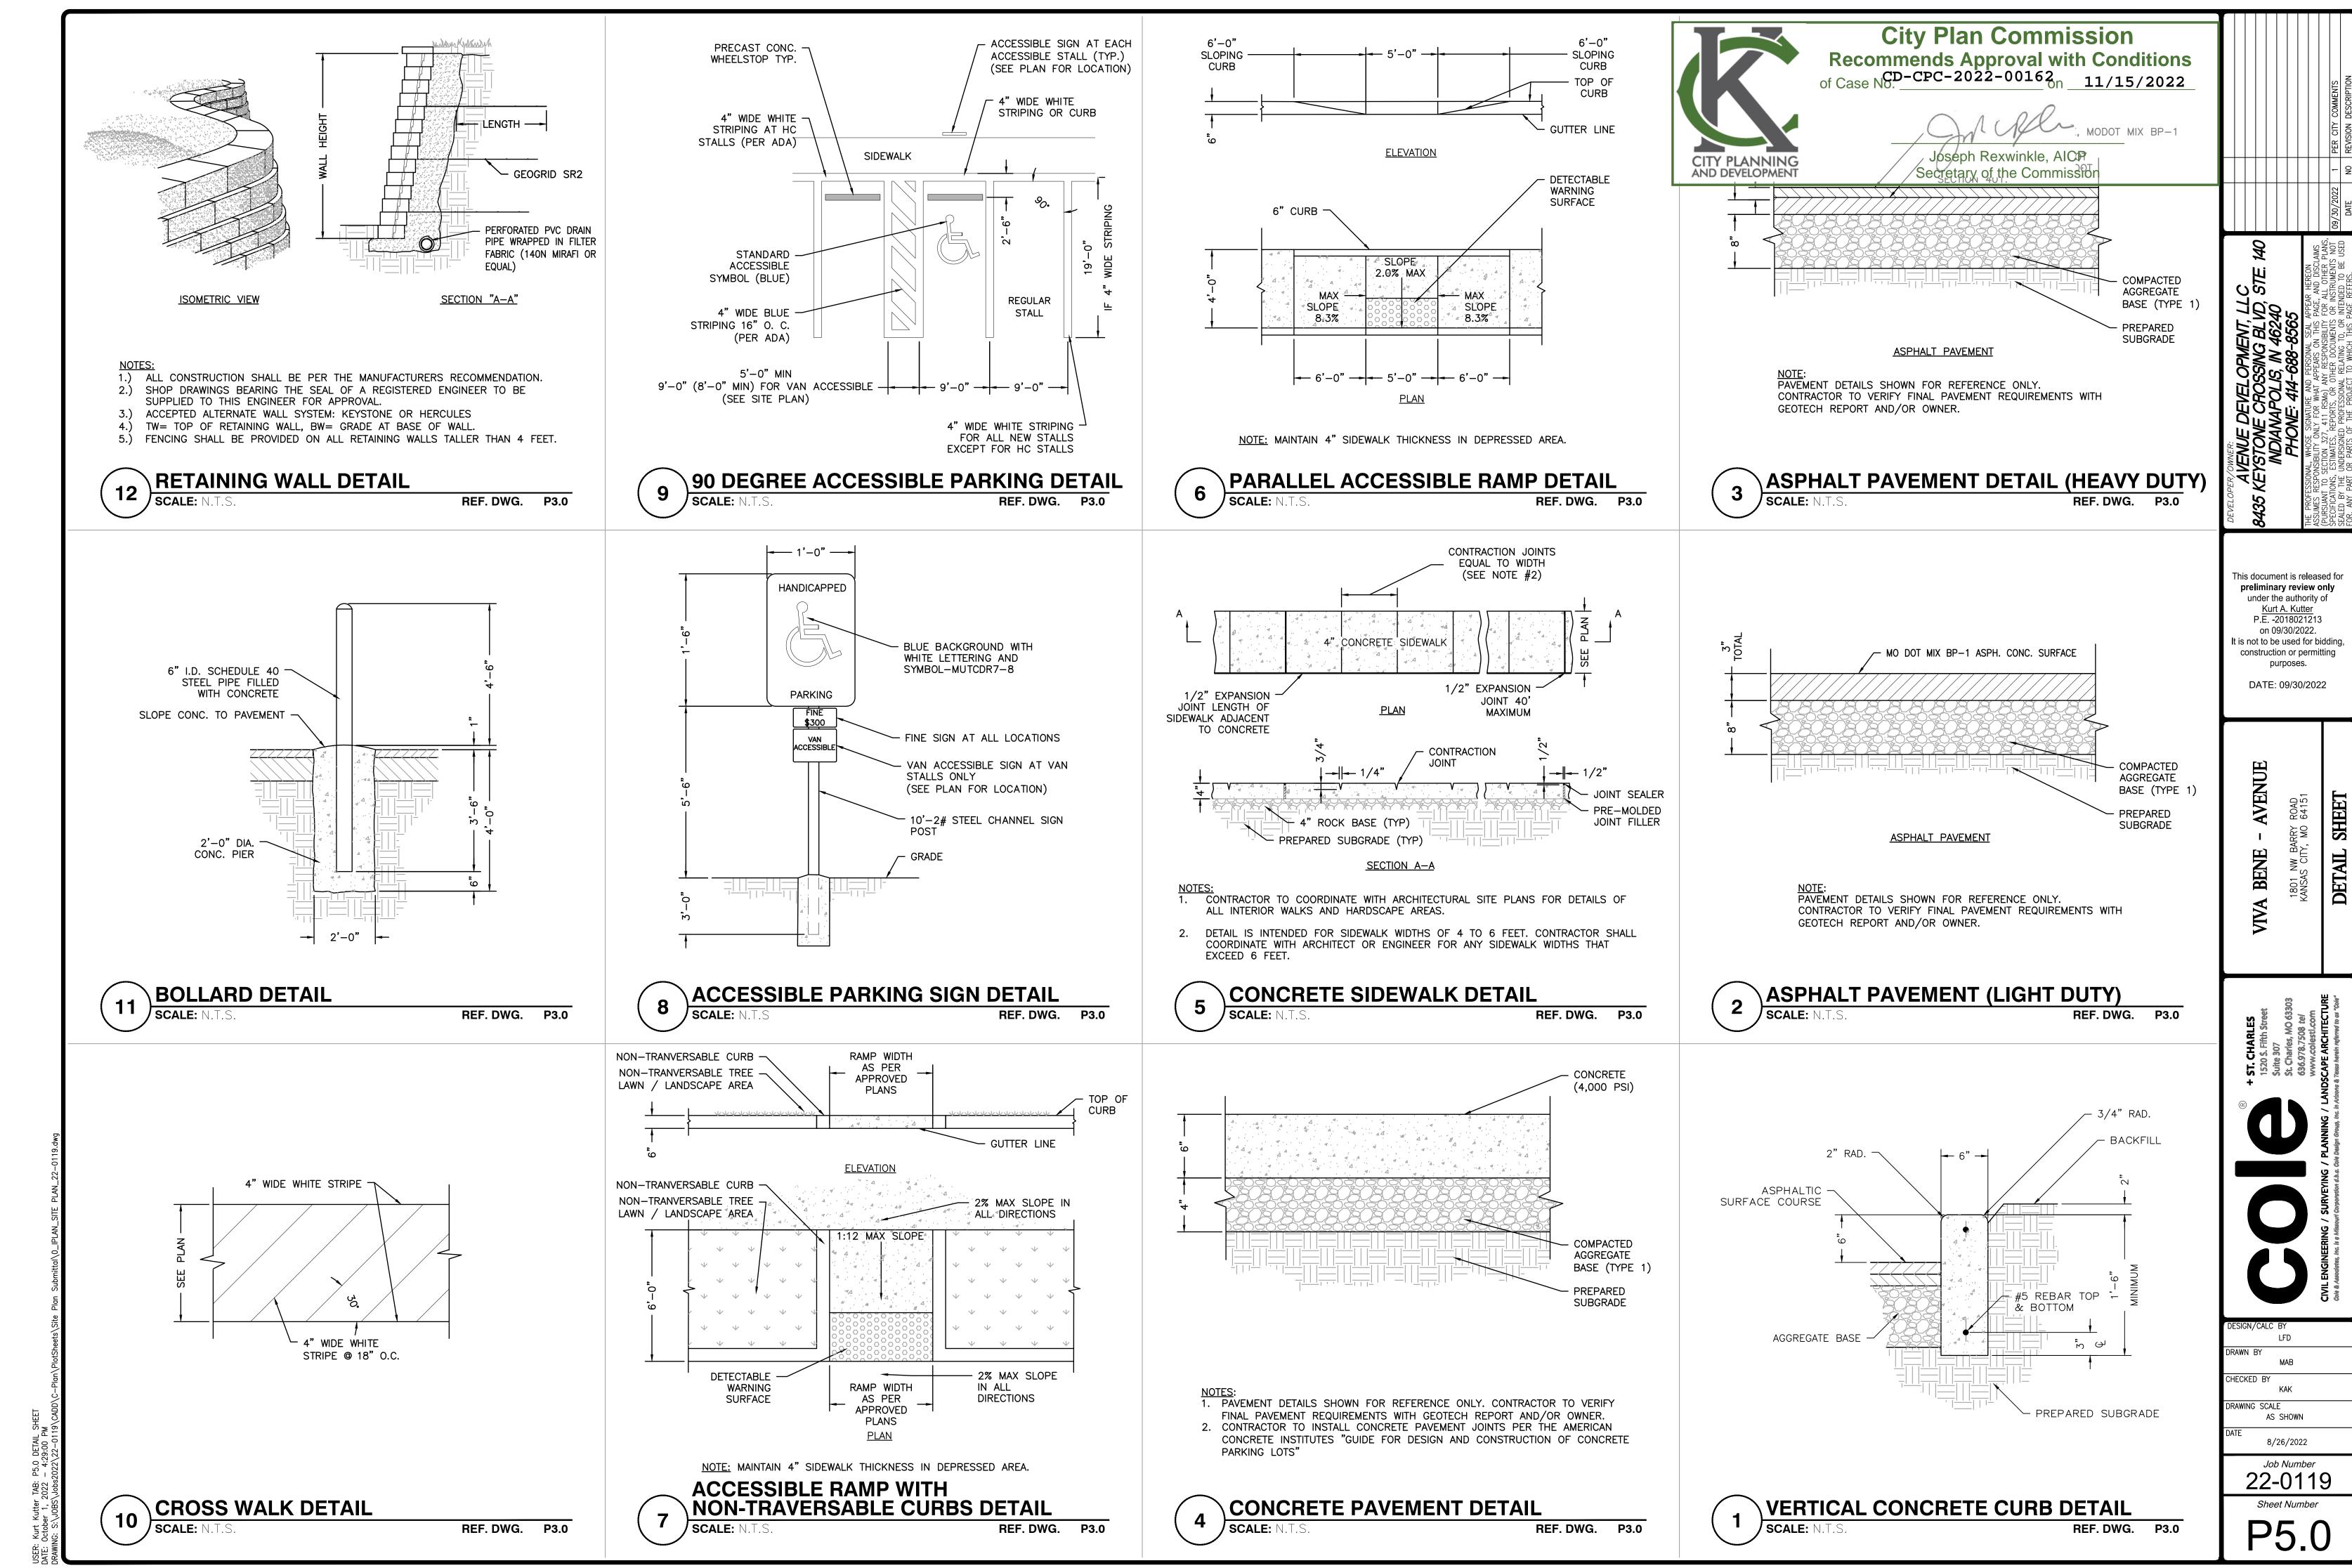
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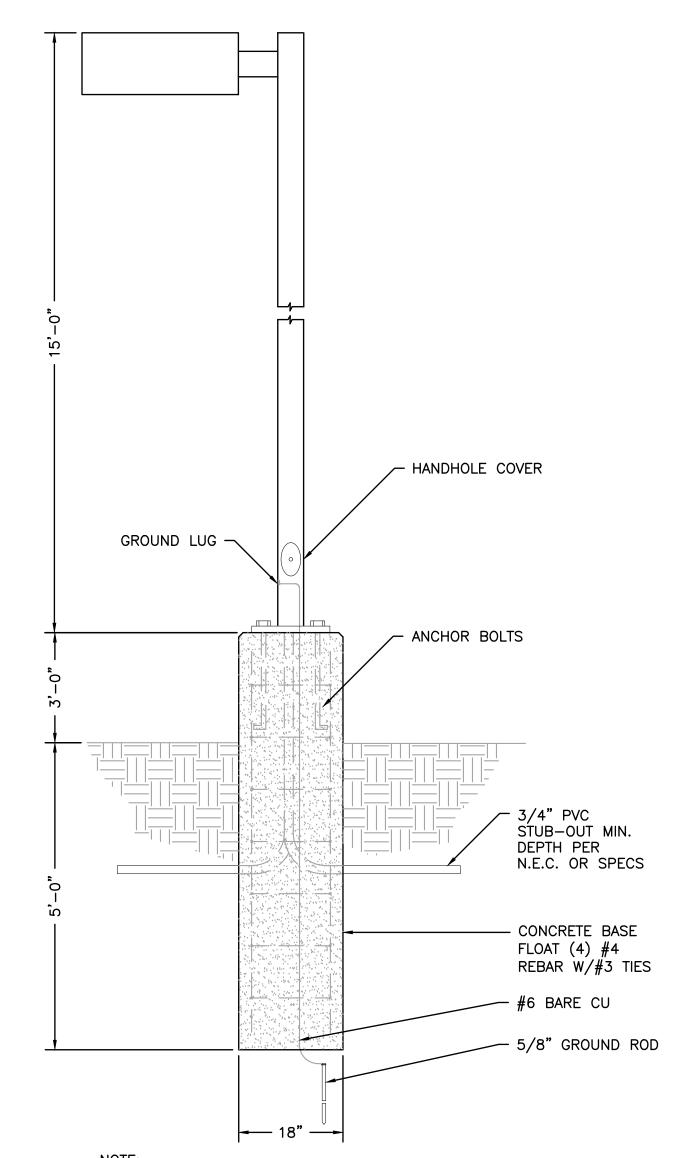
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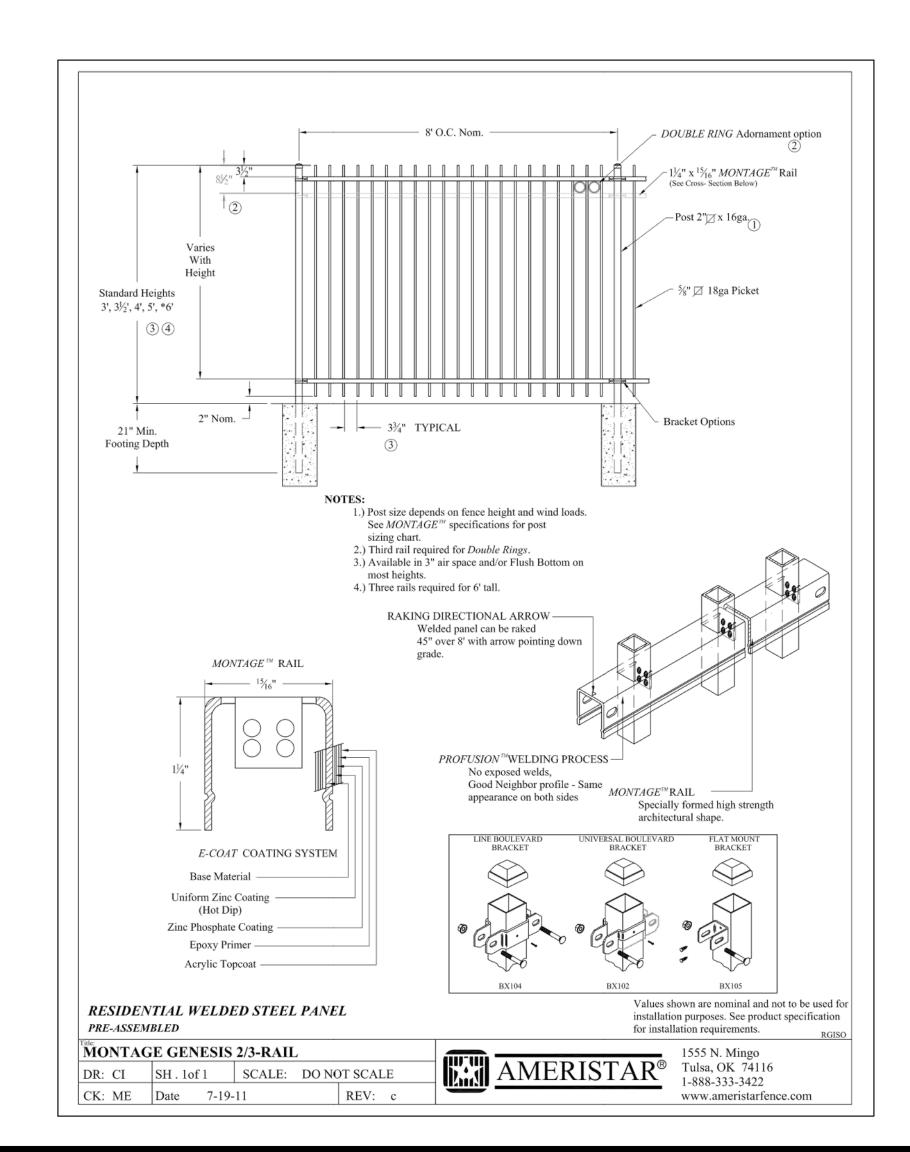
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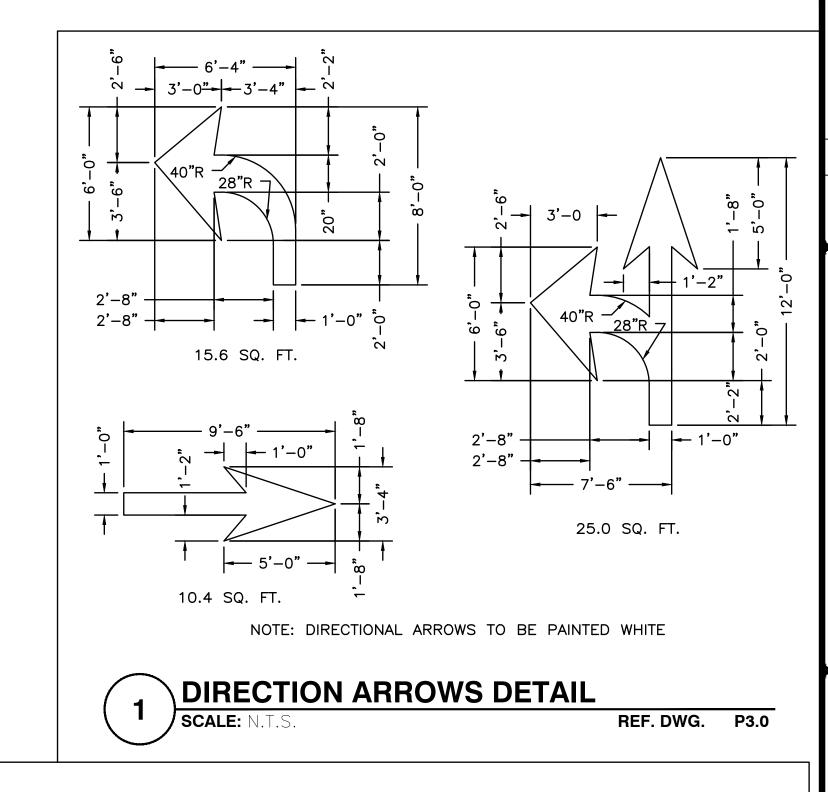
Joseph Rexwinkle, AICP Secretary of the Commission



LIGHT POLE BASE SHOWN FOR REFERENCE ONLY. SIZE, EMBEDMENT DEPTH AND REINFORCEMENT SHALL BE PER STRUCTURAL ENGINEER.









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NOTES:

- INSTALLATION TO BE COMPLETED IN ACCORDANCE WITH MANUFACTURER'S SPECIFICATIONS.
 ALL DIMENSIONS ARE CONSIDERED TRUE AND REFLECT MANUFACTURER'S SPECIFICATIONS.
- 3. DO NOT SCALE DRAWING.
- 4. CONTRACTOR'S NOTE: FOR PRODUCT AND COMPANY INFORMATION VISIT www.CADdetails.com/info REFERENCE NUMBER 4349-013.

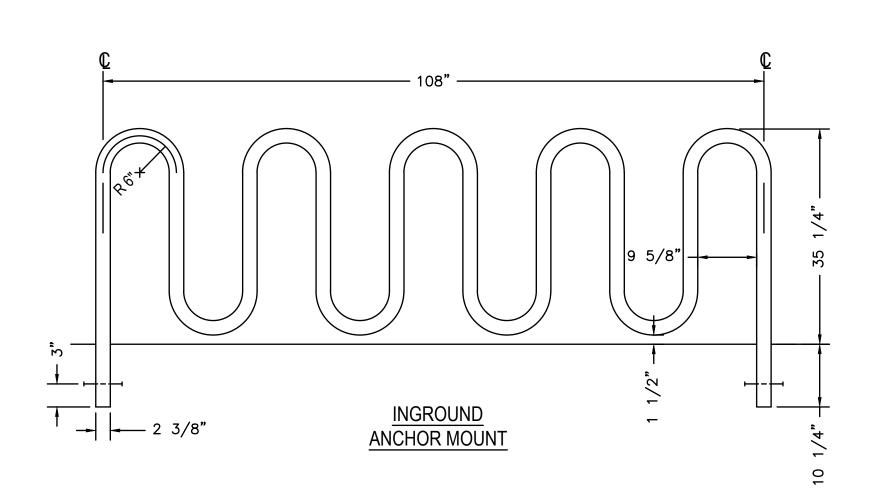

4349-013

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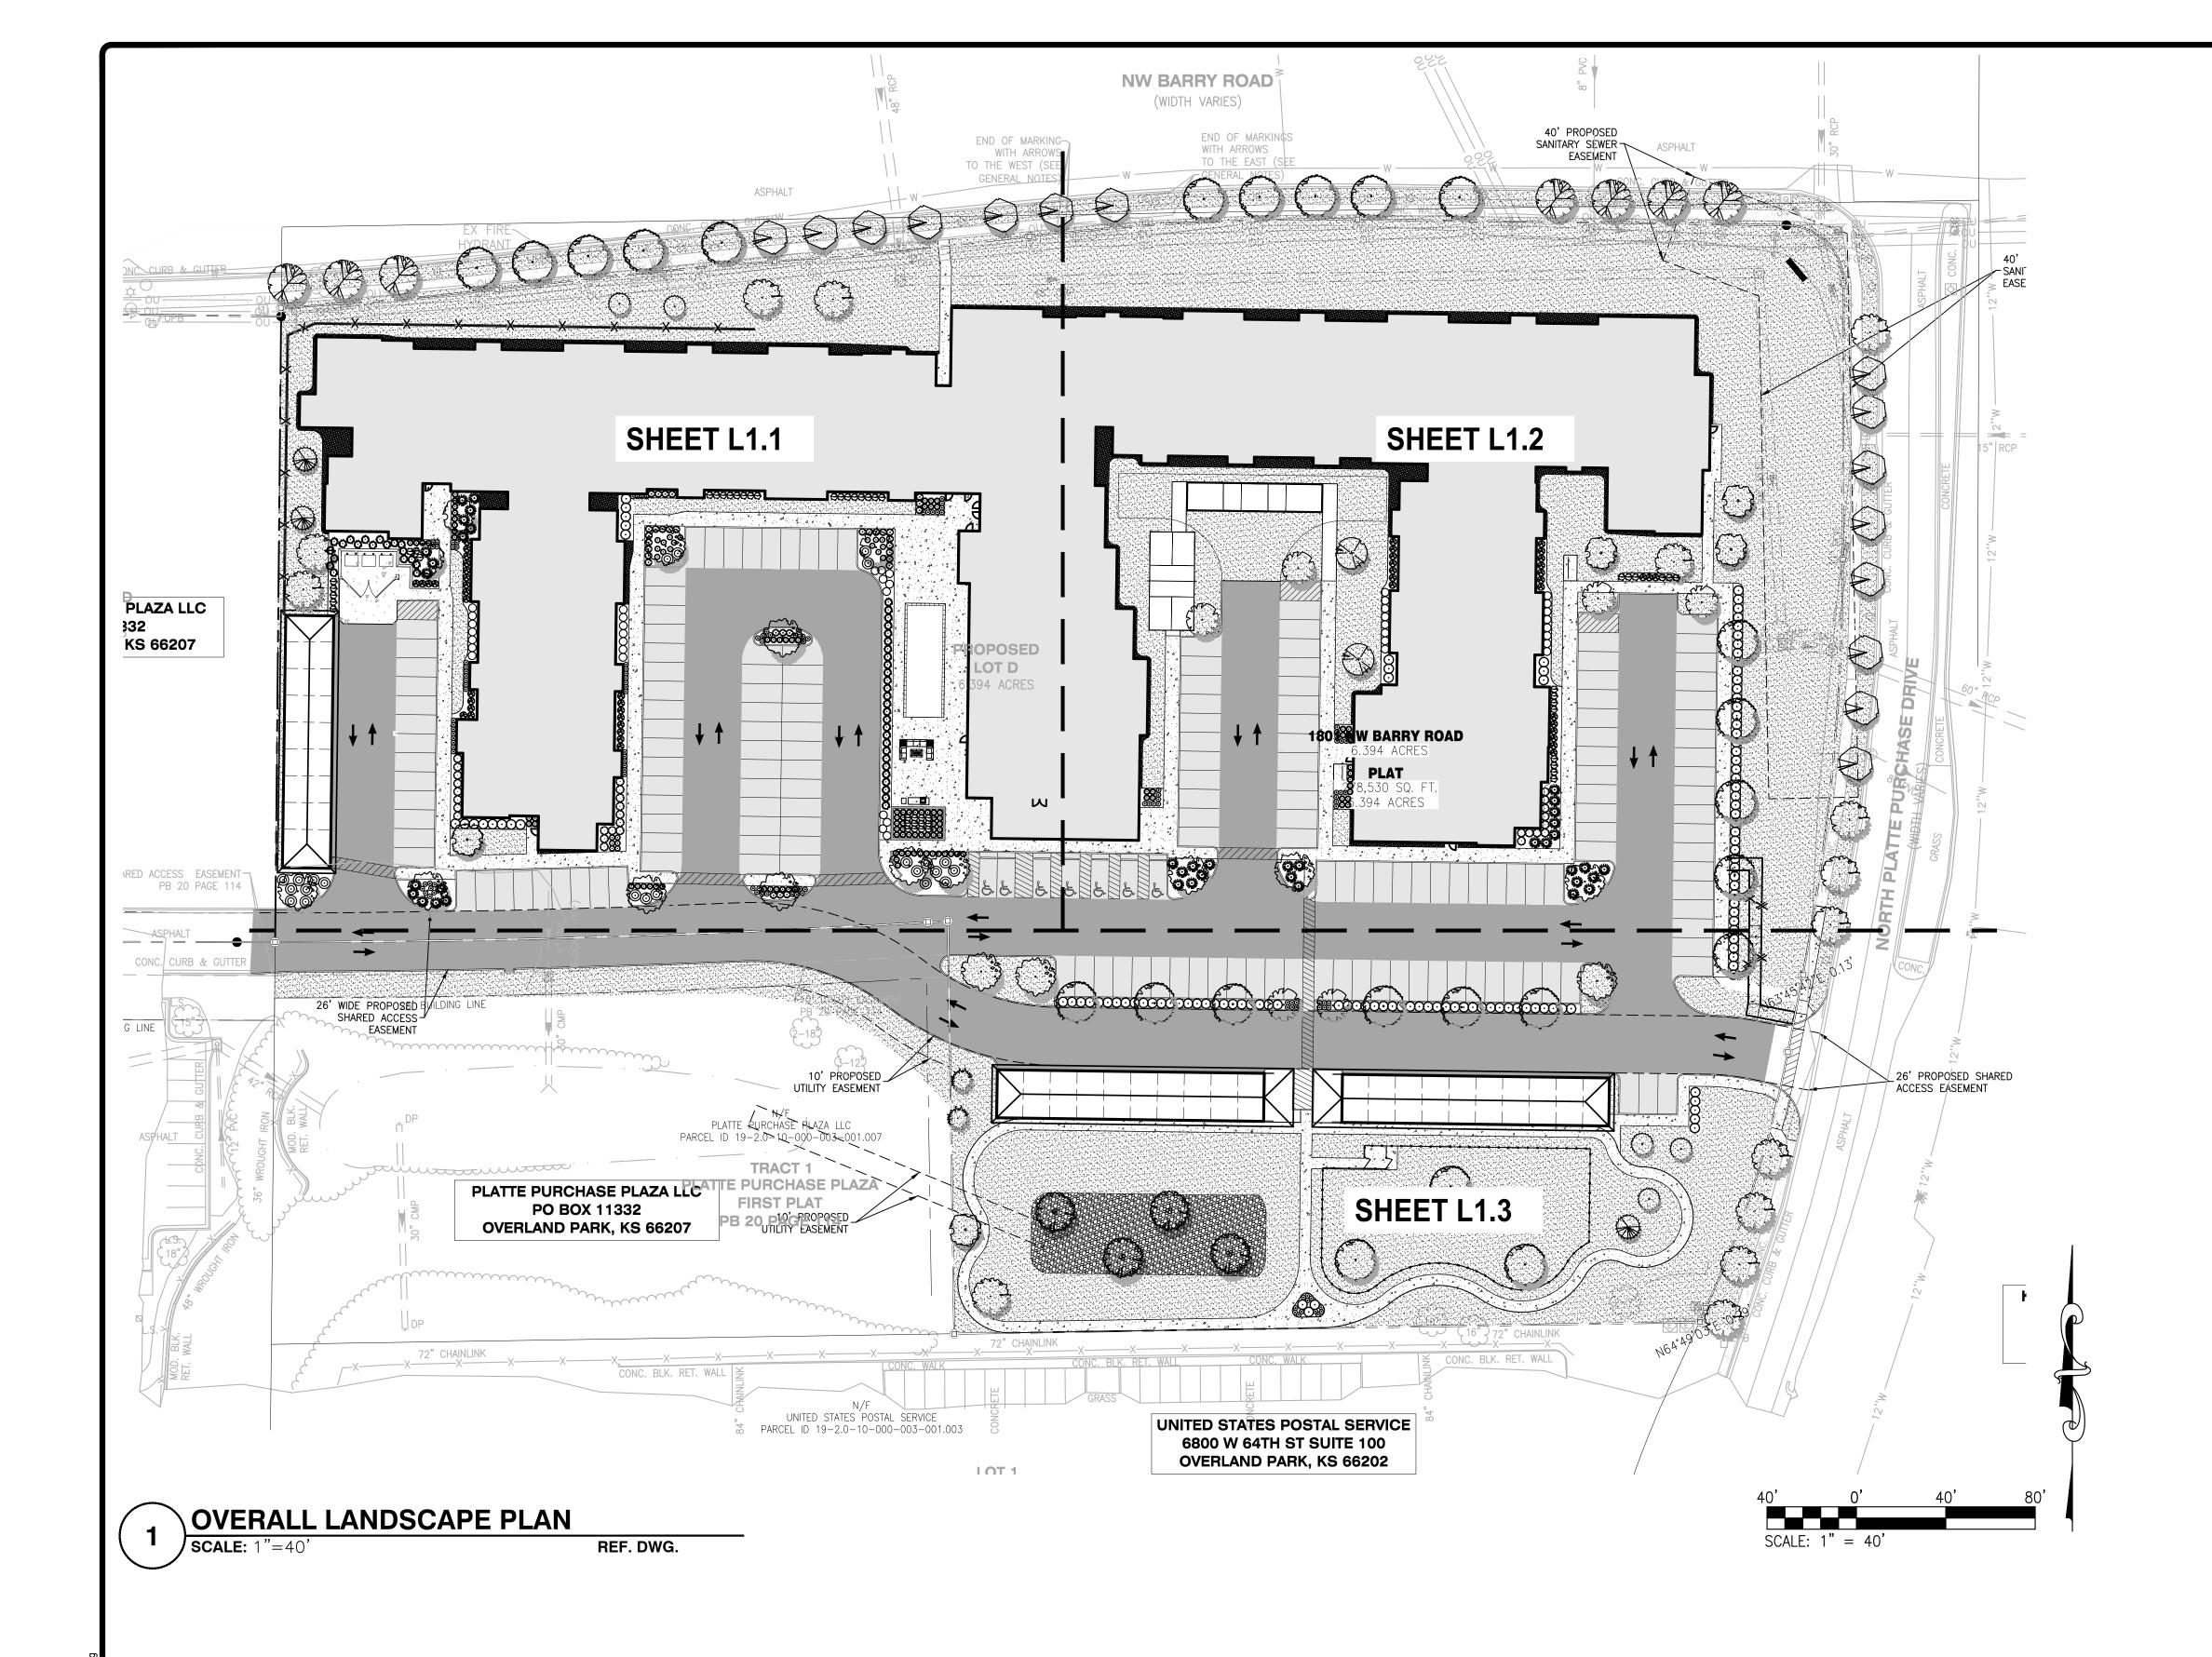
8/26/2022

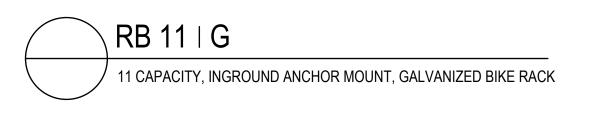Job Number **22-0119**

P6 0

Sheet Number

JSER: Kurt Kutter 1AB: P6.0 DETAIL SHEET NATE: October 1, 2022 – 4:29:05 PM NAWING: S:\.IORS\.Jobs2022\.22-0119\.CADD\.C-Plan\.PlotShee



LARGE & MEDIUM	DOTANICAL NAME	COMMONIANAE
DECIDUOUS TREES	BOTANICAL NAME	COMMON NAME
	Acer rubrum 'red sunset'	Rd Maple
	Quercus rubra	Red Oak
(· · · · · · · · · · · · · · · · · · ·	Zelkova serrata 'JFS-KW1'	City Sprite zelkova
	Tilia americana	American Linden
Example 1	Betula nigra 'BNMTF'	Dura Heat®River Birch
EVERGREEN TREES	BOTANICAL NAME	COMMON NAME
	Pinus echinata	Short—Leaf Pine
Market Ma	Juniperus virginiana	Red Cedar
•	Thuja 'Green Giant'	Arborvitae
SMALL DECIDUOUS TREES	BOTANICAL NAME	COMMON NAME
	Cornus florida	Flowering Dogwood
	Cercis canadensis	Red Bud
	Amelanchier x grandiflora 'Autumn Brilliance'	Autumn Brilliance®Apple Serviceberry
	Carpinus caroliniana	American Hornbeam
SHRUBS	BOTANICAL NAME	COMMON NAME
0	Buxus x 'Green Velvet'	Green Velvet Boxwood
	Taxus ×media	Yew
	Physocarpus opulifolius	Tiny Wine Ninebark
0	Juniperus ×pfitzeriana 'Sea Green'	Chinese Juniper
	ITEA VIRGINICA 'LITTLE HENRY'	'LITTLE HENRY' SWEET SPIRE
(· · · · · · · · · · · · · · · · · · ·	Ceanothus americanus	New Jersey Tea
and of the second of the secon	Thuja occidentalis 'Smaragd'	Emerald Green Arborvitae
(O)	Rhus aromatica 'Gro—Low'	Gro-Low Fragrant Sumac
$\overline{\bigcirc}$	Spiraea japonica	Japanese spirea
ORNAMENTAL GRASS & GROUND COVER	BOTANICAL NAME	COMMON NAME
(•)	Schizachyrium scoparium	Little Bluestem
	Sorghastrum nutans	Indiangrass
	Juniperus procumbens 'Green Mound'	Green Mound Juniper
√ mo	MOUTIU	AREA TO BE TURF
KKRR		DECORATIVE GRAVEL

PLANT SCHEDULE

* SEE SHEET L1.4 FOR LANDSCAPE NOTES, CALCULATIONS AND FULL PLANT SCHEDULE WITH QUANTITIES

VEHICLE PARKING CALCULATIONS

MINIMUM PARKING REQUIREMENTS ELDERLY HOUSING

1 SPACE PER 3 DWELLING UNITS

MEDICAL OFFICES 4 SPACES PER 1,000 SQUARE FEET OF GROSS FLOOR AREA CALCULATION

162 DWELLING UNITS * 0.33 SPACES = 54 SPACES

<u>1,149 S.F./1,000 S.F. * 4 SPACES = 5 SPACES</u> TOTAL = 59 SPACES

PARKING DATA (REQUIRED) SPACES REQUIRED (STANDARD) SPACES REQUIRED (ACCESSIBLE)

SPACES REQUIRED (TOTAL)

PARKING DATA (PROVIDED) SPACES PROVIDED (STANDARD) SPACES PROVIDED (COVERED) SPACES PROVIDED (ACCESSIBLE) SPACES PROVIDED (TOTAL)

3 SPACES (1 VAN ACCESSIBLE) (3 REQ PER 51 - 75 TOTAL SPACES) 59 SPACES

205 SPACES

169 SPACES 29 SPACES 7 SPACES (1 VAN ACCESSIBLE) (7 REQ PER 151 - 200 TOTAL SPACES)

PERTINENT DATA

SITE ADDRESS = 1801 NW BARRY ROAD

KANSAS CITY, MO 64151

PARCEL ID FIRE DISTRICT KANSAS CITY FIRE DEPARTMENT

29095C0126G, DATE: JAN 20, 2017 FEMA MAP PANEL GROSS SITE AREA

= 6.394 AC.



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8/26/2022 Job Number 22-0119

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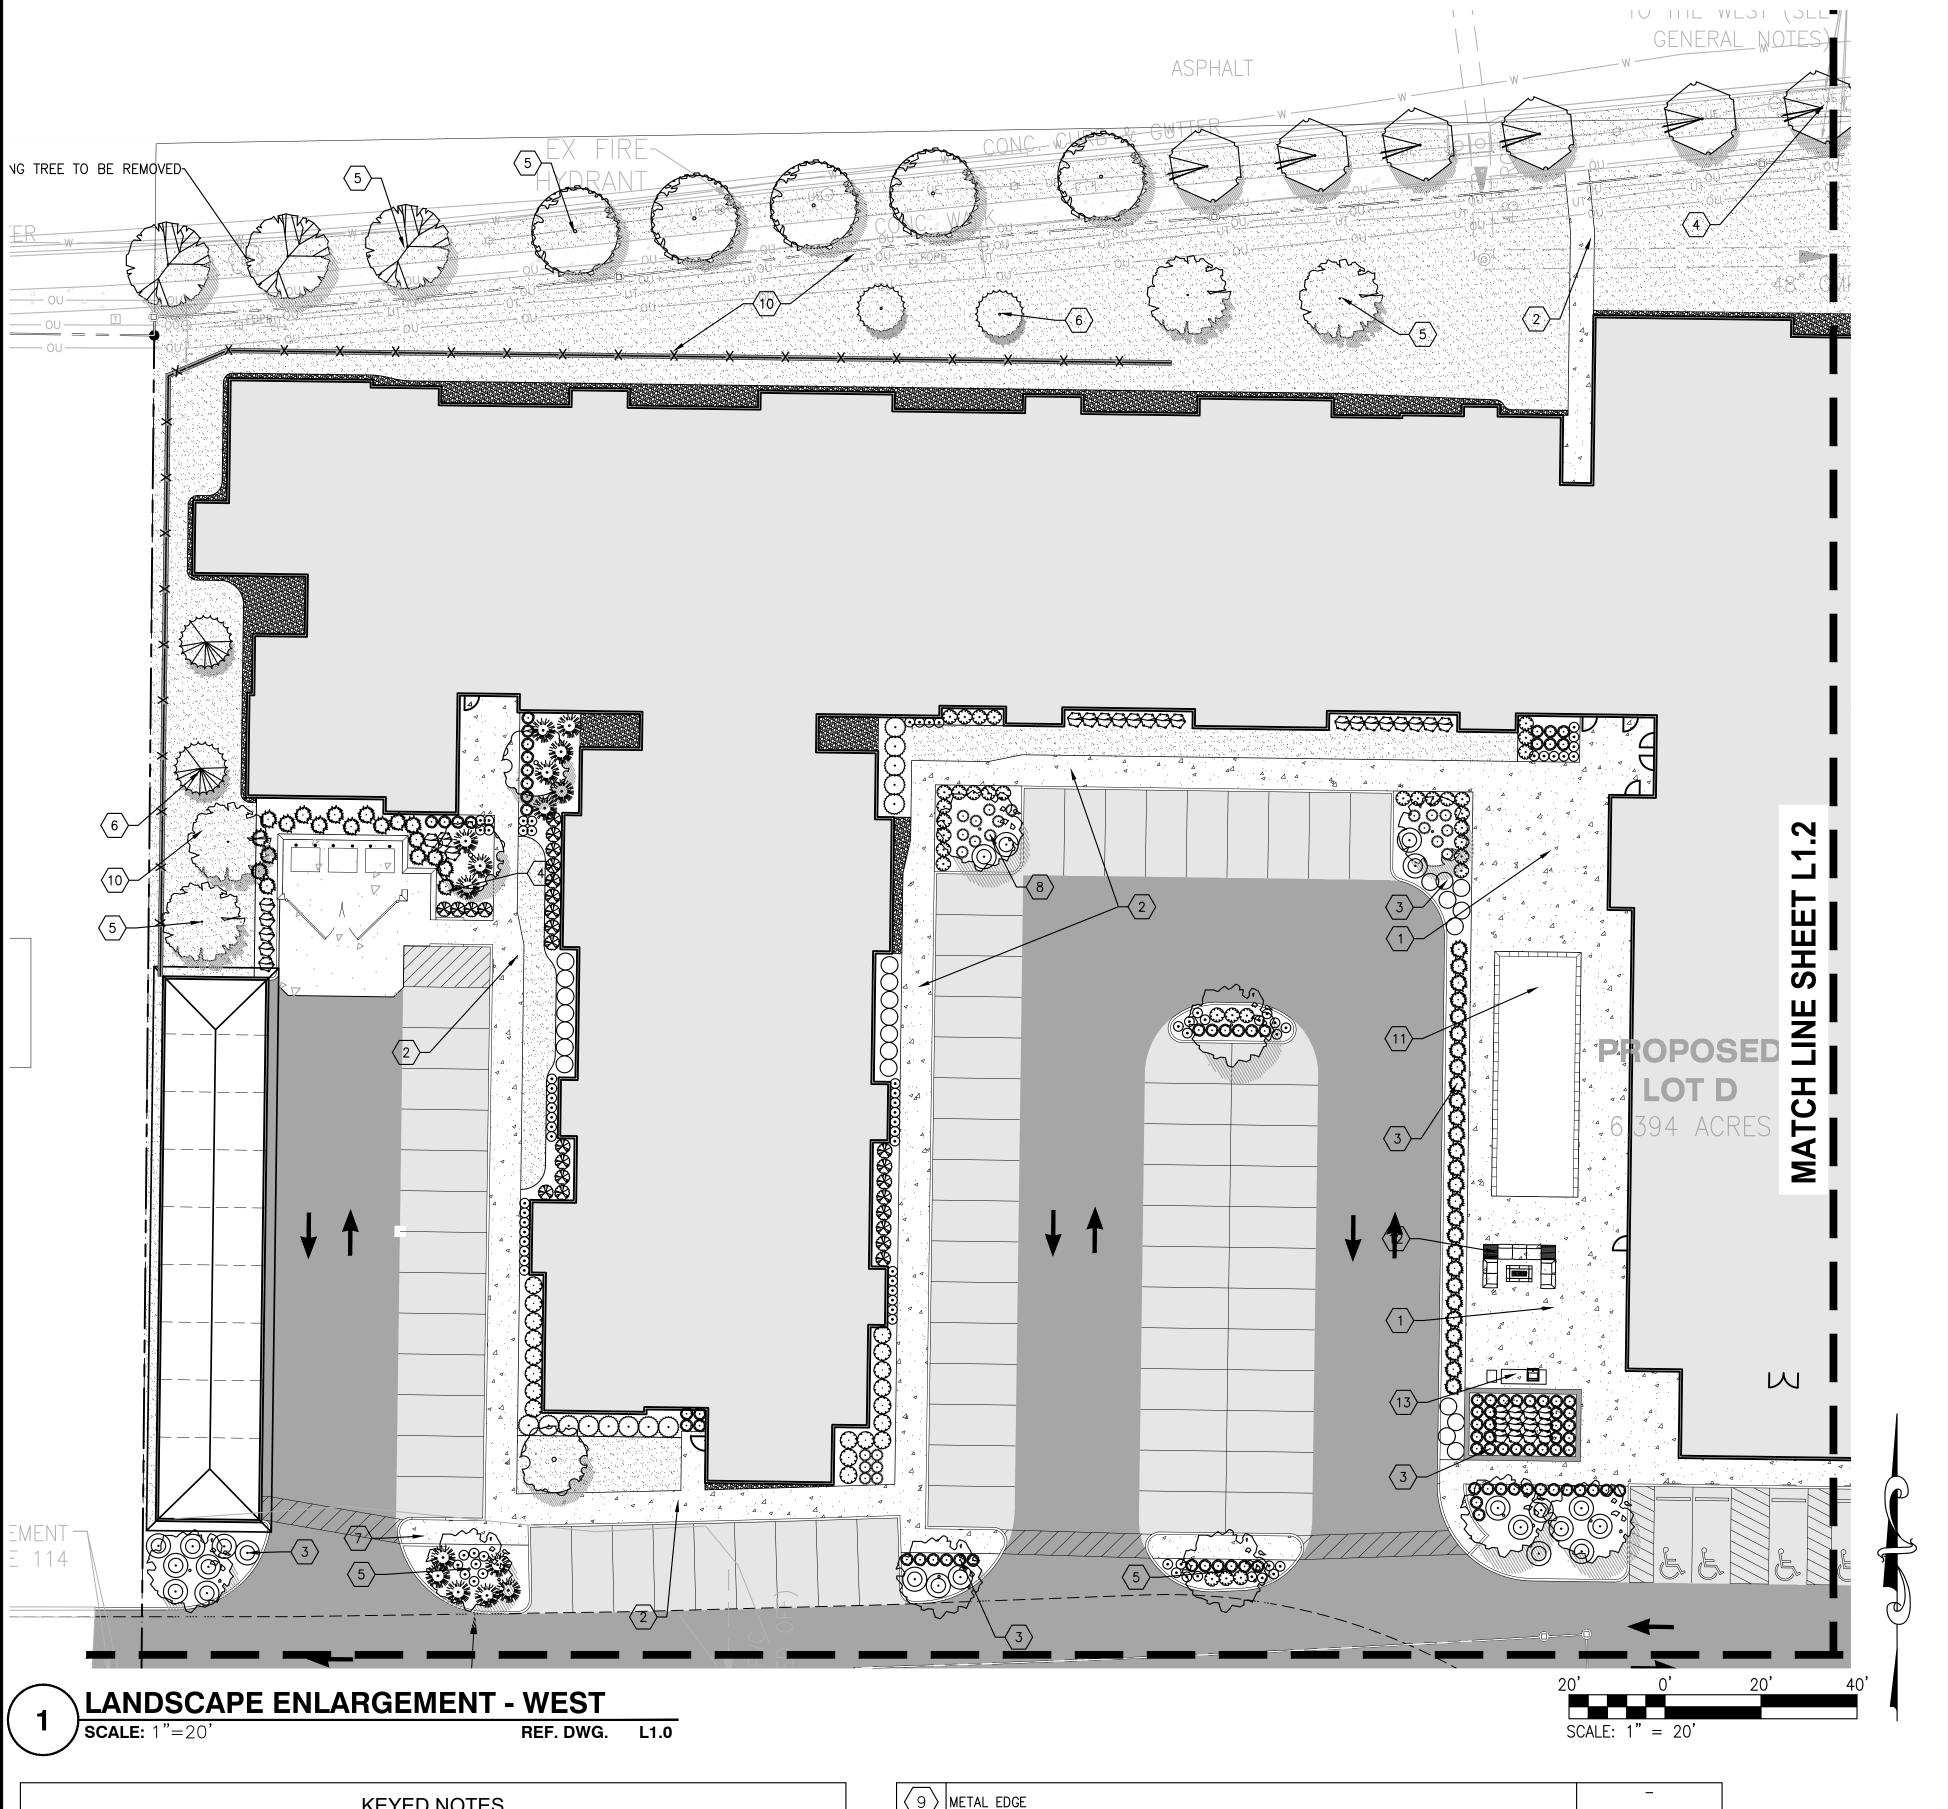
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	KEYED NOTES							
KEY	FURNISHING	DETAIL						
1	PATIO STANDARD CONCRETE WITH BROOM FINISH, SCORED PER PLAN HAND TOOLED OR MACHINE CUT	SEE CIVIL DRAWINGS						
2	CONCRETE SIDEWALK STANDARD CONCRETE WITH BROOM FINISH, SCORED PER PLAN, HAND TOOLED OR MACHINE CUT	SEE CIVIL DRAWINGS						
3	TYPICAL SHRUB PLANTING	_						
4	TYPICAL FLOWERING/ORNAMENTAL TREE PLANTING	_						
5	TYPICAL LARGE DECIDUOUS TREE PLANTING	_						
6	TYPICAL EVERGREEN TREE PLANTING	_						
$\overline{7}$	TYPICAL GROUND COVER PLANTING	_						
8	TYPICAL ORNAMENTAL GRAS PLANTING	-						

9	METAL EDGE	-
(10)	TURF	-
(11)	POOL	-
(12)	FIRE PIT	-
(13)	OUTDOOR KITCHEN	-
(14)	PICKLE BALL COURT	-
(15)	BOCCE BALL COURT	-
(16)	DOG PARK	-

LARGE & MEDIUM	PLANT SCHEDULE	
DECIDUOUS TREES	BOTANICAL NAME	COMMON NAME
	Acer rubrum 'red sunset'	Rd Maple
	Quercus rubra	Red Oak
(· d	Zelkova serrata 'JFS-KW1'	City Sprite zelkova
	Tilia americana	American Linden
E & B	Betula nigra 'BNMTF'	Dura Heat®River Birch
EVERGREEN TREES	BOTANICAL NAME	COMMON NAME
	Pinus echinata	Short-Leaf Pine
Many .	Juniperus virginiana	Red Cedar
•	Thuja 'Green Giant'	Arborvitae
SMALL DECIDUOUS TREES	BOTANICAL NAME	COMMON NAME
	Cornus florida	Flowering Dogwood
	Cercis canadensis	Red Bud
	Amelanchier x grandiflora 'Autumn Brilliance'	Autumn Brilliance® Apple Serviceberry
	Carpinus caroliniana	American Hornbeam
SHRUBS	BOTANICAL NAME	COMMON NAME
0	Buxus x 'Green Velvet'	Green Velvet Boxwood
	Taxus ×media	Yew
	Physocarpus opulifolius	Tiny Wine Ninebark
Ō	Juniperus ×pfitzeriana 'Sea Green'	Chinese Juniper
	ITEA VIRGINICA 'LITTLE HENRY'	'LITTLE HENRY' SWEET SPIRE
(· · ·)	Ceanothus americanus	New Jersey Tea
red of the second	Thuja occidentalis 'Smaragd'	Emerald Green Arborvitae
TAME (C)	Rhus aromatica 'Gro—Low'	Gro-Low Fragrant Sumac
$\overline{\bigcirc}$	Spiraea japonica	Japanese spirea
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in · i	Sorghastrum nutans	Indiangrass
	Juniperus procumbens 'Green	Green Mound Juniper
~	Mound'	AREA TO BE TURF
		DECORATIVE GRAVEL

* SEE SHEET L1.4 FOR LANDSCAPE NOTES, CALCULATIONS AND FULL PLANT SCHEDULE WITH QUANTITIES



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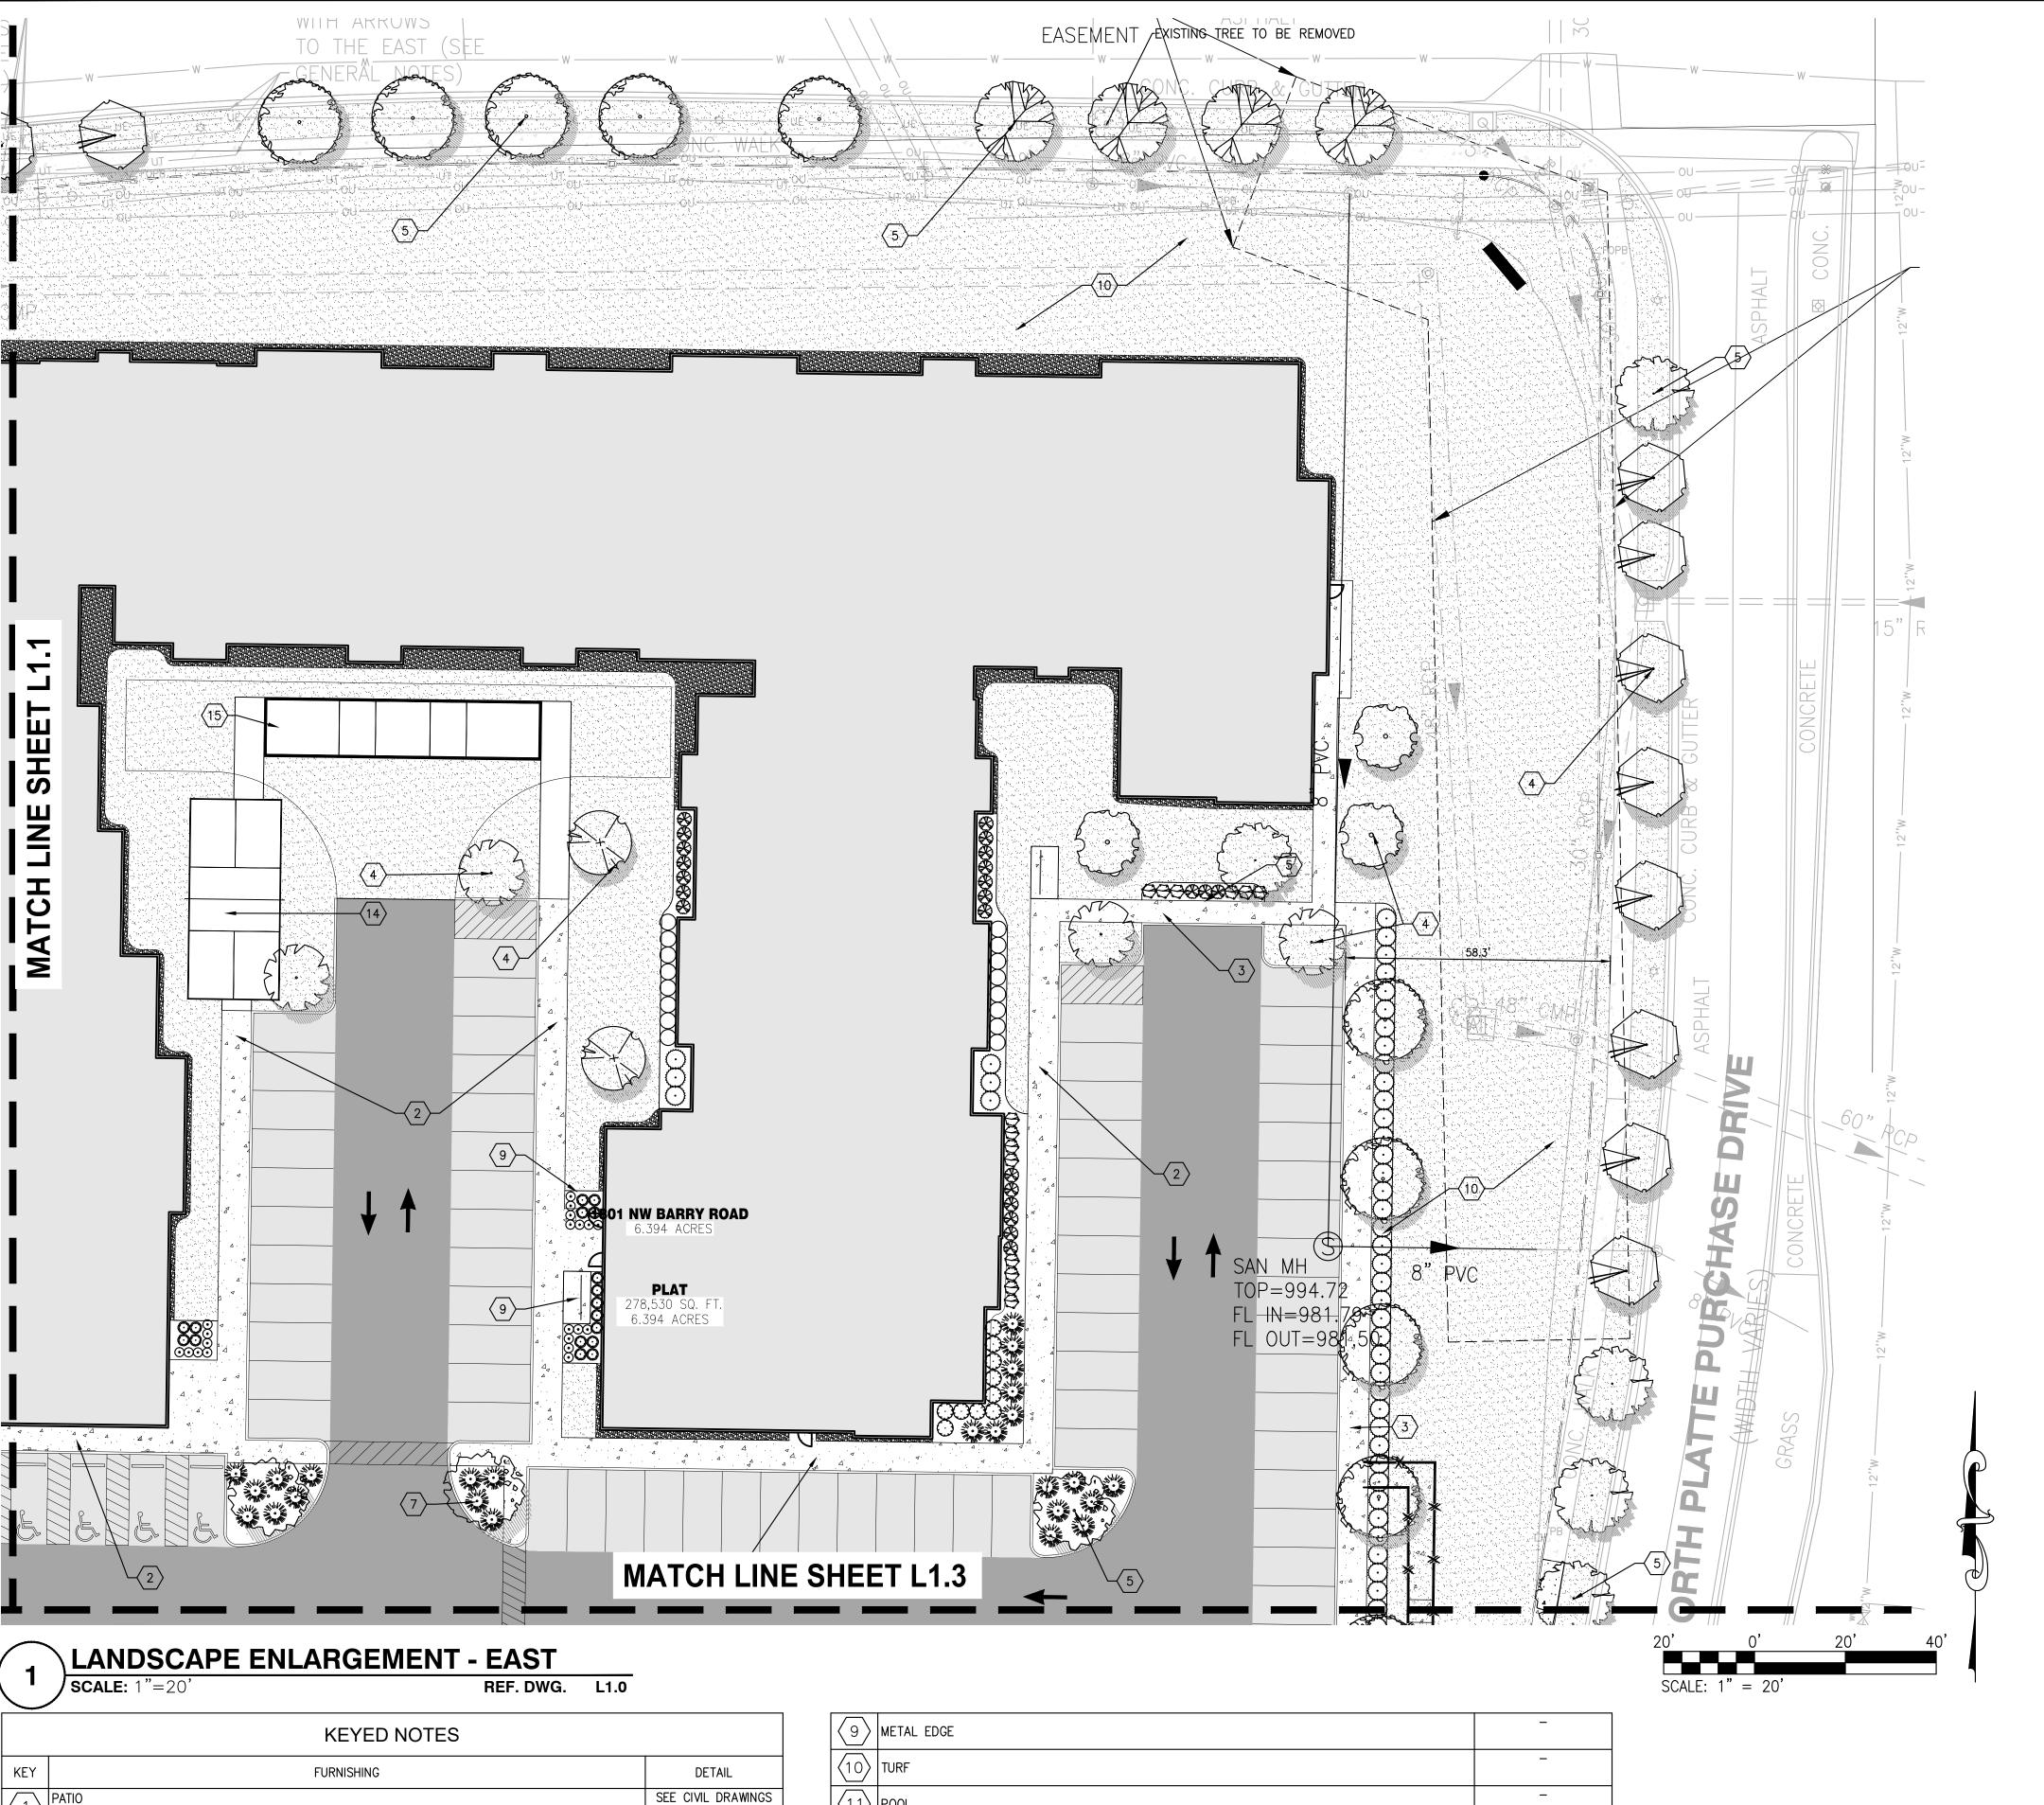
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SEE CIVIL DRAWINGS

LARGE & MEDIUM DECIDUOUS TREES	BOTANICAL NAME	COMMON NAME
	Acer rubrum 'red sunset'	Rd Maple
	Quercus rubra	Red Oak
(Zelkova serrata 'JFS-KW1'	City Sprite zelkova
	Tilia americana	American Linden
East of the second seco	Betula nigra 'BNMTF'	Dura Heat®River Birch
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Though The same of	Thuja occidentalis 'Smaragd'	Emerald Green Arborvitae
* * * * * * * * * * * * * * * * * * *	Rhus aromatica 'Gro-Low'	Gro—Low Fragrant Sumac
	Spiraea japonica	Japanese spirea
ORNAMENTAL GRASS &	BOTANICAL NAME	COMMON NAME
GROUND COVER	Schizachyrium scoparium	Little Bluestem
Shirt.	Sorghastrum nutans	Indiangrass
in it		
	Juniperus procumbens 'Green Mound'	Green Mound Juniper AREA TO BE TURF
		DECORATIVE GRAVEL

PLANT SCHEDULE



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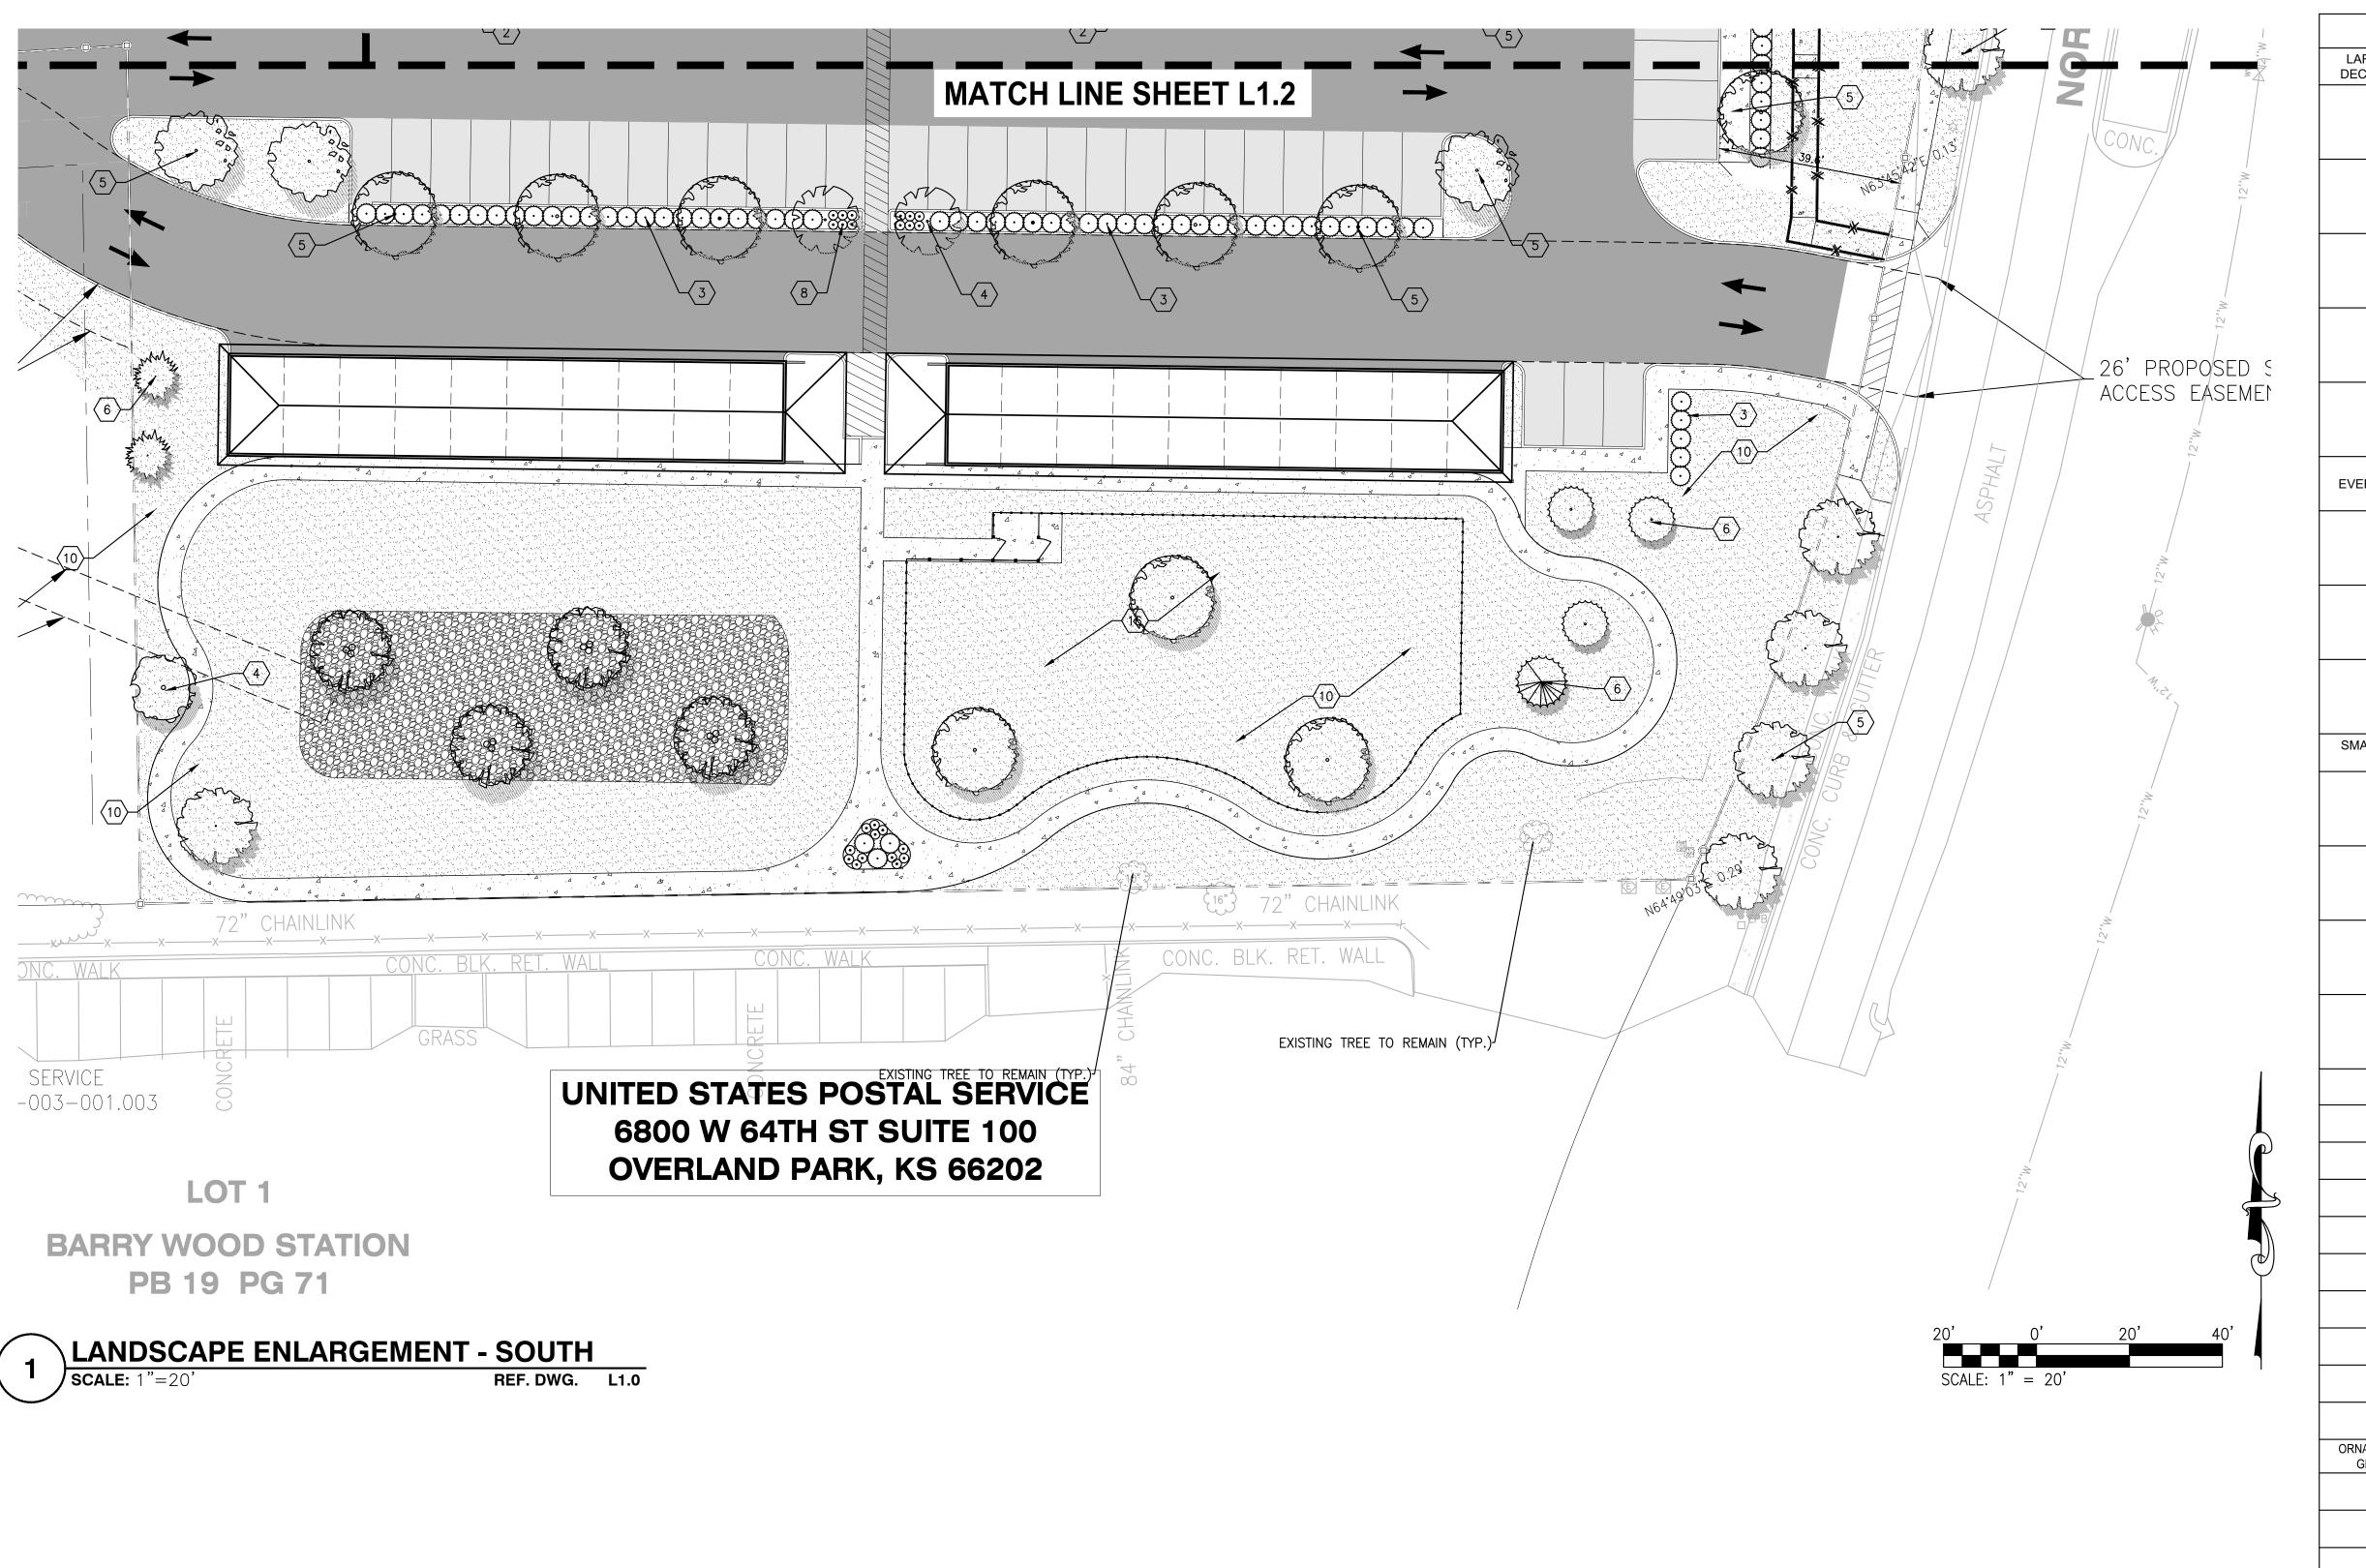
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STANDARD CONCRETE WITH BROOM FINISH, SCORED PER PLAN HAND TOOLED OR MACHINE CUT CONCRETE SIDEWALK
STANDARD CONCRETE WITH BROOM FINISH, SCORED PER PLAN, HAND TOOLED OR MACHINE CUT 3 TYPICAL SHRUB PLANTING 4 > TYPICAL FLOWERING/ORNAMENTAL TREE PLANTING TYPICAL LARGE DECIDUOUS TREE PLANTING TYPICAL EVERGREEN TREE PLANTING TYPICAL GROUND COVER PLANTING

TYPICAL ORNAMENTAL GRAS PLANTING

12 FIRE PIT 13 OUTDOOR KITCHEN (14) PICKLE BALL COURT 15 BOCCE BALL COURT 16 DOG PARK



LARGE & MEDIUM DECIDUOUS TREES	BOTANICAL NAME	COMMON NAME
	Acer rubrum 'red sunset'	Rd Maple
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SHRUBS	BOTANICAL NAME	COMMON NAME
0	Buxus x 'Green Velvet'	Green Velvet Boxwood
	Taxus ×media	Yew
	Physocarpus opulifolius	Tiny Wine Ninebark
0	Juniperus ×pfitzeriana 'Sea Green'	Chinese Juniper
	ITEA VIRGINICA 'LITTLE HENRY'	'LITTLE HENRY' SWEET SPIRE
(°,)	Ceanothus americanus	New Jersey Tea
The state of the s	Thuja occidentalis 'Smaragd'	Emerald Green Arborvitae
3800E	Rhus aromatica 'Gro-Low'	Gro-Low Fragrant Sumac
	Spiraea japonica	Japanese spirea
ORNAMENTAL GRASS &	BOTANICAL NAME	COMMON NAME
GROUND COVER	Schizachyrium scoparium	Little Bluestem
Shirt.	Sorghastrum nutans	Indiangrass
innië Mu.		
	Juniperus procumbens 'Green Mound'	Green Mound Juniper
		AREA TO BE TURF DECORATIVE GRAVEL

			•		
* SEE SHEET L1.4 FOR	LANDSCAPE	NOTES,	CALCULATIONS	AND	FULL
PLANT SCHEDULE WITH	QUANTITIES				

	KEYED NOTES							
KEY	FURNISHING	DETAIL						
$\langle 1 \rangle$	PATIO STANDARD CONCRETE WITH BROOM FINISH, SCORED PER PLAN HAND TOOLED OR MACHINE CUT	SEE CIVIL DRAWINGS						
2	CONCRETE SIDEWALK STANDARD CONCRETE WITH BROOM FINISH, SCORED PER PLAN, HAND TOOLED OR MACHINE CUT	SEE CIVIL DRAWINGS						
3	TYPICAL SHRUB PLANTING	_						
4	TYPICAL FLOWERING/ORNAMENTAL TREE PLANTING	_						
(5)	TYPICAL LARGE DECIDUOUS TREE PLANTING	_						
6	TYPICAL EVERGREEN TREE PLANTING	_						
7	TYPICAL GROUND COVER PLANTING	_						
(8)	TYPICAL ORNAMENTAL GRAS PLANTING	_						

9 METAL EDGE	_
10 TURF	-
11) POOL	-
12 FIRE PIT	-
0UTDOOR KITCHEN	-
14) PICKLE BALL COURT	-
15 BOCCE BALL COURT	-
DOG PARK	-

CITY PLANNING AND DEVELOPMENT

City Plan Commission
Recommends Approval with Conditions
of Case No. 2D-CPC-2022-00162 on 11/15/2022

Joseph Rexwinkle, AICP Secretary of the Commission

CHECKED BY

Job Number 22-0119

8/26/2022

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Kurt A. Kutter P.E. -2018021213 on 09/30/2022. It is not to be used for bidding, construction or permitting

DATE: 09/30/2022

Sheet Number

	PLANT	SCHEDULE - INCLUDES	ENTIRE SITE AND R.O.V	V. PLANTIN	GS	
LARGE & MEDIUM DECIDUOUS TREES	QTY	BOTANICAL NAME	COMMON NAME	SPACING	SIZE	COMMENTS
	24	Acer rubrum 'red sunset'	Rd Maple	As Shown	2" Cal. Min.	B&B
	7	Quercus rubra	Red Oak	As Shown	2" Cal. Min.	B&B
(·)	14	Zelkova serrata 'JFS-KW1'	City Sprite zelkova	As Shown	2" Cal. Min.	B&B
	14	Tilia americana	American Linden	As Shown	2" Cal. Min.	B&B
Example 1	4	Betula nigra 'BNMTF'	Dura Heat®River Birch	As Shown	2" Cal. Min.	B&B
EVERGREEN TREES	QTY	BOTANICAL NAME	COMMON NAME	SPACING	SIZE	COMMENTS
	3	Pinus echinata	Short-Leaf Pine	As Shown	6'-8' HT. MIN.	B&B
The state of the s	2	Juniperus virginiana	Red Cedar	As Shown	6'-8' HT. MIN.	B&B
•	5	Thuja 'Green Giant'	Arborvitae	As Shown	6'-8' HT. MIN.	B&B
SMALL DECIDUOUS TREES	QTY	BOTANICAL NAME	COMMON NAME	SPACING	SIZE	COMMENTS
	2	Cornus florida	Flowering Dogwood	As Shown	1.5" Cal. Min.	B&B
	4	Cercis canadensis	Red Bud	As Shown	1.5" Cal. Min.	B&B
	15	Amelanchier x grandiflora 'Autumn Brilliance'	Autumn Brilliance®Apple Serviceberry	As Shown	1.5" Cal. Min.	B&B SINGLE STEM
	7	Carpinus caroliniana	American Hornbeam	As Shown	1.5" Cal. Min.	B&B
SHRUBS	QTY	BOTANICAL NAME	COMMON NAME	SPACING	SIZE	COMMENTS
0	99	Buxus x 'Green Velvet'	Green Velvet Boxwood	As Shown	18" min.	Cont.
	49	Taxus ×media	Yew	As Shown	24" min.	Cont.
\Box	50	Physocarpus opulifolius	Tiny Wine Ninebark	As Shown	18" min.	Cont.
$\overline{\bigcirc}$	123	Juniperus ×pfitzeriana 'Sea Green'	Chinese Juniper	As Shown	24" min.	Cont.
	40	ITEA VIRGINICA 'LITTLE HENRY'	'LITTLE HENRY' SWEET SPIRE	As Shown	24" min.	Cont.
	33	Ceanothus americanus	New Jersey Tea	As Shown	24" min.	Cont.
And the state of t	46	Thuja occidentalis 'Smaragd'	Emerald Green Arborvitae	As Shown	4' HT. min.	Cont.
* * * * * * * * * * * * * * * * * * *	23	Rhus aromatica 'Gro—Low'	Gro-Low Fragrant Sumac	As Shown	24" min.	Cont.
	29	Spiraea japonica	Japanese spirea	As Shown	24" min.	Cont.
ORNAMENTAL GRASS &	QTY	BOTANICAL NAME	COMMON NAME	SPACING	SIZE	COMMENTS
GROUND COVER	120	Schizachyrium scoparium	Little Bluestem	As Shown	2 gal.	Cont.
o)	22	Sorghastrum nutans	Indiangrass	As Shown	2 gal.	Cont.
STANKS	40	<u> </u>	Green Mound Juniper			Cont.
	TBD	Juniperus procumbens 'Green Mound'	AREA TO BE TURF	3' O.C.	2 gal.	COIIL.
	1	_				

	LANDSCAPE AND	TREE REQUIREM	ENTS	
CODE SEC. 88-425-03-C TREE PLAN	TING REQUIREMENTS - STREET TREES			
REQUIREMENT	AREA / MEASUREMENT	REQ'D	PROV'D	APPROVED
1 STREET TREE FOR EACH 30' OF STREET FRONTAGE NO MORE THAN 50% ONE TREE SPECIES	NW BARRY RD. +/- 700 L.F. 700/30=23.3	24 TREES	24 TREES	
NO MORE IMAN 50% ONE TREE SPECIES	N PLATTE PURCHASE RD +/- 500 L.F. 500-26LF ENTRY DRIVE= 474 474/30=15.8	16 TREES	16 TREES	
CODE SEC. 88-425-04-D TREES - GE	ENERAL LANDSCAPING REQUIREMENTS			
REQUIREMENT	AREA / MEASUREMENT	REQ'D	PROV'D	APPROVED
1 TREE PER 5,000 S.F. OF PRINCIPAL BUILDING COVERAGE	77,232.8 S.F. OF BUILDING COVERAGE 77,232.8/5,000 = 15.4	16 TREES	16 TREES	
CODE SEC.88-425-06-B - MIN. INTER	IOR LANDSCAPE AREA - INTERIOR LAND	SCAPING OF PARKING LOTS		
REQUIREMENT	AREA / MEASUREMENT	REQ'D	PROV'D	APPROVED
MIN. 35 S.F. OF INTERIOR LANDSCAPE AREA FOR EACH PARKING SPACE	210 PARKING SPACES 210X35=7,350 S.F.OF INTERIOR LANDSCAPE AREA REQUIRED	7,350 S.F.	7,416 S.F.	
CODE SEC. 88-425-06-E - PLANT MA	TERIALS - INTERIOR LANDSCAPING OF P	ARKING LOTS		
REQUIREMENT	AREA / MEASUREMENT	REQ'D	PROV'D	APPROVED
1 TREE PER 5 PARKING STALLS 1 SHRUB PER PARKING SPACE GROUND COVER PLANTS MUST COVER ALL INTERIOR LANDSCAPE AREAS	205 PARKING SPACES 205/5 = 41 TREES 205X1 = 205 SHRUBS REQUIRED	41 TREES 205 SHRUBS	41 TREES 205 SHRUBS	
CODE SEC. 88-425-05-B - ADJACENT	TO STREETS - PERIMETER LANDSCAPIN	NG OF VEHICULAR USE AREA	S	
REQUIREMENT	AREA / MEASUREMENT	REQ'D	PROV'D	APPROVED
- 10' WIDE BUFFER STRIP - 1 TREE PER 30 LINEAR FEET OF LANDSCAPE STRIP * TREES PLANTED FOR STREET TREE PLANTING REQUIREMENTS MAY BE COUNTED - EVERGREEN SHRUBS TO FORM A VISUAL SCREEN AT LEAST 3' IN HEIGHT AFTER FIRST GROWING SEASON - GROUND COVER PLANTS MUST COVER THE REMAINDER OF THE REQUIRED LANDSCAPE STRIP.	+/- 180 L.F. OF PARKING LOT FRONTAGE 180/30 = 6 TREES & EVERGREEN SHRUB SCREEN	6 TREES EVERGREEN SHRUB SCREEN	6 TREES * INCLUDES PROPOSED STREET TREES EVERGREEN SHRUB SCREEN	

LANDSCAPE NOTES:

- 1. LANDSCAPE CONTRACTOR TO VERIFY LOCATION OF UNDERGROUND UTILITIES BEFORE BEGINNING WORK. 2. ALL LANDSCAPE SHALL COMPLY WITH THE CURRENT EDITION OF ANSI Z 60.1 "AMERICAN STANDARD FOR NURSERY STOCK.'
- 3. ALL PLANTS SHALL MEET THE REQUIREMENTS OF THE STATE AND FEDERAL LAW WITH RESPECT TO DISEASE AND INSECT INFESTATION.
- 4. MULCH AREAS WITH TRIPLE GROUND HARDWOOD MULCH 3" MIN. DEPTH. 5. ALL LANDSCAPE SUBSTITUTIONS MUST BE APPROVED BY THE OWNER'S REPRESENTATIVE/LANDSCAPE
- 6. FORMAL LINES AND GROUPINGS OF A SPECIES OF TREE, SHRUB, OR GROUNDCOVER SHALL BE MATCHED
- FOR SIZE, FORM, AND COLOR. 7. ALL BACKFILL IN PLANTING BEDS AND TREE PITS SHALL BE BACKFILLED WITH PLANTING SOIL AS CALLED
- OUT IN THE SPECIFICATIONS. 8. ALL TREES OUTSIDE OF PLANT BEDS SHALL BE PLANTED WITH A MULCH RING. OBTAIN APPROVAL FROM OWNER'S REPRESENTATIVE/LANDSCAPE ARCHITECT FOR ANY TREES THAT WILL NOT BE MULCHED FOR EXCESSIVE MOISTURE REASONS.
- 9. ALL LANDSCAPING SHALL BE INSTALLED AS SHOWN ON THE APPROVED PLAN.
- 10. AT PLANTING, TREE TRUNKS MUST BE STRAIGHT WITH MINIMAL DOGLEGS. 11. WIRE BASKETS, BURLAP WRAPPINGS, ROPE, TWINE OR ANY SIMILAR SHIPPING MATERIALS SHALL BE REMOVED
- BEFORE PLANTING.
- 12. A SPADE CUT EDGE SHALL BE CREATED AT ALL LOCATIONS WHERE PLANTING BEDS ARE ADJACENT TO GRASS AREAS UNLESS OTHERWISE NOTED.
- 13. SEE CIVIL PLANS FOR TYPE AND LOCATION OF EROSION CONTROL MATERIALS.
- 14. DO NOT DISTURB EXISTING UTILITIES WITHIN WORK AREA. SILT FENCE AND PLANTINGS SHALL AVOID ANY EXISTING UTILITIES.
- 15. THE CONTRACTOR SHALL FOLLOW THE LANDSCAPE PLANS. ANY SUBSTITUTION OR ALTERATION SHALL NOT BE ALLOWED WITHOUT APPROVAL OF THE OWNER'S REPRESENTATIVE/LANDSCAPE ARCHITECT. OVERALL PLANT QUANTITY AND QUALITY SHALL BE CONSISTENT WITH THE PLANS.
- 16. THE CONTRACTOR IS RESPONSIBLE FOR VERIFYING ALL PLANT QUANTITIES. WRITTEN QUANTITIES TAKES PRECEDENCE OVER GRAPHIC QUANTITIES. NOTIFY OWNER'S REPRESENTATIVE/LANDSCAPE ARCHITECT OF DISCREPANCIES.
- 17. THE OWNER'S REPRESENTATIVE/LANDSCAPE ARCHITECT RESERVES THE RIGHT TO INSPECT AND TAG ALL PLANT MATERIAL PRIOR TO SHIPPING TO THE SITE. IN ALL CASES, THE LANDSCAPE ARCHITECT MAY REJECT PLANT MATERIAL AT THE SITE IF MATERIAL IS DAMAGED, DISEASED, OR DECLINING IN HEALTH AT THE TIME OF ONSITE INSPECTIONS OR IF THE PLANT MATERIAL DOES NOT MEET THE MINIMUM SPECIFIED STANDARD IDENTIFIED ON THE PLANS AND IN THE SPECIFICATIONS. THE CONTRACTOR SHALL COORDINATE WITH THE OWNER'S REPRESENTATIVE/LANDSCAPE ARCHITECT FOR INSPECTION AND APPROVAL OF ALL MATERIALS AND PRODUCTS PRIOR TO INSTALLATION.
- 18. THE OWNER'S REPRESENTATIVE/LANDSCAPE ARCHITECT MAY ELECT TO UPSIZE PLANT MATERIAL AT THEIR DISCRETION BASED ON SELECTION, AVAILABILITY, OR TO ENHANCE SPECIFIC AREAS OF THE PROJECT. THE CONTRACTOR SHALL VERIFY PLANT MATERIAL SIZES WITH OWNER'S REPRESENTATIVE/LANDSCAPE ARCHITECT PRIOR TO PURCHASING, SHIPPING OR STOCKING OF PLANT MATERIALS. SUBMIT CHANGE ORDER REQUEST TO OWNER'S REPRESENTATIVE/LANDSCAPE ARCHITECT FOR APPROVAL IF ADDITIONAL COST IS REQUESTED BY THE 36. ALL SEEDED SLOPES EXCEEDING 25% IN GRADE (4:1) SHALL RECEIVE EROSION CONTROL BLANKETS. PRIOR CONTRACTOR PRIOR TO INSTALLATION. RE-STOCKING CHARGES WILL NOT BE APPROVED IF THE CONTRACTOR FAILS TO SUBMIT A REQUEST FOR MATERIAL CHANGES.
- 19. THE CONTRACTOR SHALL WARRANTY ALL CONTRACTED WORK AND MATERIALS FOR A PERIOD OF ONE YEAR AFTER SUBSTANTIAL COMPLETION HAS BEEN ISSUED BY THE OWNER'S REPRESENTATIVE/LANDSCAPE ARCHITECT FOR THE ENTIRE PROJECT UNLESS OTHERWISE SPECIFIED IN THE CONTRACT DOCUMENTS OR SPECIFICATIONS.
- 20. THE DEVELOPER, HIS SUCCESSORS AND ASSIGNS SHALL BE RESPONSIBLE FOR THE INSTALLATION, MAINTENANCE AND REPLACEMENT OF ALL LANDSCAPING MATERIALS SHOWN OR INDICATED ON THE APPROVED LANDSCAPE PLAN ON FILE WITH THE PLANNING DEPARTMENT. ALL LANDSCAPING WILL BE INSTALLED AS DELINEATED ON THE PLAN, PRIOR TO ISSUANCE OF CERTIFICATE OF OCCUPANCY.
- 21. PRIOR TO INSTALLATION OF PLANT MATERIALS, AREAS THAT HAVE BEEN COMPACTED OR DISTURBED BY CONSTRUCTION ACTIVITY SHALL BE THOROUGHLY LOOSENED TO A DEPTH OF 8" — 12"AND AMENDED PER
- YDS. OF ORGANIC MATTER PER 1000 S.F.). TREES SHALL NOT BE LOCATED IN DRAINAGE SWALES, DRAINAGE AREAS, OR UTILITY EASEMENTS. CONTACT OWNER'S REPRESENTATIVE/LANDSCAPE ARCHITECT FOR RELOCATION OF PLANTS IN QUESTIONABLE AREAS PRIOR TO INSTALLATION.
- 23. ALL EVERGREEN TREES SHALL BE FULLY BRANCHED TO THE GROUND AND SHALL NOT EXHIBIT SIGNS OF

- ACCELERATED GROWTH AS DETERMINED BY THE OWNER'S REPRESENTATIVE/LANDSCAPE ARCHITECT.
- 24. ALL TREES ARE TO BE STAKED AND GUYED PER DETAILS FOR A PERIOD OF 1 YEAR. THE CONTRACTOR SHALL BE RESPONSIBLE FOR REMOVING STAKES AT THE END OF 1 YEAR FROM ACCEPTANCE OF LANDSCAPE INSTALLATION BY THE OWNER'S REPRESENTATIVE/LANDSCAPE ARCHITECT. OBTAIN APPROVAL BY OWNER'S REPRESENTATIVE PRIOR TO REMOVAL.
- 25. ALL TREES INSTALLED ABOVE RETAINING WALLS UTILIZING GEO-GRID MUST BE HAND DUG TO PROTECT GEO-GRID. IF GEO-GRID MUST BE CUT TO INSTALL TREES, APPROVAL MUST BE GIVEN BY OWNER'S REPRESENTATIVE/LANDSCAPE ARCHITECT PRIOR TO DOING WORK.
- 26. PLACE PLANT MATERIAL IN SHRUB BED SO THAT ONCE PLANTS GROW TO FULL SIZE THEY ARE FULLY CONTAINED WITHIN THE SHRUB BED AREA AND DO NOT HANG OVER THE EDGER LINE.
- 27. REFER TO IRRIGATION PLANS FOR LIMITS AND TYPES OF IRRIGATION DESIGNED FOR THE LANDSCAPE. IN NO CASE SHALL IRRIGATION BE EMITTED WITHIN THE MINIMUM DISTANCE FROM BUILDING OR WALL FOUNDATIONS AS STIPULATED IN THE GEOTECHNICAL REPORT. ALL IRRIGATION DISTRIBUTION LINES, HEADS AND EMITTERS SHALL BE KEPT OUTSIDE THE MINIMUM DISTANCE AWAY FROM ALL BUILDING AND WALL FOUNDATIONS AS STIPULATED IN THE GEOTECHNICAL REPORT.
- 28. LANDSCAPE AREAS SHALL BE IRRIGATED WITH AN AUTOMATIC UNDERGROUND IRRIGATION SYSTEM WITH INDIVIDUAL ZONES FOR TURF AND NON-TURF AREAS, AND MUST INCLUDE A MOISTURE DETECTION DEVICE TO PREVENT OPERATION DURING RAINY PERIODS. TURF AREAS SHALL BE IRRIGATED WITH AN AUTOMATIC POP-UP IRRIGATION SYSTEM. SHRUB AND PERENNIAL BEDS SHALL HAVE DRIP IRRIGATION.
- 29. LANDSCAPE MATERIAL LOCATIONS SHALL HAVE PRECEDENCE OVER IRRIGATION MAINLINE AND LATERAL LOCATIONS. COORDINATE INSTALLATION OF IRRIGATION EQUIPMENT SO THAT IT DOES NOT INTERFERE WITH THE PLANTING OF TREES OR OTHER LANDSCAPE MATERIAL.
- 30. THE LANDSCAPE CONTRACTOR SHALL BE RESPONSIBLE FOR ENSURING POSITIVE DRAINAGE EXISTS IN ALL LANDSCAPE AREAS. SURFACE DRAINAGE ON LANDSCAPE AREAS SHALL NOT FLOW TOWARD STRUCTURES AND FOUNDATIONS. MAINTAIN SLOPE AWAY FROM FOUNDATIONS PER THE GEOTECHNICAL REPORT RECOMMENDATIONS, ALL LANDSCAPE AREAS BETWEEN WALKS AND CURBS SHALL DRAIN FREELY TO THE CURB UNLESS OTHERWISE IDENTIFIED ON THE GRADING PLAN. IN NO CASE SHALL THE GRADE, TURF THATCH, OR OTHER LANDSCAPE MATERIALS DAM WATER AGAINST WALKS. MINIMUM SLOPES ON LANDSCAPE AREAS SHALL BE 2%; MAXIMUM SLOPE SHALL BE 25% UNLESS SPECIFICALLY IDENTIFIED ON THE PLANS OR APPROVED BY THE OWNER'S REPRESENTATIVE/LANDSCAPE ARCHITECT.
- 31. SHRUB, GROUNDCOVER AND PERENNIAL BEDS ARE TO BE CONTAINED BY A SPADE CUT EDGE. EDGER IS NOT REQUIRED WHEN ADJACENT TO CURBS, WALLS, WALKS OR SOLID FENCES WITHIN 3"OF PRE-MULCHED FINAL GRADE. EDGER SHALL NOT BE REQUIRED TO SEPARATE MULCH TYPES UNLESS SPECIFIED ON THE
- 32. ALL SHRUB BEDS ARE TO BE MULCHED WITH MIN. 3" DEPTH, SHREDDED HARDWOOD BARK MULCH. 33. AT SEED AREA BOUNDARIES ADJACENT TO EXISTING NATIVE AREAS, OVERLAP ABUTTING NATIVE AREAS BY THE
- FULL WIDTH OF THE SEEDER. 34. EXISTING TURF AREAS THAT ARE DISTURBED DURING CONSTRUCTION, ESTABLISHMENT AND THE MAINTENANCE
- PERIOD SHALL BE RESTORED WITH NEW SOD TO MATCH EXISTING TURF SPECIES. DISTURBED NATIVE AREAS WHICH ARE TO REMAIN SHALL BE OVER SEEDED AND RESTORED WITH SPECIFIED SEED MIX. 35. CONTRACTOR SHALL OVER SEED ALL MAINTENANCE OR SERVICE ACCESS BENCHES AND ROADS WITH SPECIFIED SEED MIX UNLESS OTHERWISE NOTED ON THE PLANS.
- TO INSTALLATION, NOTIFY OWNER'S REPRESENTATIVE FOR APPROVAL OF LOCATION AND ANY ADDITIONAL COST IF A CHANGE ORDER IS NECESSARY.
- 37. WHEN COMPLETE, ALL GRADES SHALL BE WITHIN +/- 1/8" OF FINISHED GRADES AS SHOWN ON THE PLANS.THESE PLANS ARE NOT INTENDED FOR CONSTRUCTION OR PERMITTING UNLESS STATED IN THE TITLE
- 38. DRAWINGS ARE INTENDED TO BE PRINTED ON 24" X 36" PAPER. PRINTING THESE DRAWINGS AT A DIFFERENT SIZE WILL IMPACT THE SCALE. VERIFY THE GRAPHIC SCALE BEFORE REFERENCING ANY MEASUREMENTS ON THESE SHEETS. THE RECIPIENT OF THESE DRAWINGS SHALL BE RESPONSIBLE FOR ANY ERRORS RESULTING FROM INCORRECT PRINTING, COPYING, OR ANY OTHER CHANGES THAT ALTER THE SCALE OF THE DRAWINGS.
- 39. VERIFY ALL PLAN DIMENSIONS PRIOR TO START OF CONSTRUCTION. NOTIFY THE OWNER'S REPRESENTATIVE
- TO ADDRESS ANY QUESTIONS OR CLARIFY ANY DISCREPANCIES. 40. WRITTEN DIMENSIONS TAKE PRECEDENCE OVER SCALED DIMENSIONS.
- 22. ALL LANDSCAPED AREAS ARE TO HAVE SOIL PREPARATION PER SPECIFICATIONS. (MINIMUM RATE OF 3 CU. 41. SUBMIT A CHANGE ORDER FOR APPROVAL FOR ANY CHANGES TO WORK SCOPE RESULTING FROM FIELD CONDITIONS OR DIRECTION BY OWNER'S REPRESENTATIVE WHICH REQUIRE ADDITIONAL COST TO THE OWNER PRIOR TO PERFORMANCE OF WORK.
 - 42. THE CONTRACTOR SHALL PROVIDE A STAKED LAYOUT OF ALL SITE IMPROVEMENTS FOR INSPECTION BY THE OWNER'S REPRESENTATIVE AND MAKE MODIFICATIONS AS REQUIRED.



City Plan Commission Recommends Approval with Conditions of Case No. CD-CPC-2022-00162 11/15/2022

> Jóséph Rexwinkle, AICP Secretary of the Commission


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DATE: 09/30/2022

LFD DRAWN BY CHECKED BY DRAWING SCALE AS SHOWN

> 8/26/2022 Job Number 22-0119

Sheet Number

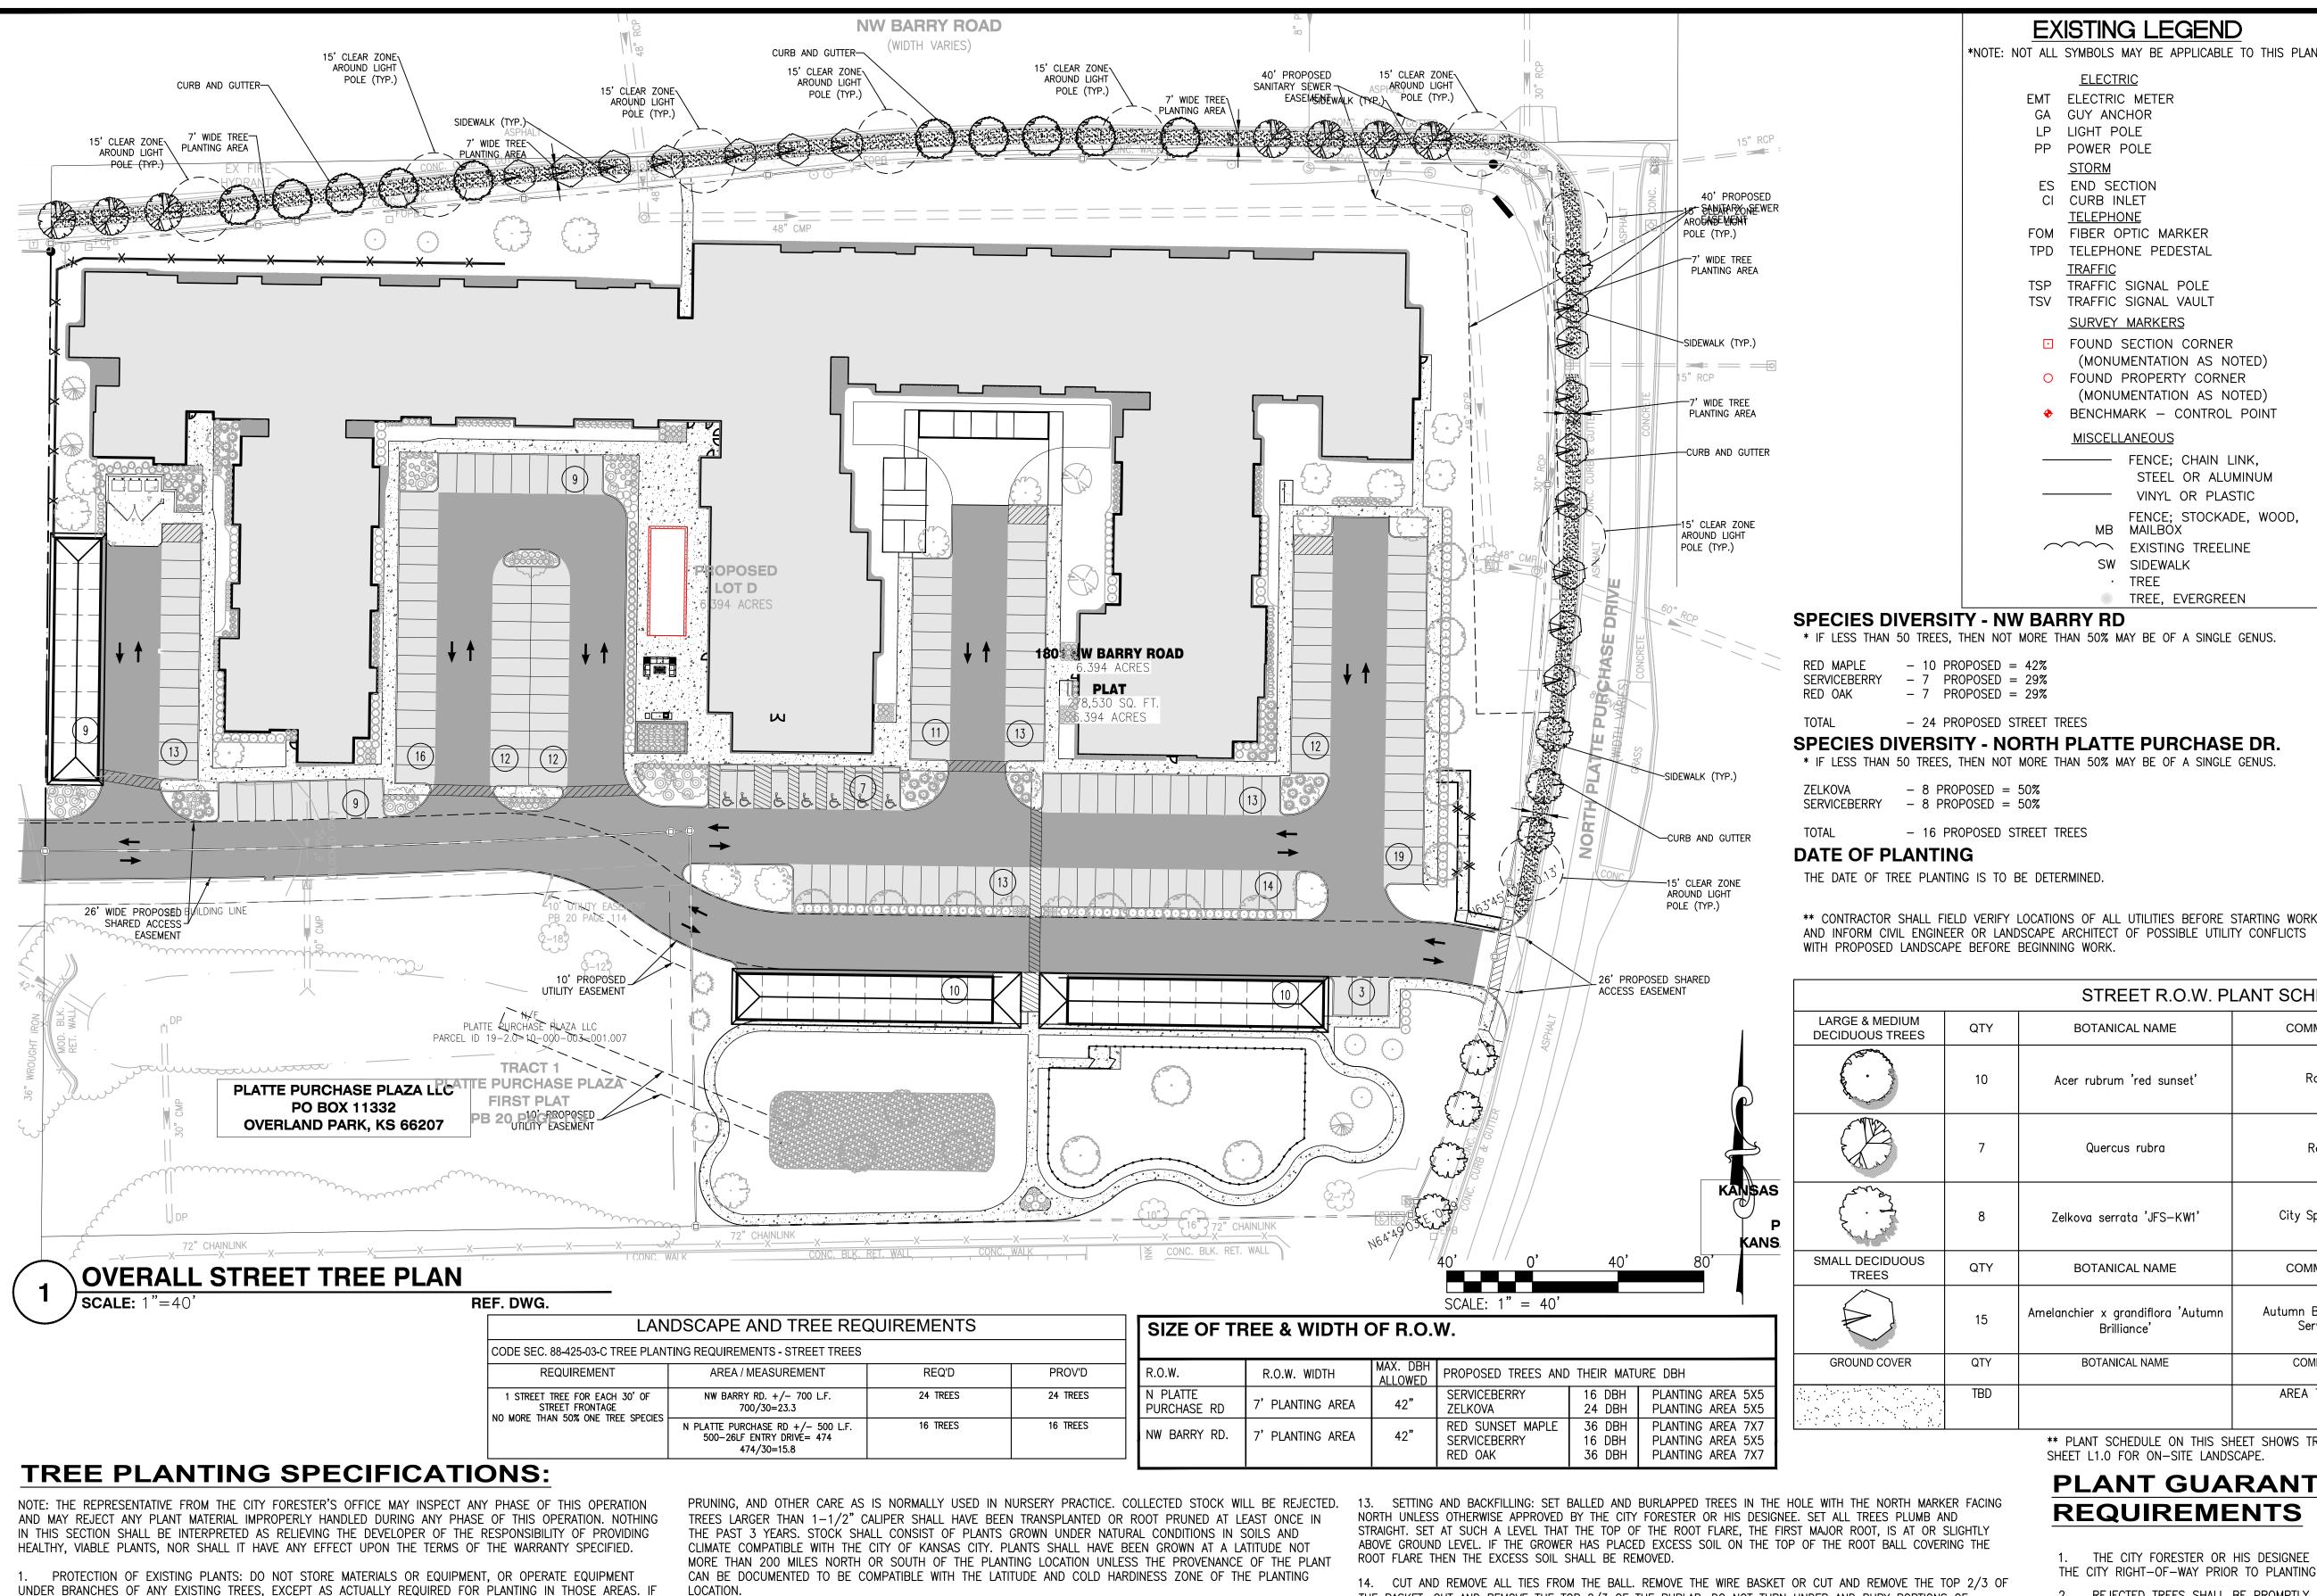

QTY **BOTANICAL NAME** TBD ** PLANT SCHEDULE ON THIS SHEET SHOWS TREES WITHIN THE RIGHT-OF-WAY ONLY. SEE SHEET L1.0 FOR ON-SITE LANDSCAPE.

LOCATION. PLANTS SHALL BE FREE FROM DEFECTS, DISEASE, INSECTS, EGGS OR LARVAE AND INJURIES OR OTHER CONDITIONS THAT WOULD PREVENT VIGOROUS GROWTH. THE CITY RESERVES THE RIGHT TO REJECT ANY AND ALL PLANTS THAT IN ITS OPINION ARE POOR IN QUALITY, HEALTH, AND/OR FORM. ALL FIELD GROWN TREES SHALL BE

MARKED TO INDICATE THE TREE'S NORTH ORIENTATION IN THE NURSERY. ALL SHIPMENTS OF PLANT STOCK SHALL COMPLY WITH EXISTING STATE AND FEDERAL LAWS AND REGULATIONS GOVERNING PLANT DISEASE AND INFECTION, AND INTERSTATE MOVEMENT OF NURSERY STOCK.

FERTILIZER: FERTILIZE TREES AFTER PLANTING WITH A "PLANT STARTER/ROOT STIMULATOR" LIQUID SOLUTION APPLIED ACCORDING TO THE MANUFACTURER'S INSTRUCTIONS. MULCH: WOOD MULCH SHALL CONSIST OF BAGGED OR BULK AGED WOOD CHIPS, OR SHREDDED HARDWOOD

HEIGHT, 4" MINIMUM DIAMETER. MATERIAL SHALL BE VENTED POLYETHYLENE OR EQUIVALENT LIGHT IN COLOR NOT

BARK. WALNUT BARK OR CHIPS ARE NOT ACCEPTABLE. TREE GUARDS: EACH TREE SHALL BE PROTECTED AFTER PLANTING WITH A PLASTIC PROTECTOR, 9" NOMINAL

11. EXCAVATION FOR PLANTING: PLANTING HOLES SHALL BE A MINIMUM OF 10" LARGER IN DIAMETER THAN THE SPREAD OF ROOTS OR SIZE OF ROOT BALL. THE BOTTOM OF THE HOLE SHALL BE NO DEEPER THAN THE HEIGHT OF THE ROOT BALL SO THAT THE TREE BALL IS PLACED ON SOLID EARTH. PLANTING HOLES SHALL HAVE APPROXIMATELY 45 DEGREE VERTICAL SIDES AND FLAT BOTTOMS. ALL UNDERGROUND UTILITY LOCATIONS ARE TO BE LOCATED IN THE PLANTING AREAS. MISSOURI LAW REQUIRES THAT A LOCATE REQUEST BE PLACED BEFORE BEGINNING ANY EXCAVATION. WHERE TURFED AREAS ARE DAMAGED BY PLANTING OPERATIONS, THEY SHALL BE RESTORED AND REPLACED WITH

SETTING AND BACKFILLING: SET BALLED AND BURLAPPED TREES IN THE HOLE WITH THE NORTH MARKER FACING NORTH UNLESS OTHERWISE APPROVED BY THE CITY FORESTER OR HIS DESIGNEE. SET ALL TREES PLUMB AND STRAIGHT. SET AT SUCH A LEVEL THAT THE TOP OF THE ROOT FLARE, THE FIRST MAJOR ROOT, IS AT OR SLIGHTLY ABOVE GROUND LEVEL. IF THE GROWER HAS PLACED EXCESS SOIL ON THE TOP OF THE ROOT BALL COVERING THE

THE BASKET. CUT AND REMOVE THE TOP 2/3 OF THE BURLAP. DO NOT TURN UNDER AND BURY PORTIONS OF BURLAP AT TOP OF BALL. IN NO CASE SHOULD THE BURLAP BE PULLED OUT FROM UNDER THE BALLS. DO NOT PLANT TREES WHOSE BALLS HAVE BEEN BROKEN DURING THE PLANTING PROCESS. PLANTS GROWN IN CONTAINERS SHALL BE OF APPROPRIATE SIZE FOR THE CONTAINER AS SPECIFIED IN THE

LATEST EDITION OF "AMERICAN STANDARD OF NURSERY STOCK", ANSI Z60.1 (2014) REFERENCED HEREIN AND SHALL BE FREE OF CIRCLING ROOTS ON THE EXTERIOR AND INTERIOR OF THE ROOT BALL

BACKFILL EACH HOLE ABOUT 2/3. FLOOD THE PLANT WITH WATER AND ALLOW SOIL TO SETTLE. ROOT STIMULATOR SHALL BE APPLIED AT THE TIME OF WATERING. BACKFILL THE REMAINING 1/3 OF THE HOLE NOT EXCEEDING THE ROOT COLLAR OR THE TOP OF THE ROOT BALL. ALL EXCESS EXCAVATED SOIL SHALL BE REMOVED FROM THE PLANTING SITE.

18. APPLICATION OF MULCH: PLACE 2 TO 4 INCHES OF MULCH AROUND ALL TREES TO COVER AN AREA APPROXIMATELY 3 FEET IN DIAMETER. DO NOT MOUND MULCH AGAINST THE TREE TRUNK

19. FINAL OPERATIONS: REMOVE ALL REMAINING TAGS, TIES, TREE WRAP AND TRANSIT PROTECTORS FROM TREES. INSTALL TREE GUARD AS SPECIFIED. STAKES AND GUYS ARE NOT REQUIRED BUT MAY BE NEEDED WHERE TREES ARE LOCATED IN EXTREMELY WINDY CONDITIONS OR REQUIRED BY THE CITY FORESTER OR HIS DESIGNEE. IN NO CASE SHALL TREES THAT HAVE SETTLED OUT OF PLUMB BE PULLED UPRIGHT USING GUY WIRES. STAKING AND GUYING

METHOD SHOULD BE APPROVED BY THE CITY FORESTER BEFORE INSTALLING. 20. REMOVE ALL EXCESS AND WASTE MATERIALS FROM THE SITE PROMPTLY. EXISTING TURF OR ANY OTHER CONDITIONS DAMAGED DURING PLANTING SHALL BE REPAIRED. WHEN COMPLETED, THE AREA SHALL BE NEAT AND

PLANT GUARANTEE & MAINTENANCE **REQUIREMENTS**

- 1. THE CITY FORESTER OR HIS DESIGNEE SHALL HAVE THE RIGHT TO INSPECT ALL TREES PLANTED IN THE CITY RIGHT-OF-WAY PRIOR TO PLANTING.
- REJECTED TREES SHALL BE PROMPTLY REMOVED AND REPLACED.

EXISTING LEGEND

EMT ELECTRIC METER

GA GUY ANCHOR

PP POWER POLE

<u>STORM</u> ES END SECTION

CI CURB INLET

<u>TELEPHONE</u>

FOM FIBER OPTIC MARKER

TPD TELEPHONE PEDESTAL

TSP TRAFFIC SIGNAL POLE TSV TRAFFIC SIGNAL VAULT

SURVEY MARKERS

MISCELLANEOUS

FOUND SECTION CORNER

FOUND PROPERTY CORNER

MB MAILBOX

EXISTING TREELINE

SW SIDEWALK

TREE

BOTANICAL NAME

Acer rubrum 'red sunset'

Quercus rubra

Zelkova serrata 'JFS-KW1'

BOTANICAL NAME

Amelanchier x grandiflora 'Autumn

Brilliance'

- 10 PROPOSED = 42%

-7 PROPOSED = 29%

-7 PROPOSED = 29%

- 8 PROPOSED = 50%

- 8 PROPOSED = 50%

- 24 PROPOSED STREET TREES

16 PROPOSED STREET TREES

QTY

10

QTY

15

(MONUMENTATION AS NOTED)

(MONUMENTATION AS NOTED)

— FENCE; CHAIN LINK,

TREE, EVERGREEN

STEEL OR ALUMINUM

FENCE: STOCKADE, WOOD,

STREET R.O.W. PLANT SCHEDULE ONLY

COMMON NAME

Rd Maple

Red Oak

City Sprite zelkova

COMMON NAME

Autumn Brilliance®Apple

Serviceberry

COMMON NAME

AREA TO BE TURF

VINYL OR PLASTIC

BENCHMARK - CONTROL POINT

LP LIGHT POLE

*NOTE: NOT ALL SYMBOLS MAY BE APPLICABLE TO THIS PLAN

PROPOSED LEGEND

*NOTE: NOT ALL SYMBOLS MAY BE APPLICABLE TO THIS PLAN

CONTOURS

TREE

BUSH

STORM MANHOLE

AREA INLET

CURB INLET

GRATED INLET

FLARED END SECTION

STORM SEWER

GRATED MANHOLE

STORM DESIGNATOR

DRAINAGE PIPE

SANITARY MANHOLE

SANITARY SEWER

CLEAN OUT

SANITARY DESIGNATOR

LIGHT POLE

POWER POLE

OVERHEAD UTILITY

UNDERGROUND ELECTRIC

UNDERGROUND TELEPHONE

GAS LINE

GAS VALVE

GAS METER

GAS MARKER

WATER LINE

WATER VALVE

WATER METER

FIRE HYDRANT

LIGHT STANDARD

FENCE

BOLLARD

RETAINING WALI

CONCRETE PAVEMENT

GUARD RAI

PROPERTY LIN

EASEMENT SETBACK

SPACING

As Shown

As Shown

As Shown

SPACING

As Shown

SPACING

SIZE

2" Cal. Min.

SIZE

1.5" Cal. Min.

B&B

B&B

B&B

STEM

SIGN

PROPOSED

- MAINTENANCE SHALL BEGIN IMMEDIATELY AFTER EACH PLANT IS PLANTED AND CONTINUE UNTIL ITS ACCEPTANCE HAS BEEN CONFIRMED BY THE CITY FORESTER OR HIS DESIGNEE.
- 4. ALL TREES SHALL BE GUARANTEED BY THE DEVELOPER TO BE IN VIGOROUS GROWING CONDITION AT THE TIME OF PLANTING. ACCEPTANCE OF PLANT MATERIAL SHALL BE FOR GENERAL CONFORMANCE TO SPECIFIED SIZE, CHARACTER, AND QUALITY AND SHALL NOT RELIVE THE CONTRACTOR OF RESPONSIBILITY FOR FULL CONFORMANCE TO THE CONTRACT DOCUMENTS, INCLUDING CORRECT SPECIES AND/OR CULTIVAR.
- DEVELOPER SHALL PROMPTLY RAISE AND STRAIGHTEN TREES THAT SETTLE OR LEAN, FOR A PERIOD OF 18 MONTHS.
- DEVELOPER WILL TREAT FOR ANY DISEASE, OR INSECT PROBLEM THAT COULD CAUSE SIGNIFICANT HARM
- DEVELOPER WILL GUARANTEE AND REPLACE ANY TREE THAT DIES FOR A PERIOD OF 18 MONTHS. THE CITY FORESTER OR HIS DESIGNEE SHALL HAVE THE RIGHT TO INSPECT TREES FOR GROWING CONDITION, AND REQUIRE REPLACEMENT IF NECESSARY. TO BE CONSIDERED ACCEPTABLE, PLANTS SHALL BE FREE OF DEAD OR DYING BRANCHES AND BRANCH TIPS AND SHALL BEAR FOLIAGE OF NORMAL DENSITY, SIZE, AND COLOR. REPLACEMENTS SHALL BE SUBJECT TO ALL REQUIREMENTS STATED IN THIS SPECIFICATION. REPLACEMENT TREES WILL ALSO BE GUARANTEED FOR A PERIOD OF ONE YEAR FROM THE DATE THAT THEY WERE PLANTED

DEVELOPER WILL NOT BE HELD RESPONSIBLE FOR TREES THAT ARE VANDALIZED, OR OTHERWISE DAMAGED DUE TO CIRCUMSTANCES BEYOND THE CONTRACTOR'S CONTROL. ANY TREES IDENTIFIED AS DYING DUE TO CIRCUMSTANCES BEYOND THE CONTROL OF THE DEVELOPER, MUST BE INSPECTED AND VERIFIED BY A REPRESENTATIVE FROM THE CITY FORESTER'S OFFICE.

COMMENTS

COMMENTS COMMENTS SINGLE

This document is released fo

preliminary review only

under the authority of

Kurt A. Kutter

P.E. -2018021213

on 09/30/2022.

It is not to be used for bidding

construction or permitting

purposes.

DATE: 09/30/2022

LFD RAWN BY

CHECKED BY RAWING SCALE AS SHOWN

> 8/26/2022 Job Number 22-0119

Sheet Number

of Case No. CD-CPC-2022-00162) MUST HAVE A BALL OF FIRM EARTH FROM PLANT MATERIAL SPECIFIED RIGINAL SOIL IN WHICH TH BE WRAPPED WITH NON—SYNTHETIC, ROTTABLE AND TIGHTLY TIED WITH TO HOLD IT FIRM AND INTACT. ANY PLANTS E REJECTED. WIRE BASKETS SHALL BE USED OSE OR BROKEN BALLS CITY PLANNING

AND DEVELOPMENT

FORESTER. (SEE FIGURE 5 FOR TREE PROTECTION GUIDELINES).

PLANTS SHALL BE NURSER JOSEPH REXWINKIE, AICED THE PROPER FERTILIZING, WATERING, ROOT Secretary of the Commission

E TREE HAS BEEN DAMAGED

√S SHALL BE

BLACK.

EQUAL QUALITY TURF.

EXISTING PLANTS ARE DAMAGED DURING PLANTING, DEVELOPER SHALL REPLACE SUCH PLANTS WITH THE SAME

2. ALL BROADLEAF TREES SHALL BE 2" MINIMUM CALIPER AND EVERGREEN TREES MUST HAVE A MINIMUM

3. ALL PLANTS SHALL BE SYMMETRICAL IN GROWTH WITH BALANCED ROOT AND TOP GROWTH AND SHALL BE

NO. 1 IN GRADE OR TYPE, CONFORMING TO THE LATEST EDITION OF "AMERICAN STANDARD OF NURSERY STOCK",

ANSI Z60.1 (2014) REFERENCED HEREIN. TREES SHALL HAVE A SINGLE STRAIGHT TRUNK, SINGLE DOMINANT

CENTRAL LEADER (WHEN CHARACTERISTIC OF THE SPECIES), AND A WELL-BALANCED BRANCH STRUCTURE.

PORTLY PLANTECONNISSION

Recommends Approval with Conditions


OF DAMAGE AND VALUE OF DAMAGED PLANT SHALL REST SOLELY WITH THE REPRESENTATIVE OF THE CITY

PLANTED HEIGHT OF FIVE (5) FEET, SMALLER SIZES REQUIRE PRIOR APPROVAL FROM THE CITY FORESTER.

SPECIES AND SIZE AS THOSE DAMAGED AT NO COST TO PARKS AND RECREATION. DETERMINATION OF THE EXTENT

SOIL USED FOR BACKFILLING ALL PLANTS SHALL CONSIST OF THE SOIL EXCAVATED AT THE TIME OF PLANTING.

17. IN AREAS WHERE COMPACTED SOIL EXISTS LOOSEN SOIL BEYOND THE PLANTING HOLE APPROXIMATELY 3 FEET IN DIAMETER FROM THE BASE OF THE TREE.

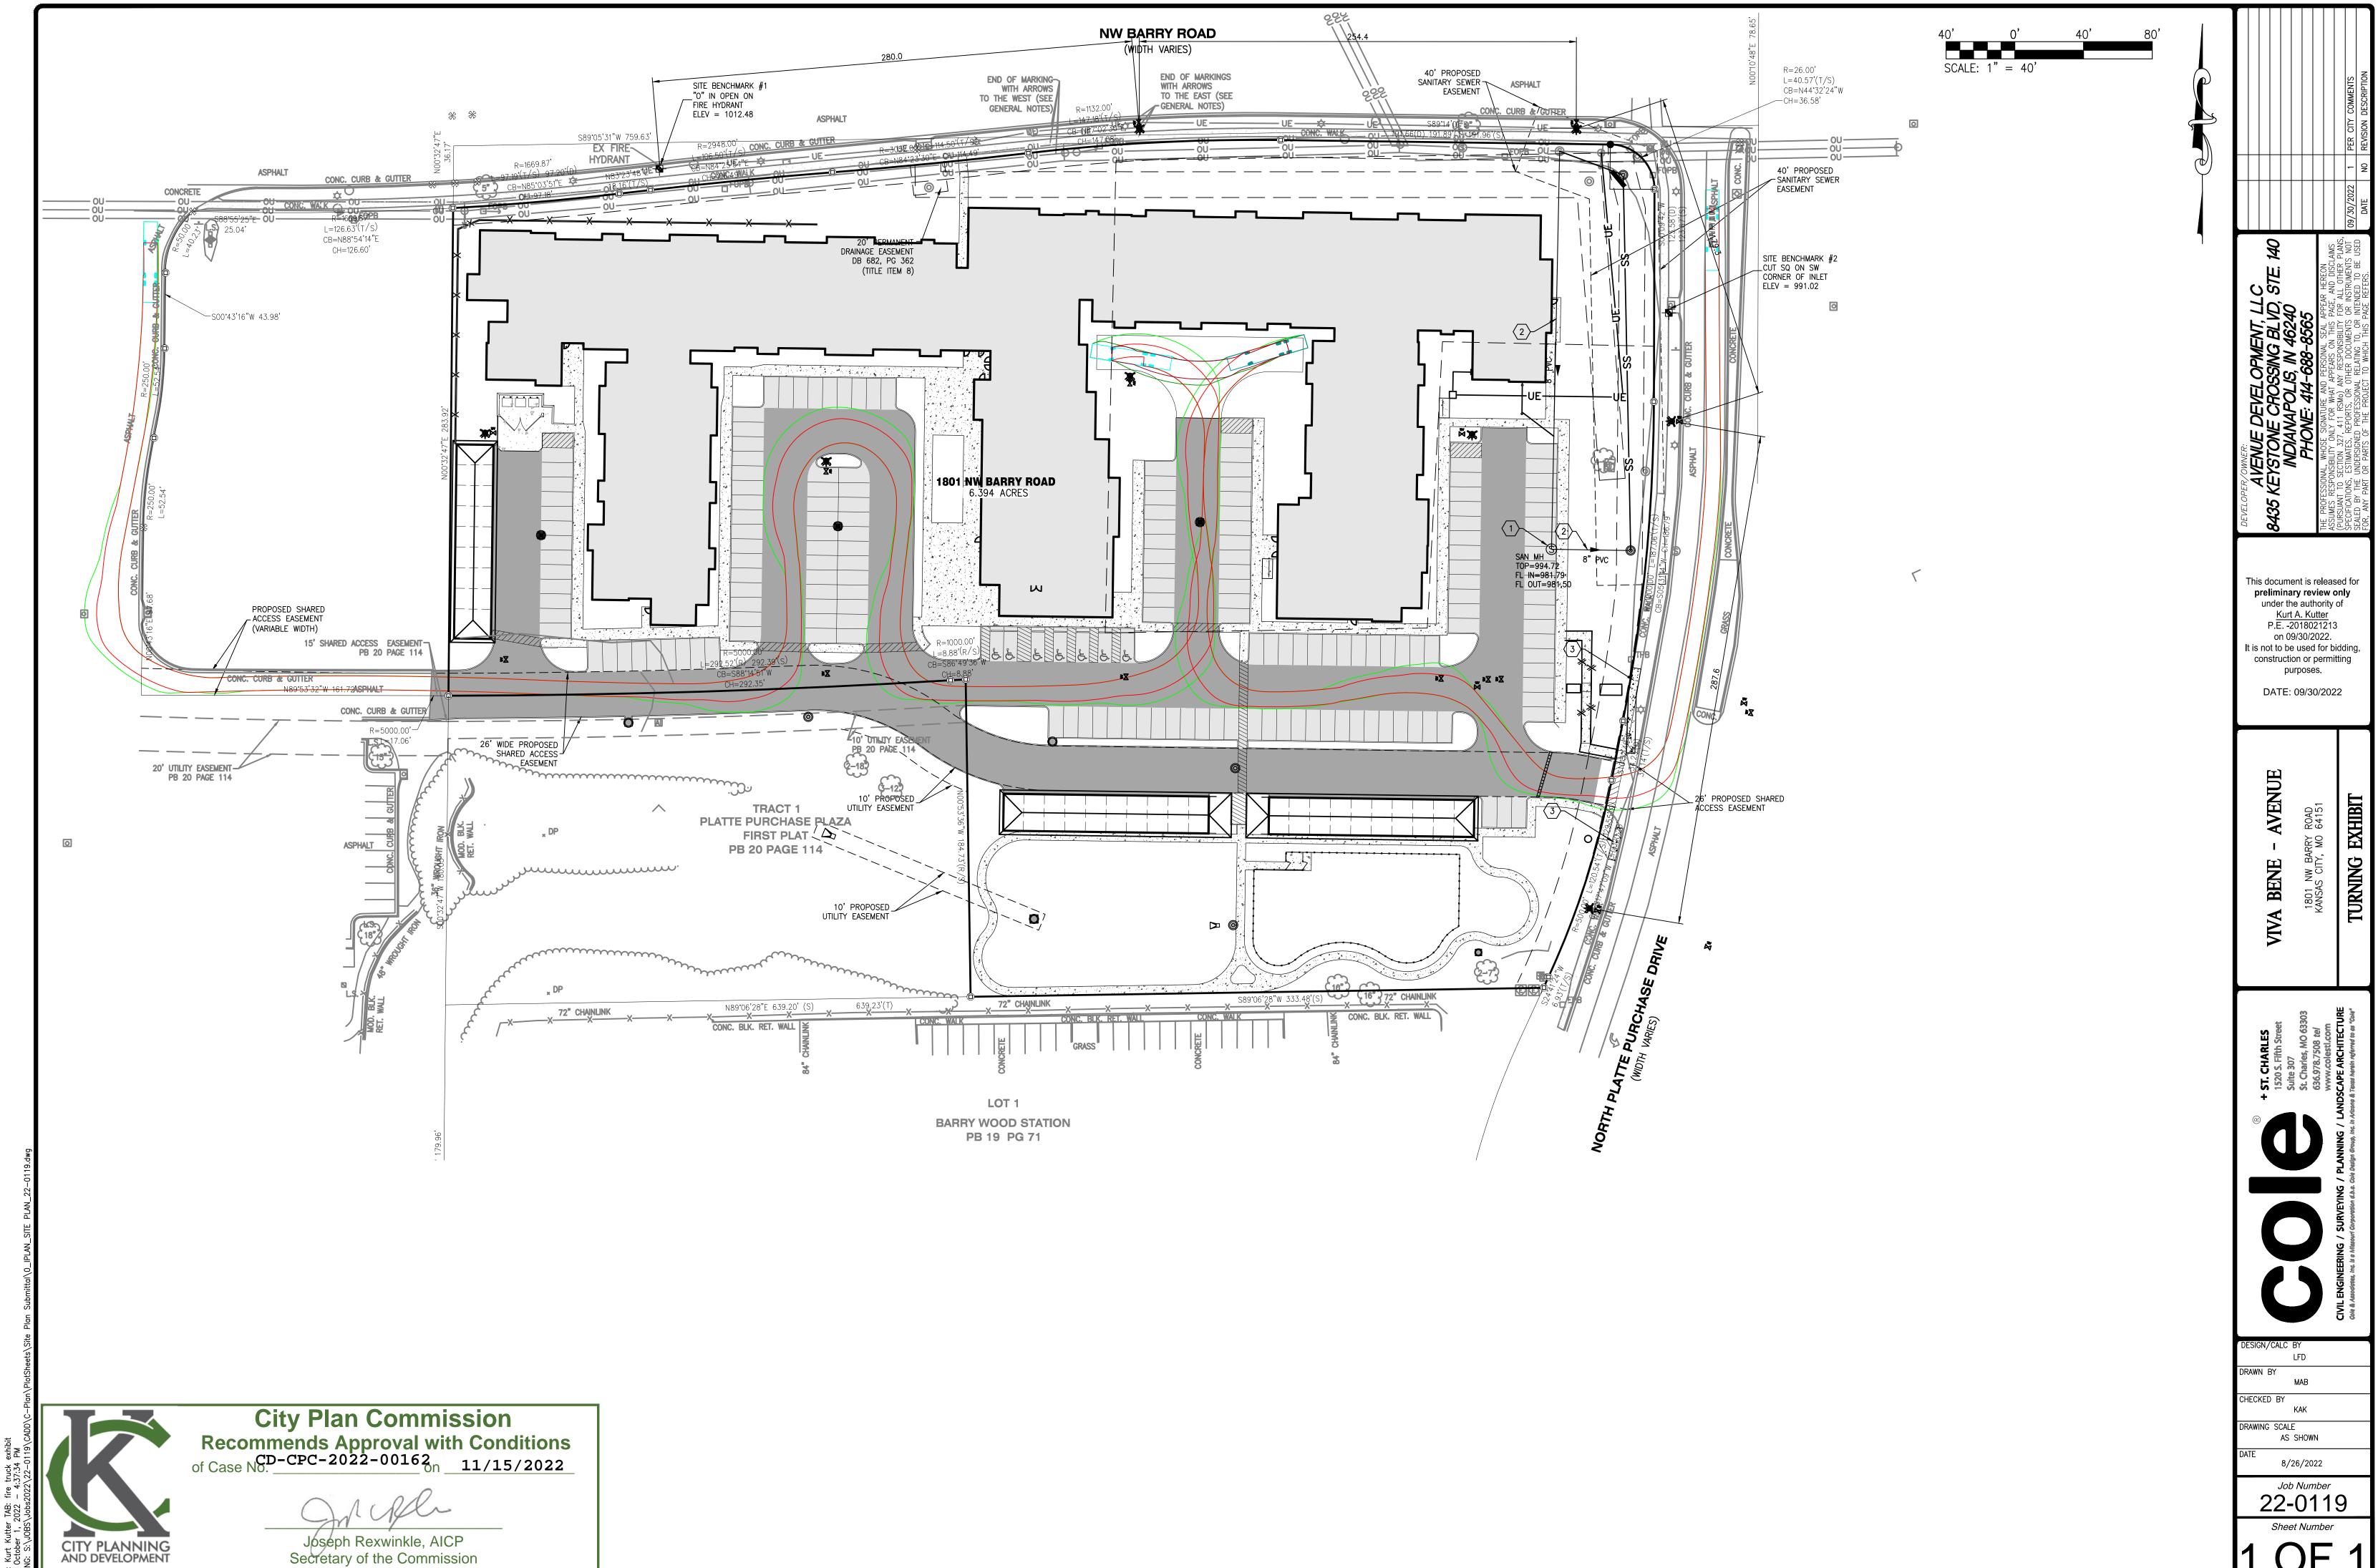



MATERIAL LEGEND




ASPHALT SHINGLE

FIBER CEMENT


BOARD AND BATTEN


PANEL WITH

ALUMINUM

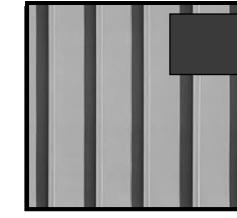

METAL ROOFING

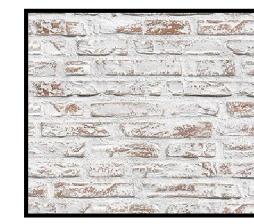

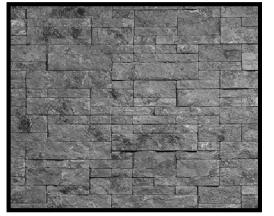

BRICK MASONRY VENEER WHITE WASHED - RED BRICK STONE STONE GRAY COLORED STONE



CONEXUS

DESIGN

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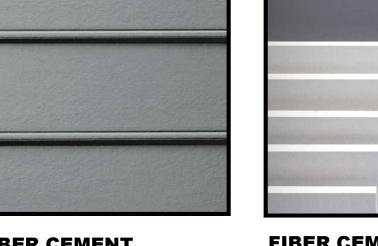
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AVENUE

COMMUNI



FIBER CEMENT TRIM **BOARDS** CHARCOAL



FIBER CEMENT SIDING 2 STABLE GRAY OR SIMILAR




FIBER CEMENT

SIDING 1


STOREFRONT / HANDRAILS BLACK



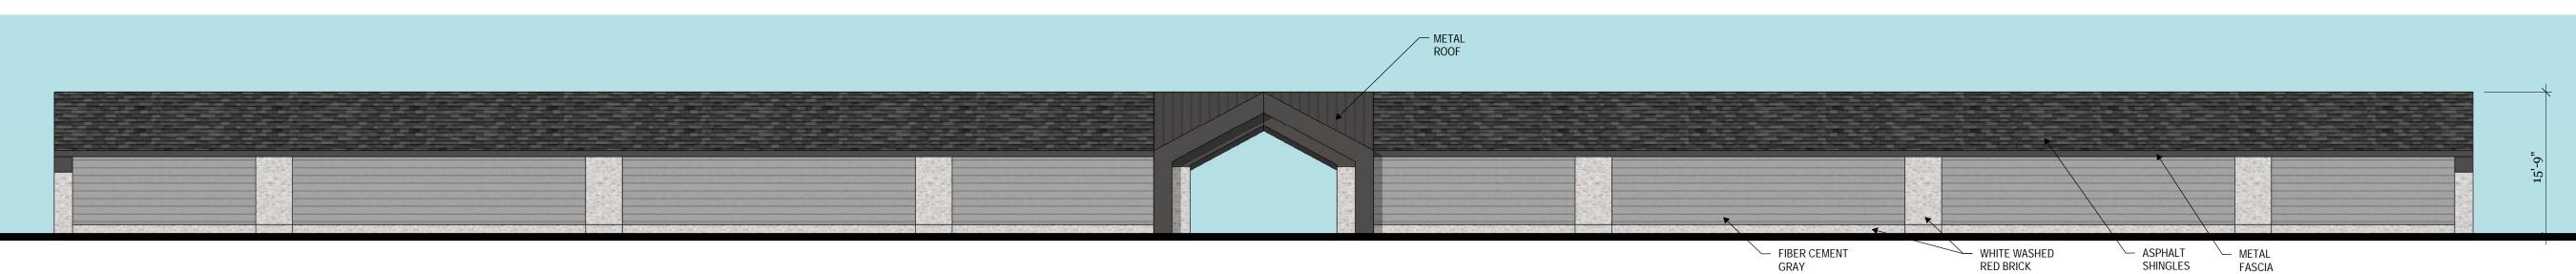

PRELIMINARY GARAGE SOUTH ELEVATION - COLOR


SCALE: 1" = 10'

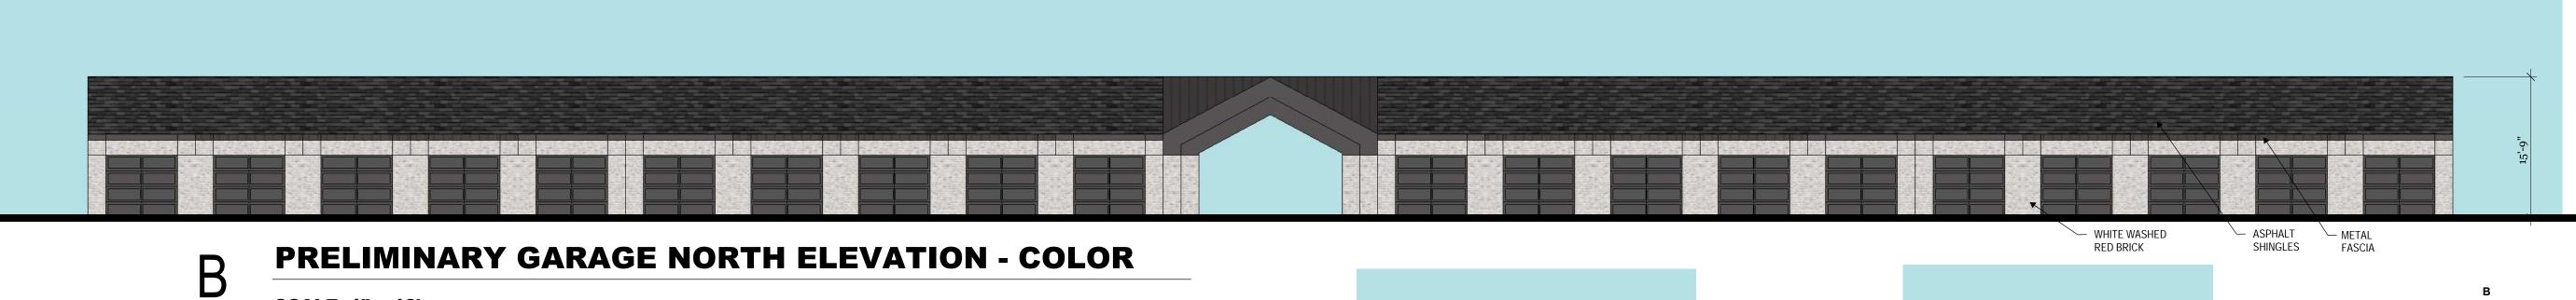

SCALE: 1" = 10'


City Plan Commission


Secretary of the Commission

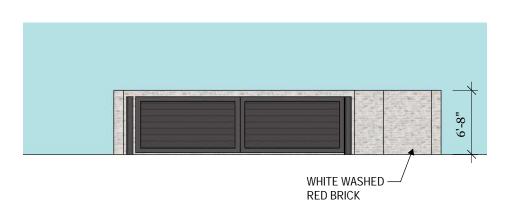


PRELIMINARY DUMPSTER FRONT

SCALE: 1" = 10'

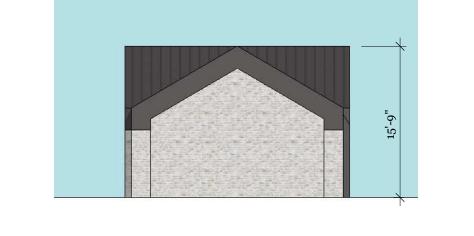

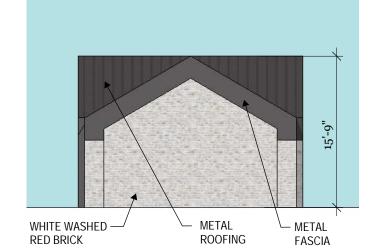

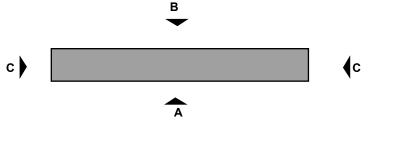

OVERALL ELEVATION KEY

9/23/2022 SCALE

REVISIONS

SHEET TITLE

RENDERING /ACCESSORY

BUILDING ELEVATIONS

PROJECT NO. **05-2022-001-MO**

A200

PRELIMINARY EAST AND WEST ELEVATION - COLOR

SCALE: 1" = 10'

Recommends Approval with Conditions of Case No. __CD-CPC-2022-00162 on __11/15/2022





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O - VIVA BENE VE ADULT COMMUNITY

REVISIONS

SHEET TITLE
COLOR

BUILDING ELEVATIONS

PROJECT NO. 05-2022-001-MO
PHASE PRELIMINARY

 PROJECT NO.
 05-2022-001-MO

 PHASE
 PRELIMINARY

 DATE
 9/23/2022

 SCALE
 1/8" = 1'-0"

A201

6
OVERALL ELEVATION KEY



PRELIMINARY NORTH ELEVATION - COLOR

ASPHALT SHINGLES ——

SCALE: 1/8" = 1'-0"



PRELIMINARY NORTH ELEVATION - COLOR

SCALE: 1/8" = 1'-0"



City Plan Commission
Recommends Approval with Conditions
of Case No. 11/15/2022

Joseph Rexwinkle, AICP Secretary of the Commission



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AVENUE

COMMUNITY BENE

SHEET TITLE COLOR BUILDING ELEVATIONS

PROJECT NO.	05-2022-001-MO
PHASE	PRELIMINARY
DATE	9/23/2022
SCALE	1/8" = 1'-0"

A202



PRELIMINARY NORTH ELEVATION - COLOR

SCALE: 1/8" = 1'-0"



PRELIMINARY EAST ELEVATION - COLOR

SCALE: 1/8" = 1'-0"



HORIZONTAL FIBER — CEMENT SIDING

FIBER CEMENT — TRIM

WHITE WASHED — RED BRICK

STONE VENEER—



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ASPHALT SHINGLES ——



PRELIMINARY SOUTH ELEVATION - COLOR

METAL ROOF — ASPHALT SHINGLES —— METAL ROOF AND — VERTICAL FASICA STONE VENEER— STOREFRONT WINDOWS AND DOORS WHITE WASHED —/ RED BRICK STONE VENEER—
FIBER CEMENT
TRIM BOARD WHITE WASHED — METAL FASCIA AND VINYL
METAL GUARDRAIL DOOR WHITE WASHED — VINYL DOOR — VINYL WINDOWS —— METAL FASCIA — VINYL WINDOWS —— HORIZONTAL FIBER CEMENT SIDING RED BRICK

WHITE WASHED — RED BRICK

STONE VENEER—

METAL ROOF —

PROJECT

PHASE

DATE

SCALE

OVERALL ELEVATION KEY

PRELIMINARY SOUTH ELEVATION - COLOR

SCALE: 1/8" = 1'-0"

VERTICAL FIBER CEMENT SIDING

SCALE: 1/8" = 1'-0"

O - VIVA BENE VE ADULT COMMUNITY

REVISIONS

SHEET TITLE
RENDERING /ACCESSORY
BUILDING ELEVATIONS

SEAL

 PROJECT NO.
 05-2022-001-MO

 PHASE
 PRELIMINARY

 DATE
 9/23/2022

 SCALE
 1/8" = 1'-0"

A203



PRELIMINARY SOUTH ELEVATION - COLOR

SCALE: 1/8" = 1'-0"



GRADE/ RETAINING — WALL IN FRONT OF ELEVATION CONE WUS

DESIGN
PLLC

1724 EAST COCONINO DRIVE, CHANDLER ARIZONA 85249
(317) 753-5259 WWW.CONEXUSDESIGN.COM

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IVA BENE DULT COMMUNITY

REVISIONS

SHEET TITLE

BUILDING ELEVATIONS

SEAL

PROJECT NO. **05-2022-001-MO**PHASE **PRELIMINARY**DATE **9/23/2022**SCALE **1/8" = 1'-0"**

A204

