

CITY PLAN COMMISSION STAFF REPORT

City of Kansas City, Missouri
City Planning & Development Department
www.kcmo.gov/cpc

November 15, 2022

Project Name Viva Bene Residential Community

Docket #10

Request

CD-CPC-2022-00162 Development Plan - Residential

Applicant

Lindsey Diekemper Cole & Associates Inc. 1520 5th St, Saint Charles, MO 63303

Owner

Platte Purchase Plaza LLC PO Box 11332 Overland Park, KS 662207

Location 1801 NW Barry Rd Area About 6.63 acres

Zoning B3-2
Council District 2nd
County Platte

School District Platte County R-III

Surrounding Land Uses

North: Undeveloped, residential uses,

zoned B3-3, B1-1

South: Public/civic uses, zoned UR **East:** Commercial, industrial uses,

zoned M2-2, B3-1, R-80

West: Commercial uses, zoned B3-2

Major Street Plan

N Platte Purchase and NW Barry Road are identified on the City's Major Street Plan as a Local Link and Thoroughfare, respectively.

Land Use Plan

The Line Creek Valley Area Plan recommends Commercial for this location.

APPROVAL PROCESS



PROJECT TIMELINE

The application for the subject request was filed on 8/29/2022. Scheduling deviations from 2022 Cycle T have occurred.

- The applicant requested a continuance to allow time to review geotechnical reports from the site.

NEIGHBORHOOD AND CIVIC ORGANIZATIONS NOTIFIED

There are no registered neighborhood or homes associations tied to the subject site.

REQUIRED PUBLIC ENGAGEMENT

Public engagement as required by 88-505-12 does apply to this request. Applicant hosted a meeting on 8/30/2022. A summary of the meeting is attached to the staff report.

EXISTING CONDITIONS

The subject site is currently undeveloped. Parcel Viewer shows a regulated stream crossing the site; however, it is clear when looking at the land itself that there is no longer a stream on the site, nor has there been for at least 15 years. There are existing sidewalks along the rights of way abutting the site, but currently no curb cuts to access the site.

SUMMARY OF REQUEST + KEY POINTS

The applicant is seeking approval of Development Plan in District B3-2 to allow for the construction of multi-unit building containing 162 units for age-restricted housing on about 6.4 acres generally located at the southwest corner of NW Barry Rd and N Platte Purchase Dr.

CONTROLLING + RELATED CASES

None

PROFESSIONAL STAFF RECOMMENDATION

Docket #10 Approval with Conditions

PLAN REVIEW

The proposed residential Development Plan consists of a three-story building with 162 units and 1,149 square feet of accessory medical office space. The developer plans to market the units to individuals who are 55 years or older and does not include any assisted living aspects; therefore, staff reviewed this project as a standard multi-unit residential project. There are two points of access shown on the plans, one from N Platte Purchase Dr on the east side of the site and one from a private drive off of NW Barry Rd on the west side of the site. All vehicular use area will be located to the rear of the building and not visible from NW Barry Rd. This area includes 205 parking spaces, 29 of which are covered spaces. Short-term bicycle parking is provided around multiple entrances to the building and long-term bicycle parking is provided within the covered parking area and inside the building.

The proposed plan shows pedestrian connection around the entire site. Pedestrian connection is provided on the north side of the building to access NW Barry Rd, as well as on the east side of the site to N Platte Purchase Dr. Striped crossings are provided across the vehicular use areas.

A variety of landscaping is shown on the plans. Street tree species include red Maple, Red Oak, American Linden, and Serviceberry. Shrub and ground cover species include Boxwood, Yew, Arborvitae, Sumac, Little Bluestem, and Indiangrass.

Proposed building materials include stone veneer, fiber cement siding, brick, and board and batten siding. Architectural articulation is provided through the variety of materials, balcony placement, and varied roofline and shapes.

PLAN ANALYSIS

Commercial Lot and Building (88-100), Use-Specific (88-300), and Development Standards (88-400)

Standards	Applicability	Meets	More Information
Lot and Building Standards (88-120)	Yes	Yes	
Accessory or Use- Specific Standards (88-305 – 385)	No	N/A	
Boulevard and Parkway Standards (88-323)	No	N/A	
Parkland Dedication (88-408)	Yes	Yes	Subject to conditions
Parking and Loading	Yes	Yes	
Standards (88-420)			
Landscape and Screening Standards (88-425)	Yes	Yes	
Outdoor Lighting Standards (88-430)	Yes	Yes	Subject to conditions
Sign Standards (88-445)	Yes	Yes	Subject to conditions
Pedestrian Standards (88-450)	Yes	Yes	

SPECIFIC REVIEW CRITERIA

Development Plans, Project Plan, or Site Plan (88-516-05)

In order to be approved, a development plan, project plan, or site plan must comply with all of the following criteria:

A. The plan must comply with all standards of the Zoning and Development Code and all other applicable city ordinances and policies;

The proposed plan complies with all applicable standards in the Zoning and Development Code. Although the Area Plan recommends "Commercial" as the future land use, the proposed use is less intense than many commercial uses and doesn't warrant amending the area plan. Residential uses are permitted in commercial areas and districts.

- B. The proposed use must be allowed in the district in which it is located;
 - The proposed residential use is permitted in the B3-2 zoning district. The small amount of medical office, which is accessory to the residential use is also permitted in the B3-2 district.
- C. Vehicular ingress and egress to and from the site, and circulation within the site must provide for safe, efficient, and convenient movement of traffic not only within the site but on adjacent roadways;

 The site will have two access points, one on the east side of the site from N Platte Purchase Dr, and another on the west side from a private drive that connects to NW Barry Rd. Circulation around the site is adequate and not expected to have major conflict points. All vehicular use areas provide enough space for two-way drive aisles.
- D. The plan must provide for safe, efficient, and convenient non-motorized travel opportunities, being pedestrian and bicycle movement, on the subject site;
 - Sidewalks and bike racks are provided for non-motorized modes of transportation. The southern portion of the site provides an outdoor pedestrian walking area and dog park. There is a pedestrian connection from the building to the north to access NW Barry Rd. Sidewalks and stripped crossings are provided throughout the site and provide adequate circulation internally, and to reach N Platte Purchase Dr as well.
- E. The plan must provide for adequate utilities based on City standards for the particular development proposed.
 - Adequate utilities are available at the subject site to serve the building and its use, unless otherwise conditioned by Water Services or Land Development Division.
- F. The location, orientation, and architectural features, including design and material, of buildings and other structures on the site must be designed to be compatible with adjacent properties.
 - Proposed building materials and building design are consistent with some similar uses in the surrounding area, particularly the Ignite Medical Resort and recently approved assisted living project at NW Barry Rd and N Marston to the west of the subject site.
- G. Landscaping, berms, fences, and/or walls must be provided to buffer the site from undesirable views, noises, lighting, or other off-site negative influences and to buffer adjacent properties from negative influences that may be created by the plan.
 - Landscaping requirements have been met, as shown on the plans. Per staff's request, additional shrubs were added to help buffer light from headlights in the parking lot shinning into the windows of units.

H. The design of streets, drives, and parking areas within the project should result in a minimum of area devoted to asphalt or other impervious surfaces consistent with the needs of the project and city code requirements.

The total amount of impervious surface was not provided, but the building will cover 28 percent of the site. Based on the amount of parking and vehicular use area needed for the number of units proposed, it is common for the majority of the site to be impervious.

 The plan must identify trees to be removed and trees to be preserved during the development of the subject property with the goal of saving trees that are not required to be removed for the development of the property.

There are no existing trees on the subject site.

ATTACHMENTS

- 1. Conditions Report
- 2. Applicants Submittal
- 3. Public Engagement Materials
- 4. Additional documents, if applicable

PROFESSIONAL STAFF RECOMMENDATION

City staff recommends **Approval with Conditions** as stated in the conditions report.

Respectfully Submitted,

Dennin Klin

Genevieve Kohn

Planner



Plan Conditions

Report Date: November 10, 2022 Case Number: CD-CPC-2022-00162

Project: Viva Bene Residential Community

Condition(s) by City Planning and Development Department. Contact Genevieve Kohn at (816) 513-8808 / Genevieve.Kohn@kcmo.org with questions.

1. That all signage shall conform to 88-445 and shall require a sign permit prior to installation.

- 2. The developer shall submit an affidavit, completed by a landscape architect licensed in the State of Missouri, verifying that street trees have been installed in accordance with the approved street tree planting plan and are healthy prior to Certificate of Occupancy.
- 3. That the developer shall submit an affidavit, prepared by an engineer licensed in the State of Missouri, verifying that all outdoor lighting has been installed in accordance with approved plans and that lighting levels do not exceed that shown on the approved lighting plan at the property lines prior to Certificate of Occupancy.
- 4. The developer shall submit an affidavit, completed by a landscape architect licensed in the State of Missouri, verifying that all landscaping required of the approved plan has been installed in accordance with the plan and is healthy prior to Certificate of Occupancy.
- 5. Screen all roof and/or ground mounted mechanical and utility equipment in compliance with 88-425-08.

Condition(s) by City Planning and Development Department. Contact Terry Thomas at / Terry.A.Thomas@kcmo.org with questions.

- 6. The developer must dedicate additional right of way for as required by the adopted Major Street Plan and/or Chapter 88 so as to provide the minimum required right of way as measured from the centerline, and ensure right of way dedication is adequate for any proposed road improvements as required by Public Works Department adjacent to this project.
- 7. The developer shall submit a detailed Micro storm drainage analysis from a Missouri-licensed civil engineer to the Land Development Division showing compliance with the current, approved Macro study on file with the City and with current adopted standards in effect at the time of submission, including Water Quality BMP's, prior to approval and issuance of any building permits to construct improvements on the site or prior to recording the plat, whichever occurs first. The developer shall verify and/or improve downstream conveyance systems or address solutions for impacted properties due to flow contributions from the site; and that the developer construct any other improvements as required by Land Development Division as necessary to mitigate impacts from rate, volume, and quality of runoff from each proposed phase.
- 8. The developer shall cause the area to be platted and processed in accordance with Chapter 88, Code of Ordinances of the City of Kansas City, Missouri, as amended, commonly known as the Development Regulations.
- 9. The developer shall submit verification of vertical and horizontal sight distance for the drive connection to public right-of-way to the Land Development Division and make improvements to ensure local jurisdiction and/or minimum AASHTO adequate sight distance standards are met, prior to issuance of any certificate of occupancy.
- 10. The developer shall submit construction plans in compliance with adopted standards for all improvements required by the traffic study approved by the Public Works Department, and shall secure permits for those improvements as required by the Land Development Division, prior to recording the plat.
- 11. The developer shall submit a letter to the Land Development Division from a Licensed Civil Engineer, Licensed Architect, or Licensed Landscape Architect, who is registered in the State of Missouri, that identifies sidewalks, curbs, and gutters in disrepair as defined by Public Works Department's "OUT OF REPAIR CRITERIA FOR SIDEWALK, DRIVEWAY AND CURB revised 11/5/2013" and based on compliance with Chapters 56 and 64 of the Code of Ordinances for the sidewalks, curbs, and gutters where said letter shall identify the quantity and location of sidewalks, curbs, gutters that need to be constructed, repaired, or reconstructed to remedy deficiencies and/or to remove existing approaches no longer needed by this project. The developer shall secure permits to repair or reconstruct the identified sidewalks, curbs, and gutters as necessary along all development street frontages as required by the Land Development Division and prior to issuance of any certificate of occupancy permits including temporary certificate occupancy permits.

Condition(s) by City Planning and Development Department. Contact Terry Thomas at / Terry.A.Thomas@kcmo.org with questions.

- 12. The developer must pay impact fees as required by Chapter 39 of the City's Code of ordinances as required by the Land Development Division.
- 13. The developer shall provide acceptable easements for any deep sewers where proposed fill is added or where the sewer will be further obstructed by surface improvements and that a structural analysis be provided to confirm adequate structural integrity for the proposed loading conditions of this plan, and secure permits and provide City approved executed and recorded easement prior to adding fill or constructing surface obstructions as required by Land Development Division.
- 14. The developer shall submit an analysis to verify adequate capacity of the existing sewer system as required by the Land Development Division prior to issuance of a building permit to connect private system to the public sewer main and depending on adequacy of the receiving system, make other improvements may be required.
- 15. The owner/developer must submit plans for grading, siltation, and erosion control to Land Development Division for review and acceptance, and secure a Site Disturbance permit for any proposed disturbance area equal to one acre or more prior to beginning any construction activities.
- 16. The developer must submit a plan for approval and permitting by the Land Development Division prior to beginning construction of the improvements in the public right of way, and construct ADA compliant ramps at all required locations where new private drives are being added, or where existing sidewalks are modified or repaired.
- 17. The developer must obtain the executed and recorded city approved grading, temporary construction, drainage/sewer, or any other necessary easements from the abutting property owner(s) that may be required prior to submitting any public improvements crossing properties not controlled by the developer and include said document(s) within the public improvement applications submitted for permitting

Condition(s) by Fire Department. Contact Michael Schroeder at (816) 513-4604 / michael.schroeder@kcmo.org with questions.

- 18. The project shall meet the fire flow requirements as set forth in Appendix B of the International Fire Code 2018. (IFC-2018 § 507.1)
- 19. New buildings shall have approved radio coverage for emergency responders within the building based on the existing coverage levels of the public safety communication systems utilized by the jurisdiction, measured at the exterior of the building. This section shall not require improvement of the existing public safety communication systems. (IFC 2018 510.1) and (NFPA1221)
- 20. A required fire department access roads shall be an all weather surface. (IFC-2012: § 503.2.3)
 - Fire Department access roads shall be provided prior to construction/demolition projects begin. (IFC-2018 § 501.4 and 3310.1; NFPA 241-2013 § 7.5.5)
 - Required fire department access roads shall designed to support a fire apparatus with gross axle weight of 85,000 pounds. (IFC-2018: § 503.2.3
- 21. The turning radius for fire department access roads shall be 30 feet inside and 50 feet outside radius. (IFC-2018: § 503.2.4)

Condition(s) by Parks & Recreation. Contact Justin Peterson at (816) 513-7599 / Justin.Peterson@kcmo.org with questions.

- 22. The developer is responsible for dedication of parkland, private open space in lieu of parkland, or payment of cash-in-lieu of either form of dedication, or any combination thereof in accordance with 88-408. Should the developer choose to pay cash-in-lieu of dedicating all or a portion of the required area, the amount due shall be based upon the (2022) acquisition rate of (\$64,220.18) per acre. This requirement shall be satisfied prior to recording the final plat or certificate of occupancy, whichever occurs first.
- 23. The developer shall submit a streetscape plan with street tree planting plan per 88-425-03 for approval by the Parks & Recreation Department's Forestry Division prior to beginning work in the public right-of-way.

Condition(s) by Public Works Department. Contact Jeffrey Bryan at (816) 513-9865 / Jeffrey.Bryan@kcmo.org with questions.

24. Make sure the street trees shown along Platte Purchase do not cause issues with sight distance at the proposed driveway.

Condition(s) by Water Services Department. Contact Heather Massey at (816) 513-2111 / heather.massey@kcmo.org with questions.

25. Water/Sewer Service lines shall serve only one lot or tract and shall not cross a separate lot or tract.

Condition(s) by Water Services Department. Contact Heather Massey at (816) 513-2111 / heather.massey@kcmo.org with questions.

- 26. A full flow fire meter will be required when the fire protection service line serves more than one building, or combination service lines 6 inches and larger, or that have private fire hydrants connected to them.
- 27. The developer shall have a water flow test done to ensure there is adequate water pressure to serve the development. South of River contact Sean Allen 816-513-0318

 North of River contact Todd Hawes 816-513-0296
- 28. The developer shall ensure that water and fire service lines should meet current Water Services Department Rules and Regulations. Prior to C of O. https://www.kcwater.us/wp-content/uploads/2022/05/2022-Rules-and-Regulations-for-Water-Service-Lines-Final.pdf

 Condition(s) by Water Services Department. Contact Jerald Windsor at (816) 513-0413 / Jerald.Windsor@kcmo.org with questions.
 - 29. Submit WME plans for the new FH's along NE Barry Road and N Platte Purchase Drive to meet 300' max. spacing.

	LEGEND	
EXISTING		PROPOSED
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	GRATED MANHOLE	(20)
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(A) ⊙	SANITARY DESIGNATOR UTILITY POLE	(A)
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	ELECTRIC METER	
EPB	ELECTRIC BOX ELECTRIC PULL BOX	
	ELECTRIC TRANSFORMER	
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	CONCRETE PAVEMENT	
IAO.	SILTATION FENCE -	-0
	AIR CONDITIONER FLAG POLE	
	MONITORING WELL	
□ ^{PM} PT	PARKING METER PLANTER	
oSCB	SPRINKLER CONTROL BOX	
oSHD oSVLV	SPRINKLER VALVE	
Ç.B	SPRINKLER VALVE TRAFFIC CONTROL BOX	
	TRAFFIC POLE	
	YARD LIGHT — GUARD RAIL —	
	PROPERTY LINE -	
	EASEMENT - SETBACK -	
	INLET PROTECTION	<u></u>
	WATTLE -	!==' :======
	CHECK DAM	
	USE IN PLACE TO BE REMOVED	(UIP) (TBR)
	ADJUST TO GRADE	(ATG)
	TO BE REMOVED & RELOCATED TYPICAL	`(TYP)´
	NOT TO SCALE HIGH POINT IN GRADE	N.T.S. HP
	LOW POINT IN GRADE	LP
	TOP OF WALL BOTTOM OF WALL	TW BW
	NOT IN CONTRACT	(NIC)

PROJECT: CL-05 MISSOURI DNR GRS ALUMINUM DISK SET IN A 12" DIAMETER CONCRETE BASE.


SITE BENCHMARK #1: "O" IN OPEN ATOP A FIRE HYDRANT ON THE SOUTH SIDE OF NW BARRY ROAD AS

SITE BENCHMARK #2: CUT SQUARE ON SOUTHWEST CORNER OF A CURB INLET ON THE WEST SIDE OF

VIVA BENE - AVENUE

A TRACT OF LAND IN THE FRACTIONAL SOUTHWEST QUARTER OF SECTION 10, TOWNSHIP 51 NORTH, RANGE 33 WEST CITY OF KANSAS CITY, PLATTE COUNTY, MISSOURI

DEVELOPMENT PLAN

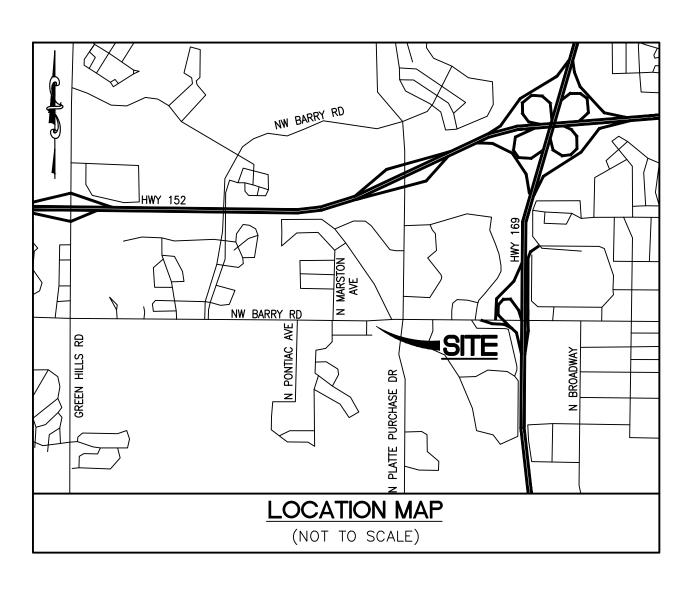

PERTINENT DATA

SITE ADDRESS

GROSS SITE AREA

= 1801 NW BARRY ROAD

PARCEL ID FIRE DISTRICT FEMA MAP PANEL KANSAS CITY, MO 64151

= KANSAS CITY FIRE DEPARTMENT = 29095C0126G, DATE: JAN 20, 2017

= 6.394 AC.

UTILITIES

SEWER SERVICE

CITY OF KANSAS CITY SEWER 4800 E 63RD STREET

KANSAS CITY, MO 64130 CONTACT: ---

PH. 816.513.1313 OR 311

FIRE DISTRICT

FIRE DEPARTMENT CITY OF KANSAS CITY, MO. 635 WOODLAND AVE. SUITE 2103 KANSAS CITY, MO 64106

CONTACT: MIKE SCHROEDER PH. 816.513.4604

WATER SERVICE

CITY OF KANSAS CITY SEWER 4800 E 63RD STREET KANSAS CITY, MO 64130 CONTACT: ---

PH. 816.513.1313 OR 311

ELECTRIC SERVICE

EVERGY 1200 MAIN ST KANSAS CITY, MO 64105 CONTACT: ---

PH. 888.471.5275

INDEX

REVISIONS

under the authority of

P.E. -2018021213

t is not to be used for biddir

DATE: 09/30/2022

LFD

AS SHOWN

8/26/2022

Job Number

22-0119

Sheet Number

DRAWN BY

CHECKED BY

DRAWING SCALE

		1	2	3	4	5	6	7	8	9
P1.0	COVER SHEET									
50.0	EVICTIVIC CONDITIONS								- 1	
P2.0	EXISTING CONDITIONS									
P3.0	PRELIMINARY SITE PLAN									
P4.0	PRELIMINARY GRADING AND UTILITY PLAN									
DE 0	DETAIL OLIFET									
P5.0	DETAIL SHEET									_
P6.0	DETAIL SHEET									
	PHOTOMETRIC PLAN — BY OTHERS									
110										
L1.0	OVERALL LANDSCAPE PLAN									_
L1.1	LANDSCAPE ENLARGEMENT									
L1.2	LANDSCAPE ENLARGEMENT									
L1.3	LANDSCAPE ENLARGMENT									
LI.J	LANDSCAFE ENLARGIMENT									
L1.4	PLANT SCHEDULE AND NOTES									
L2.0	STREET TREE PLAN									

DEVELOPMENT NOTES

= B3-2PROPOSED ZONING

= VACANT/AGRICULTURAL

= ELDERLY HOUSING/MEDICAL OFFICES = PLATTE PURCHASE PLAZA LLC

2. AS DETERMINED THROUGH GRAPHIC PLOTTING ONLY, SUBJECT TRACT FALLS IN ZONE X, AREA DETERMINED TO BE OUTSIDE THE 0.2% ANNUAL CHANCE FLOODPLAIN PER THE FEDERAL EMERGENCY MANAGEMENT AGENCY AND FLOOD INSURANCE RATE MAP FOR PLATTE COUNTY, MISSOURI AND INCORPORATED AREAS, PANEL 126 OF 625, MAP NUMBER 29095C0126G, EFFECTIVE DATE OF

3. UNDERGROUND UTILITIES AND FACILITIES HAVE BEEN SHOWN BASED ON RECORD DRAWINGS AND VISIBLE EVIDENCE FOUND. NO WARRANTY IS MADE REGARDING THE COMPLETENESS OR ACCURACY OF SUCH INFORMATION. TO DETERMINE THE EXACT LOCATION OF UNDERGROUND FACILITIES AND UTILITIES. AND PRESERVE THEM FROM DAMAGE. CALL MISSOURI ONE CALL (1-800-DIG-RITE) FOR UTILITY LOCATIONS. CONTRACTORS TO PROVIDE THREE DAYS NOTICE. THE CONTRACTOR MUST COMPLY WITH ALL UTILITY LAWS AND PAY ANY AND ALL DAMAGES ASSOCIATED WITH HIS FAILURE TO EXACTLY LOCATE AND PRESERVE UNDERGROUND FACILITIES AND UTILITIES.

4. ALL UTILITIES SHALL BE INSTALLED UNDERGROUND.

5. THE DEVELOPER WILL BE REQUIRED TO INSTALL THE NECESSARY SEWER LINES, WATER LINES, FIRE HYDRANTS AND

6. DETENTION APPEARS TO BE PROVIDED PER THE PLATTE PURCHASE PLAZA MACRO DRAINAGE STUDY IN THE EXISTING BASIN TO THE SOUTH WEST OF THE SITE. THE EXISTING BASIN WILL BE ANALYZED FOR REMAINING CAPACITY AND IF REQUIRED, MODIFICATIONS WILL BE PERFORMED ACCORDINGLY. STORM WATER QUALITY WILL BE PROVIDED VIA AN ONSITE BIORETENTION BASIN, PERVIOUS PAVEMENT, PROPRIETARY DEVICE OR COMBINATION THEREOF AND SPECIFIED IN A MICRO DRAINAGE REPORT PER CITY CODE.

7. BACKFILL PER GEOTECHNICAL ENGINEER RECOMMENDATIONS.

8. SETBACKS: FRONT YARD BUILDING SETBACK: NONE SIDE YARD BUILDING SETBACK: REAR YARD BUILDING SETBACK: NONE

9. ALL SIGNAGE SHALL BE BY A SEPARATE REVIEW AND PERMIT PROCESS.

10. ALL NATURAL FEATURES AND WATER COURSES SHALL BE LEFT UNDISTURBED.

11. LIGHTING SHALL BE IN ACCORDANCE WITH THE CITY OF KANSAS CITY. 12. REFER TO PHOTO METRIC PLAN FOR LOCATION OF PARKING LOT LIGHTS.

13. AN AUTOMATIC PERMANENT IRRIGATION SYSTEM SHALL BE INSTALLED TO COVER ALL LANDSCAPED ARES OF

14. THE SITE ADDRESS IS 1801 NW BARRY ROAD, KANSAS CITY, MO.

UTILITY INFORMATION:

UTILITIES SHOWN HAVE BEEN TAKEN FROM AVAILABLE SURVEYS, UTILITY COMPANY MAPS AND PHYSICAL PROPERTY INSPECTION. THE LOCATIONS AND FACILITIES SHALL BE CONSIDERED APPROXIMATE ONLY. THERE MAY BE ADDITIONAL UTILITIES THAT HAVE NOT BEEN SHOWN ON THIS SURVEY. THE CONTRACTOR WILL BE RESPONSIBLE FOR THE LOCATIONS OF ALL UTILITIES PRIOR TO EXCAVATION OR



CONSTRUCTION.



CALL 1-800-DIG-RITE (MISSOURI ONE CALL) TO HAVE LOCATIONS NOTICE PRIOR TO CONSTRUCTION).

SITE BENCHMARK INFORMATION

NAVD88 ELEV = 919.58


SHOWN ON THE SURVEY.


NAVD88 ELEV = 1012.48

NAVD88 ELEV = 991.02

NORTH PLATTE PURCHASE DRIVE AS SHOWN ON THE SURVEY.

MARKED IN THE FIELD (SUBSCRIBING UTILITIES REQUIRE 48 HOURS

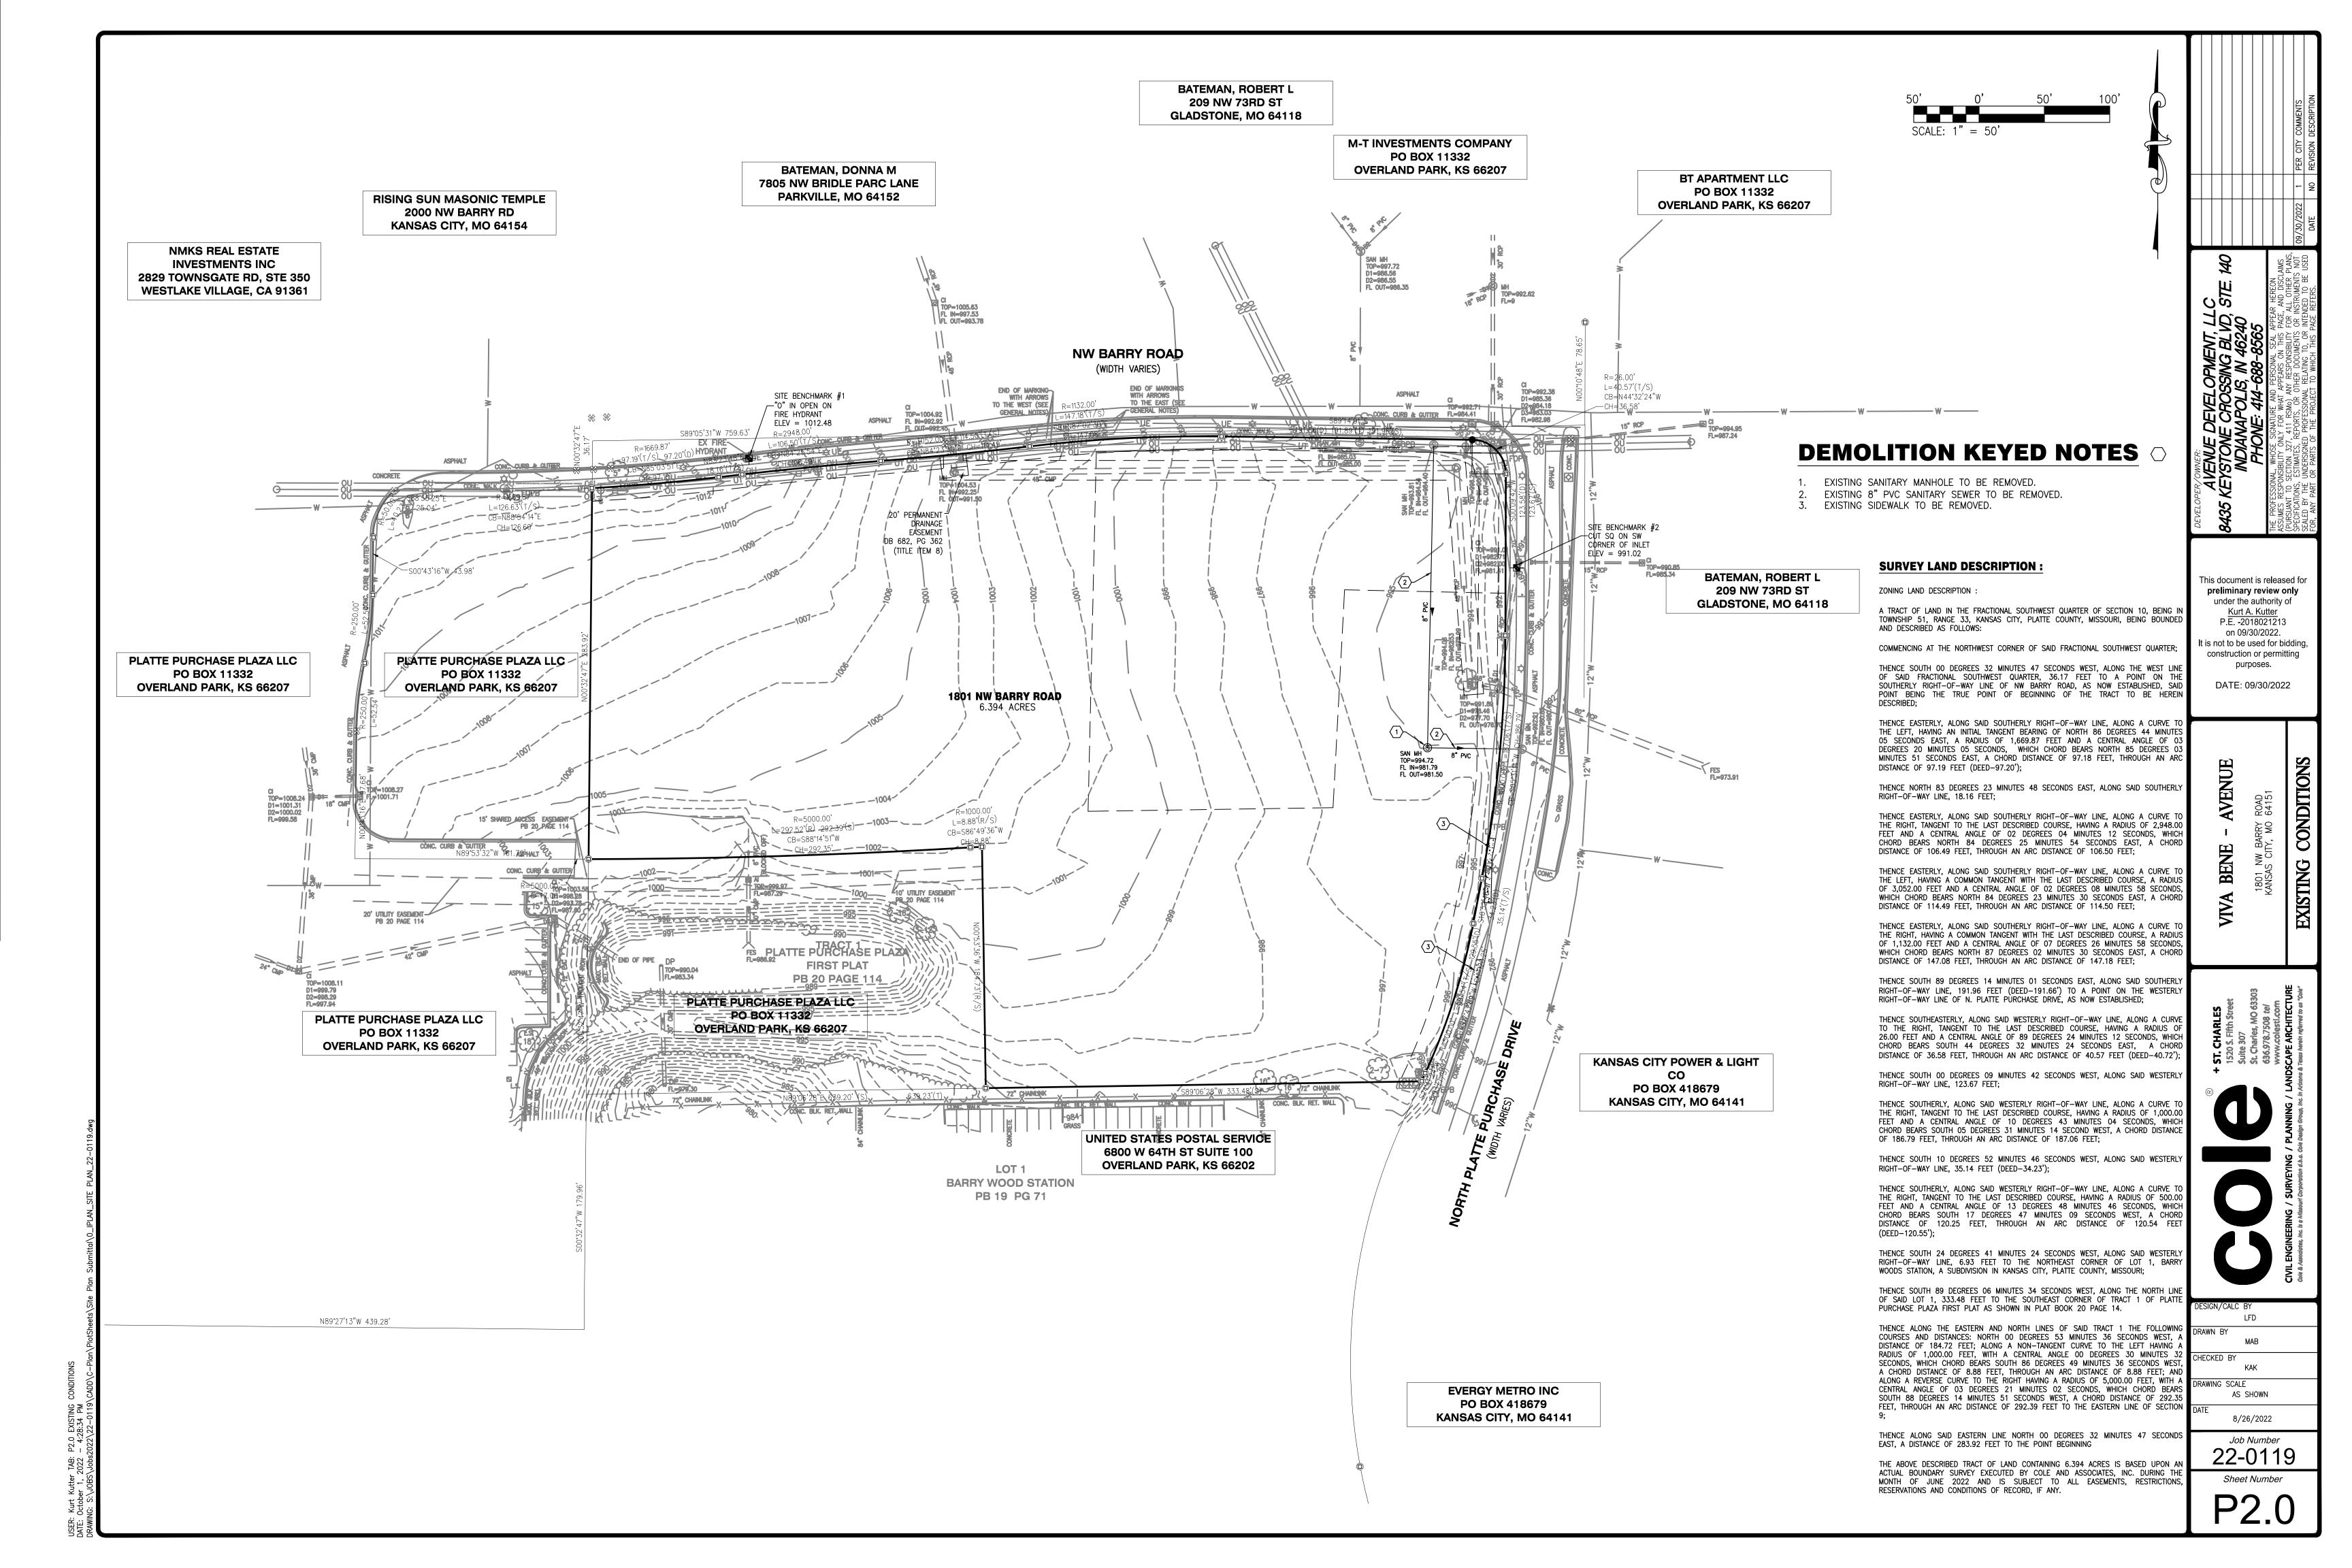

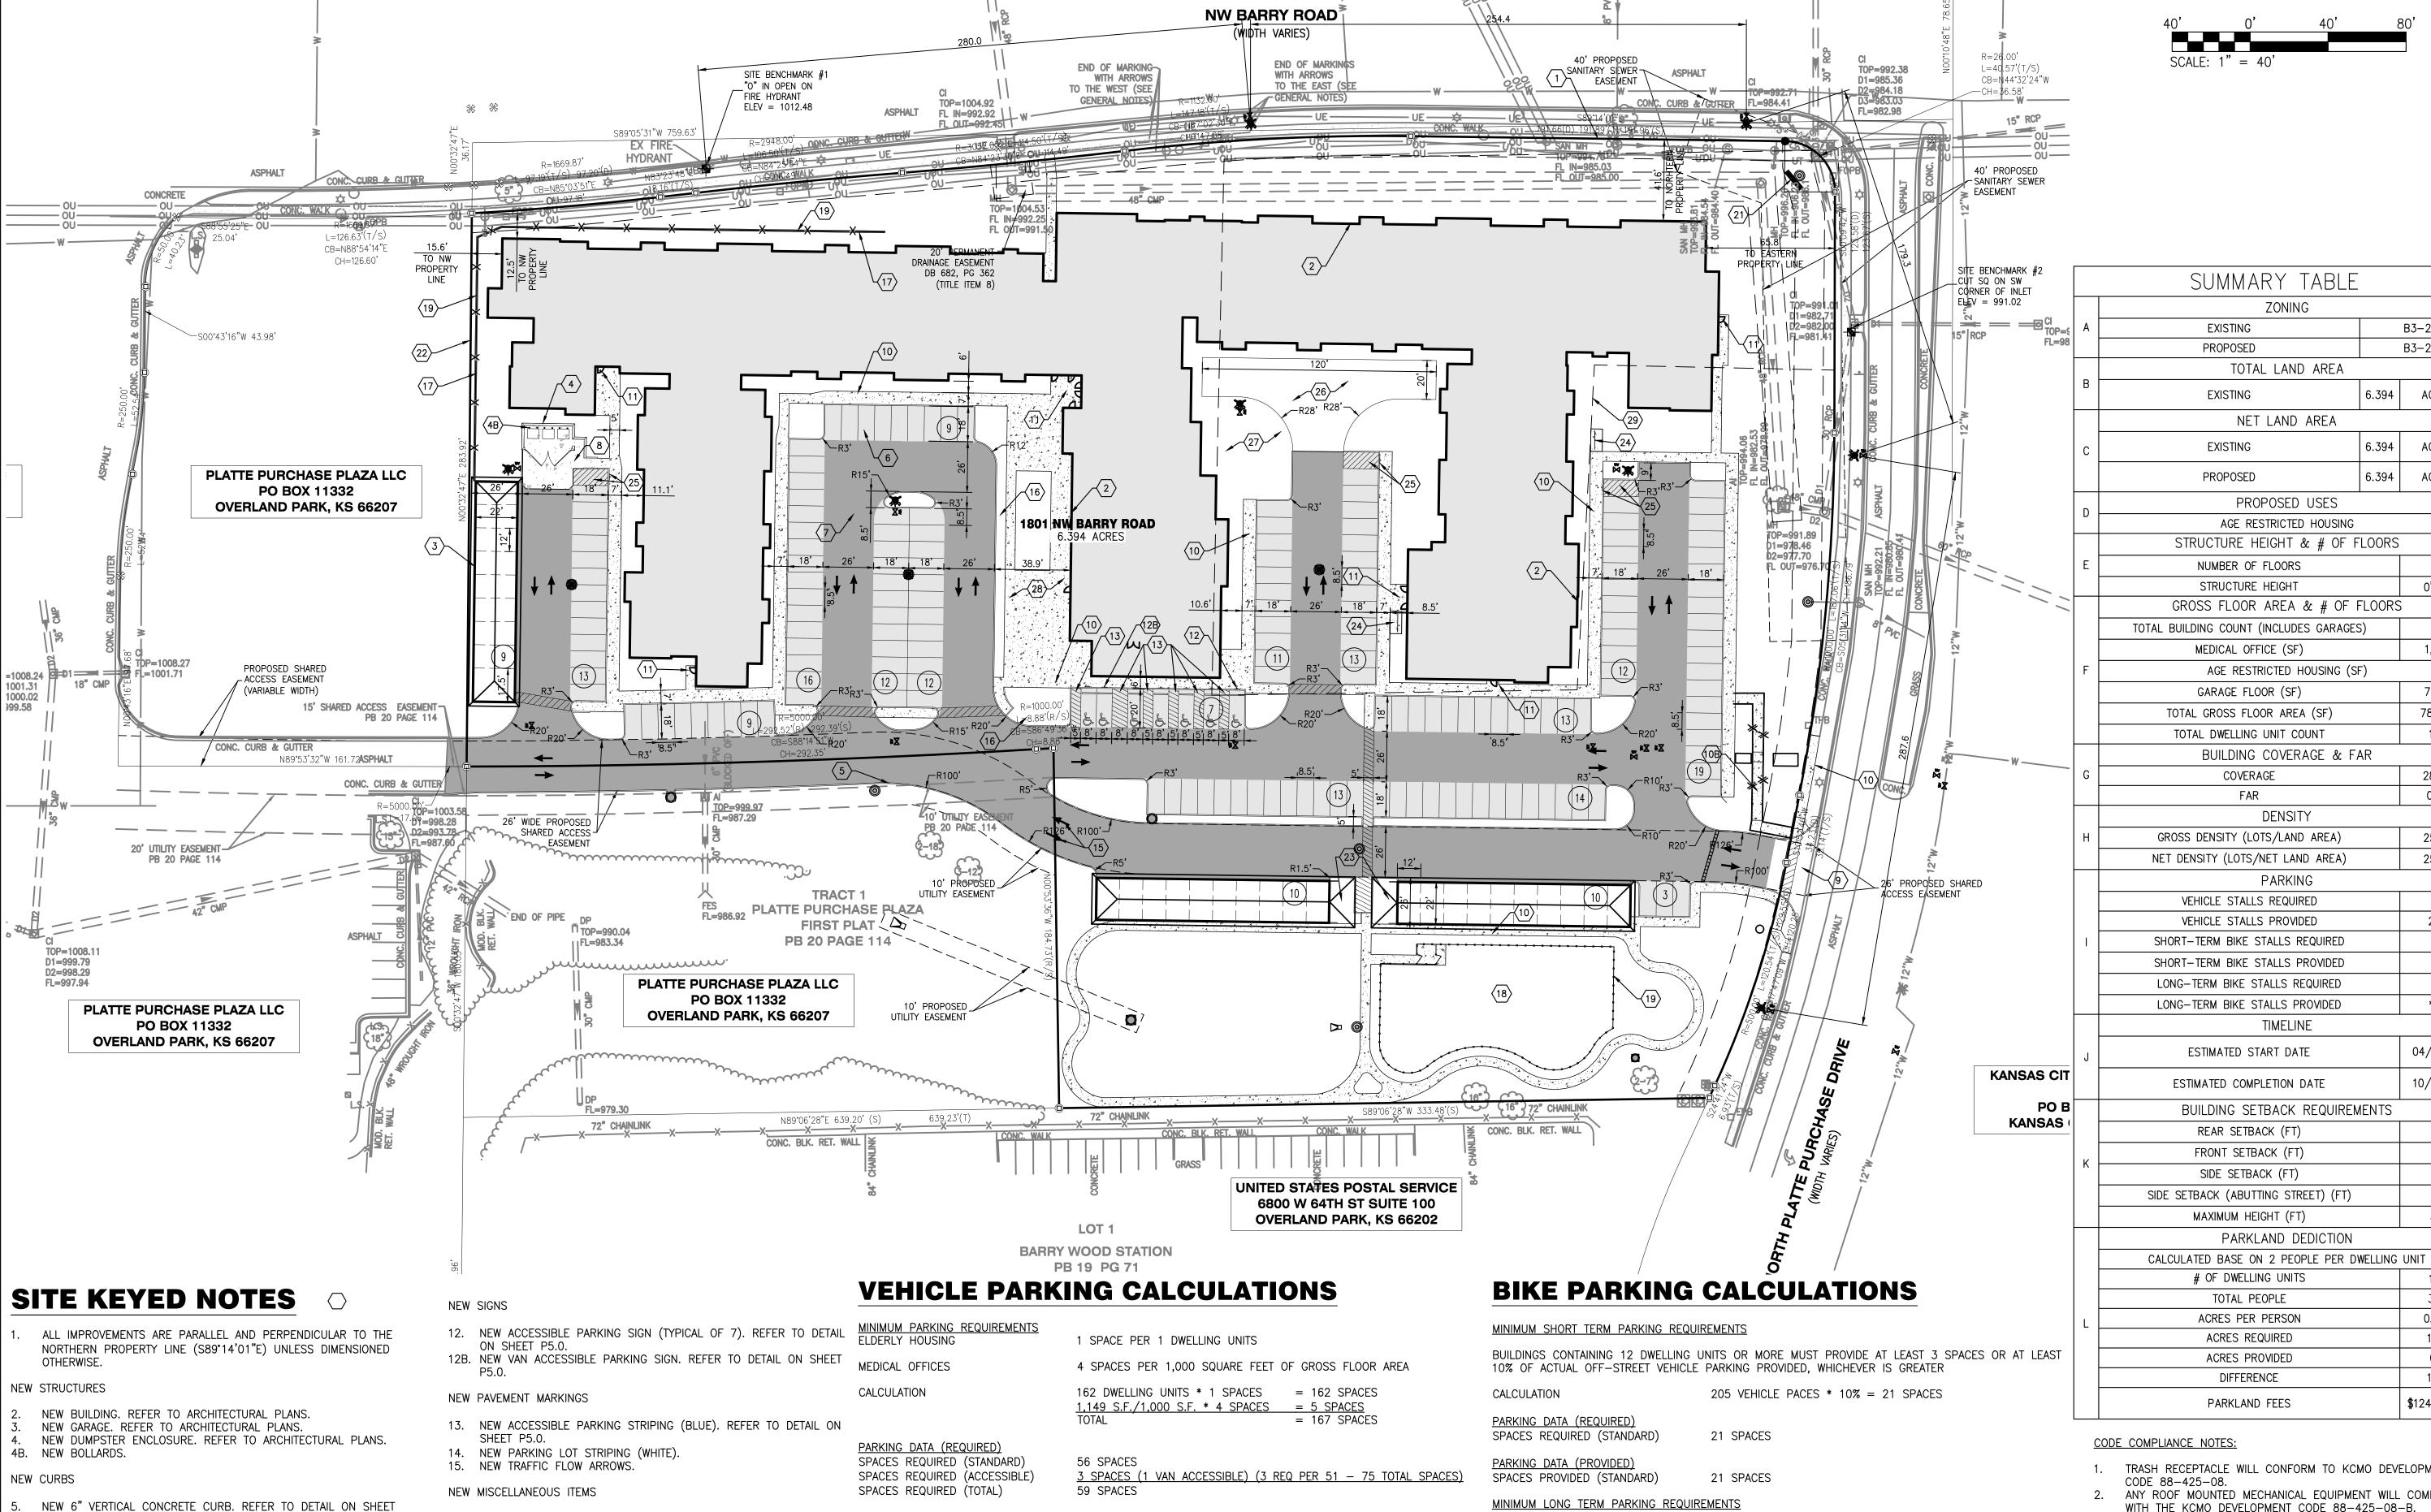

NEW PAVEMENTS

NEW ASPHALT PAVEMENT (LIGHT DUTY). REFER TO DETAIL ON SHEET P5.0.

NEW ASPHALT PAVEMENT (HEAVY DUTY). REFER TO DETAIL ON SHEET P5.0. NEW CONCRETE PAVEMENT (HEAVY DUTY). REFER TO DETAIL ON

NEW CONCRETE APPROACH. PER CITY OF KANSAS CITY STANDARDS.

NEW SIDEWALKS

10. NEW CONCRETE SIDEWALK. REFER TO DETAIL ON SHEET P5.0. 10B. NEW ACCESSIBLE RAMP AND HANDRAILS. REFER TO ARCHITECTURAL. 11. PROPOSED BUILDING POINT OF ENTRY.

16. NEW LANDSCAPE AREA. REFER TO LANDSCAPING PLAN. 17. NEW RETAINING WALL. REFER TO DETAIL ON SHEET P5.0.

18. NEW DOG PARK. 19. NEW BLACK METAL FENCE. REFER TO DETAIL ON P6.0. 20. NEW LIGHT. REFER TO PHOTOMETRIC PLANS. 21. NEW MONUMENT SIGN BY SEPARATE PERMIT.

EXISTING PROPERTY LINE 23. NEW COVERED BIKE RACK (30 SPACES). REFER TO ARCHITECTURAL

WEIGHT OF 85,000 LBS) (REFER TO LANDSCAPING).

SHALL SUPPORT KANSAS CITY FIRE APARATUS WITH GROSS AXLE

24. NEW BIKE RACK. REFER TO DETAIL ON P6.0.

25. NEW STRIPED TURN AROUND WITH "NO PARKING" SIGN. 26. BOCHE BALL COURT AND PERMEABLE GRASS PAVERS. (PAVERS

27. PICKLEBALL COURT (REFER TO LANDSCAPING).

28. NEW POOL (REFER TO LANDSCAPING). 29. EXISTING UTILITY EASEMENT (TO BE VACATED)

169 SPACES 29 SPACES

PARKING DATA (PROVIDED)

SPACES PROVIDED (TOTAL)

SPACES PROVIDED (STANDARD)

SPACES PROVIDED (COVERED)

SPACES PROVIDED (ACCESSIBLE)

7 SPACES (1 VAN ACCESSIBLE) (7 REQ PER 151 - 200 TOTAL SPACES 205 SPACES

MINIMUM LONG TERM PARKING REQUIREMENTS

PARKING DATA (PROVIDED)

SPACES PROVIDED (STANDARD)

ELDERLY HOUSING 1 SPACE PER 3 DWELLING UNITS

MEDICAL OFFICES 1 + 1 SPACE PER 10,000 SQUARE FEET OF GROSS FLOOR CALCULATION 162 DWELLING UNITS * 0.33 SPACES = 54 SPACES

1,149 S.F./10,000 S.F. * (1)+1 SPACE = 2 SPACES = 56 SPACES PARKING DATA (REQUIRED) SPACES REQUIRED (STANDARD) 56 SPACES

30 SPACES

TRASH RECEPTACLE WILL CONFORM TO KCMO DEVELOPMENT

ANY ROOF MOUNTED MECHANICAL EQUIPMENT WILL COMPLY

WITH THE KCMO DEVELOPMENT CODE 88-425-08-B. ANY SITE SIGNAGE WILL COMPLY WITH THE KCMO DEVELOPMENT

CODE 88-445.

REQUEST FOR REDUCTION IN COUNT FOR LONG TERM BIKE REQUIREMENTS FROM 56 TO 30.

30 LONG TERM BIKE STORAGE RACKS NEAR GARAGES AND DOG PARK AREA ARE PROPOSED. IN ADDITION TO THE 30 LONG TERM STORAGE AREA THE FOLLOWING

ARE ADDITIONAL STORAGE OPTIONS: GARAGE STORAGE - 29 PRIVATE GARAGE SPACES

PERSONAL STORAGE AVAILABLE ON 2ND OR 3RD FLOOR.

Job Number 22-0119 INSIDE UNIT ON GROUND FLOOR - 52 UNITS TOTAL

B3-2

B3-2

ACRES

ACRES

ACRES

0'-0"

4

1,149

7,716

78,853

162

28.3%

0.72

25.34

25.34

59

21

22

56

*30

04/01/23

10/01/24

NA

NA

NA

NA

45'

162

324

0.006

1.94

0.0

1.94

\$124,587.15

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Sheet Number


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AS SHOWN

8/26/2022

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DRAWING SCALE



- NEW PRIVATE 8" WATER MAIN.
- NEW PRIVATE 3" DOMESTIC WATER SERVICE.
- NEW 1" WATER BORE PER CITY OF KANSAS CITY STDS. .
- NEW PRIVATE 6" FIRE SERVICE. 6B. NEW 8" WATER METER AND BACKFLOW IN HEATED ENCLOSURE PIT PER
- CITY OF KANSAS CITY STANDARDS.
- 6C. NEW PRIVATE 6" WATER MAIN.
- NEW GATE VALVE.
- NEW PUBLIC FIRE HYDRANT PER CITY OF KANSAS CITY STANDARDS. 8B. NEW PRIVATE FIRE HYDRANT PER CITY OF KANSAS CITY STANDARDS.
- NEW 1" TAP AND IRRIGATION METER PER CITY OF KANSAS CITY STANDARDS.
- 9B. NEW DOUBLE CHECK VALVE AND BACKFLOW PREVENTER ENCLOSURE.

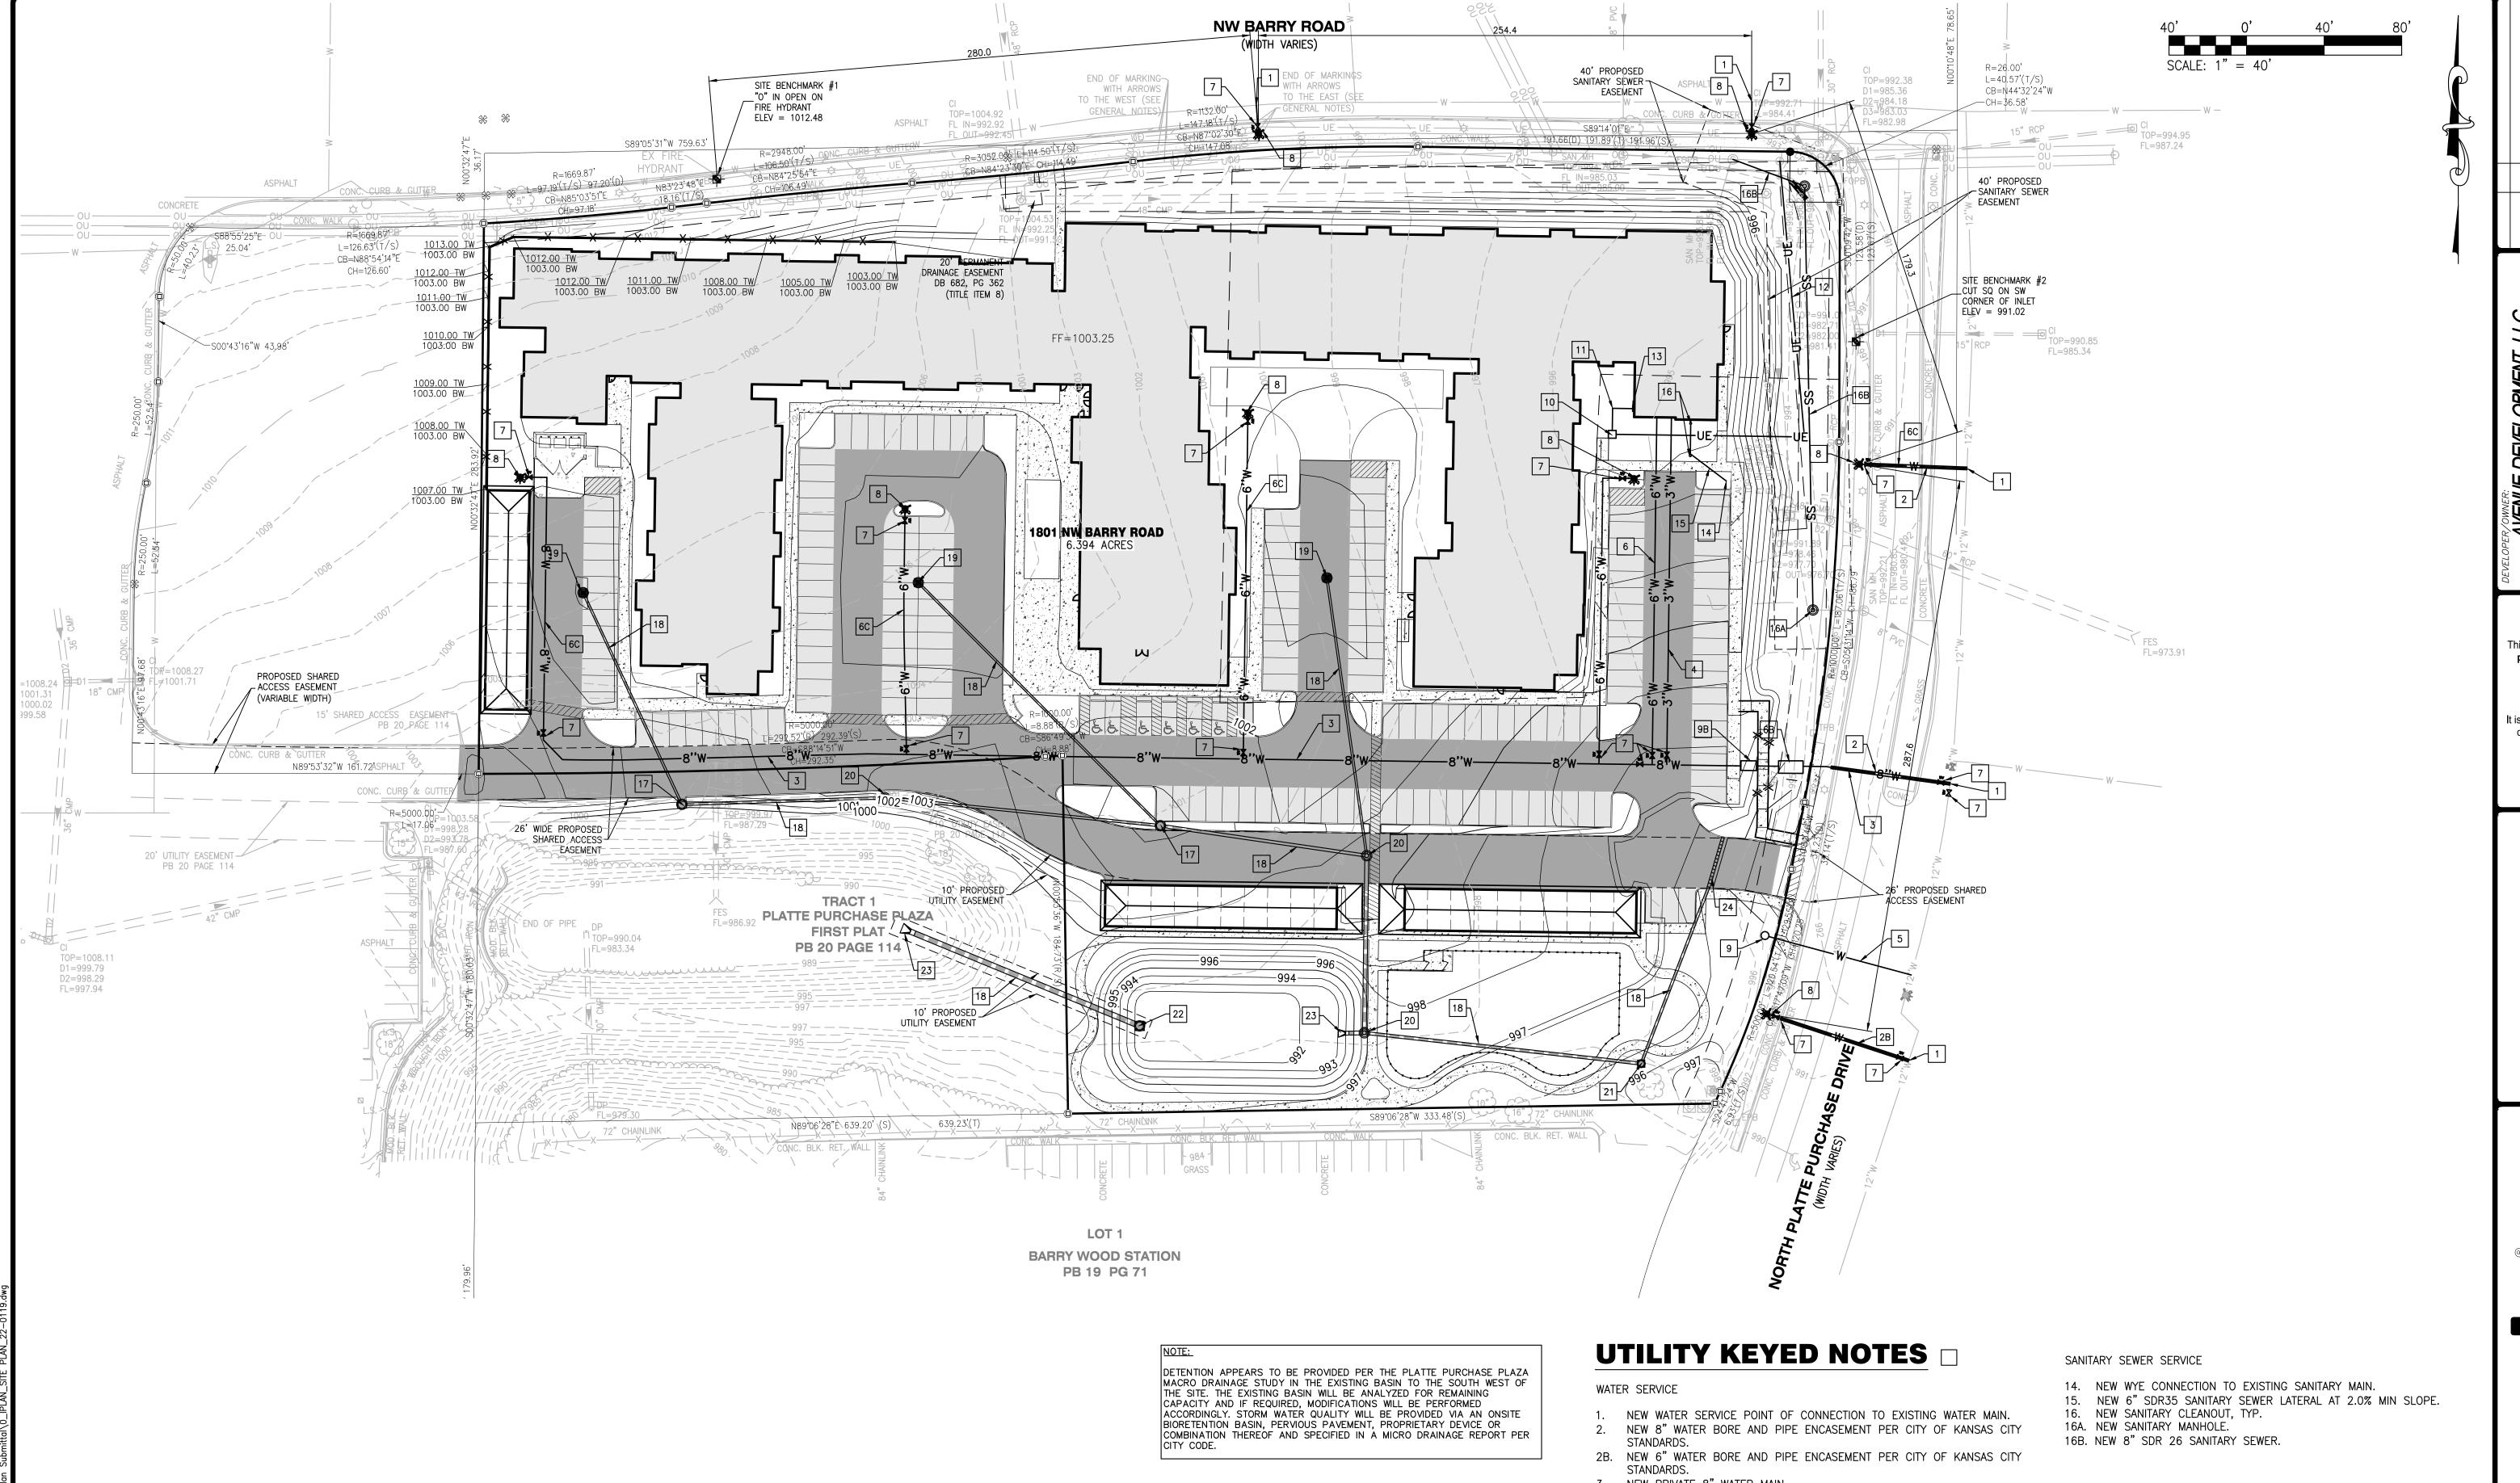ELECTRIC SERVICE

- 10. NEW TRANSFORMER AND PAD.
- 11. NEW SECONDARY ELECTRIC SERVICE.
- 12. NEW PRIMARY ELECTRIC SERVICE. 13. NEW ELECTRIC METERS.

STORM SEWER SERVICE

- 17. NEW STORM SEWER CURB INLET.
- 18. NEW STORM SEWER. 19. NEW STORM SEWER GRATED INLET.
- 20. NEW STORM SEWER MANHOLE. 21. NEW NYLOPLAST YARD DRAIN.
- 22. NEW OUTFALL STRUCTURE. 23. NEW FLARED END SECTION.

24. NEW TRENCH DRAIN.

ALL PROPOSED WATER AND FIRE SERVICE LINES SHOULD MEET CURRENT WATER SERVICES DEPARTMENT RULES AND REGULATIONS. ALL PROPOSED WATER LINES SHALL HAVE A COVER OF NOT LESS THAN 4 FEET NOR MORE THAN 5 FEET.

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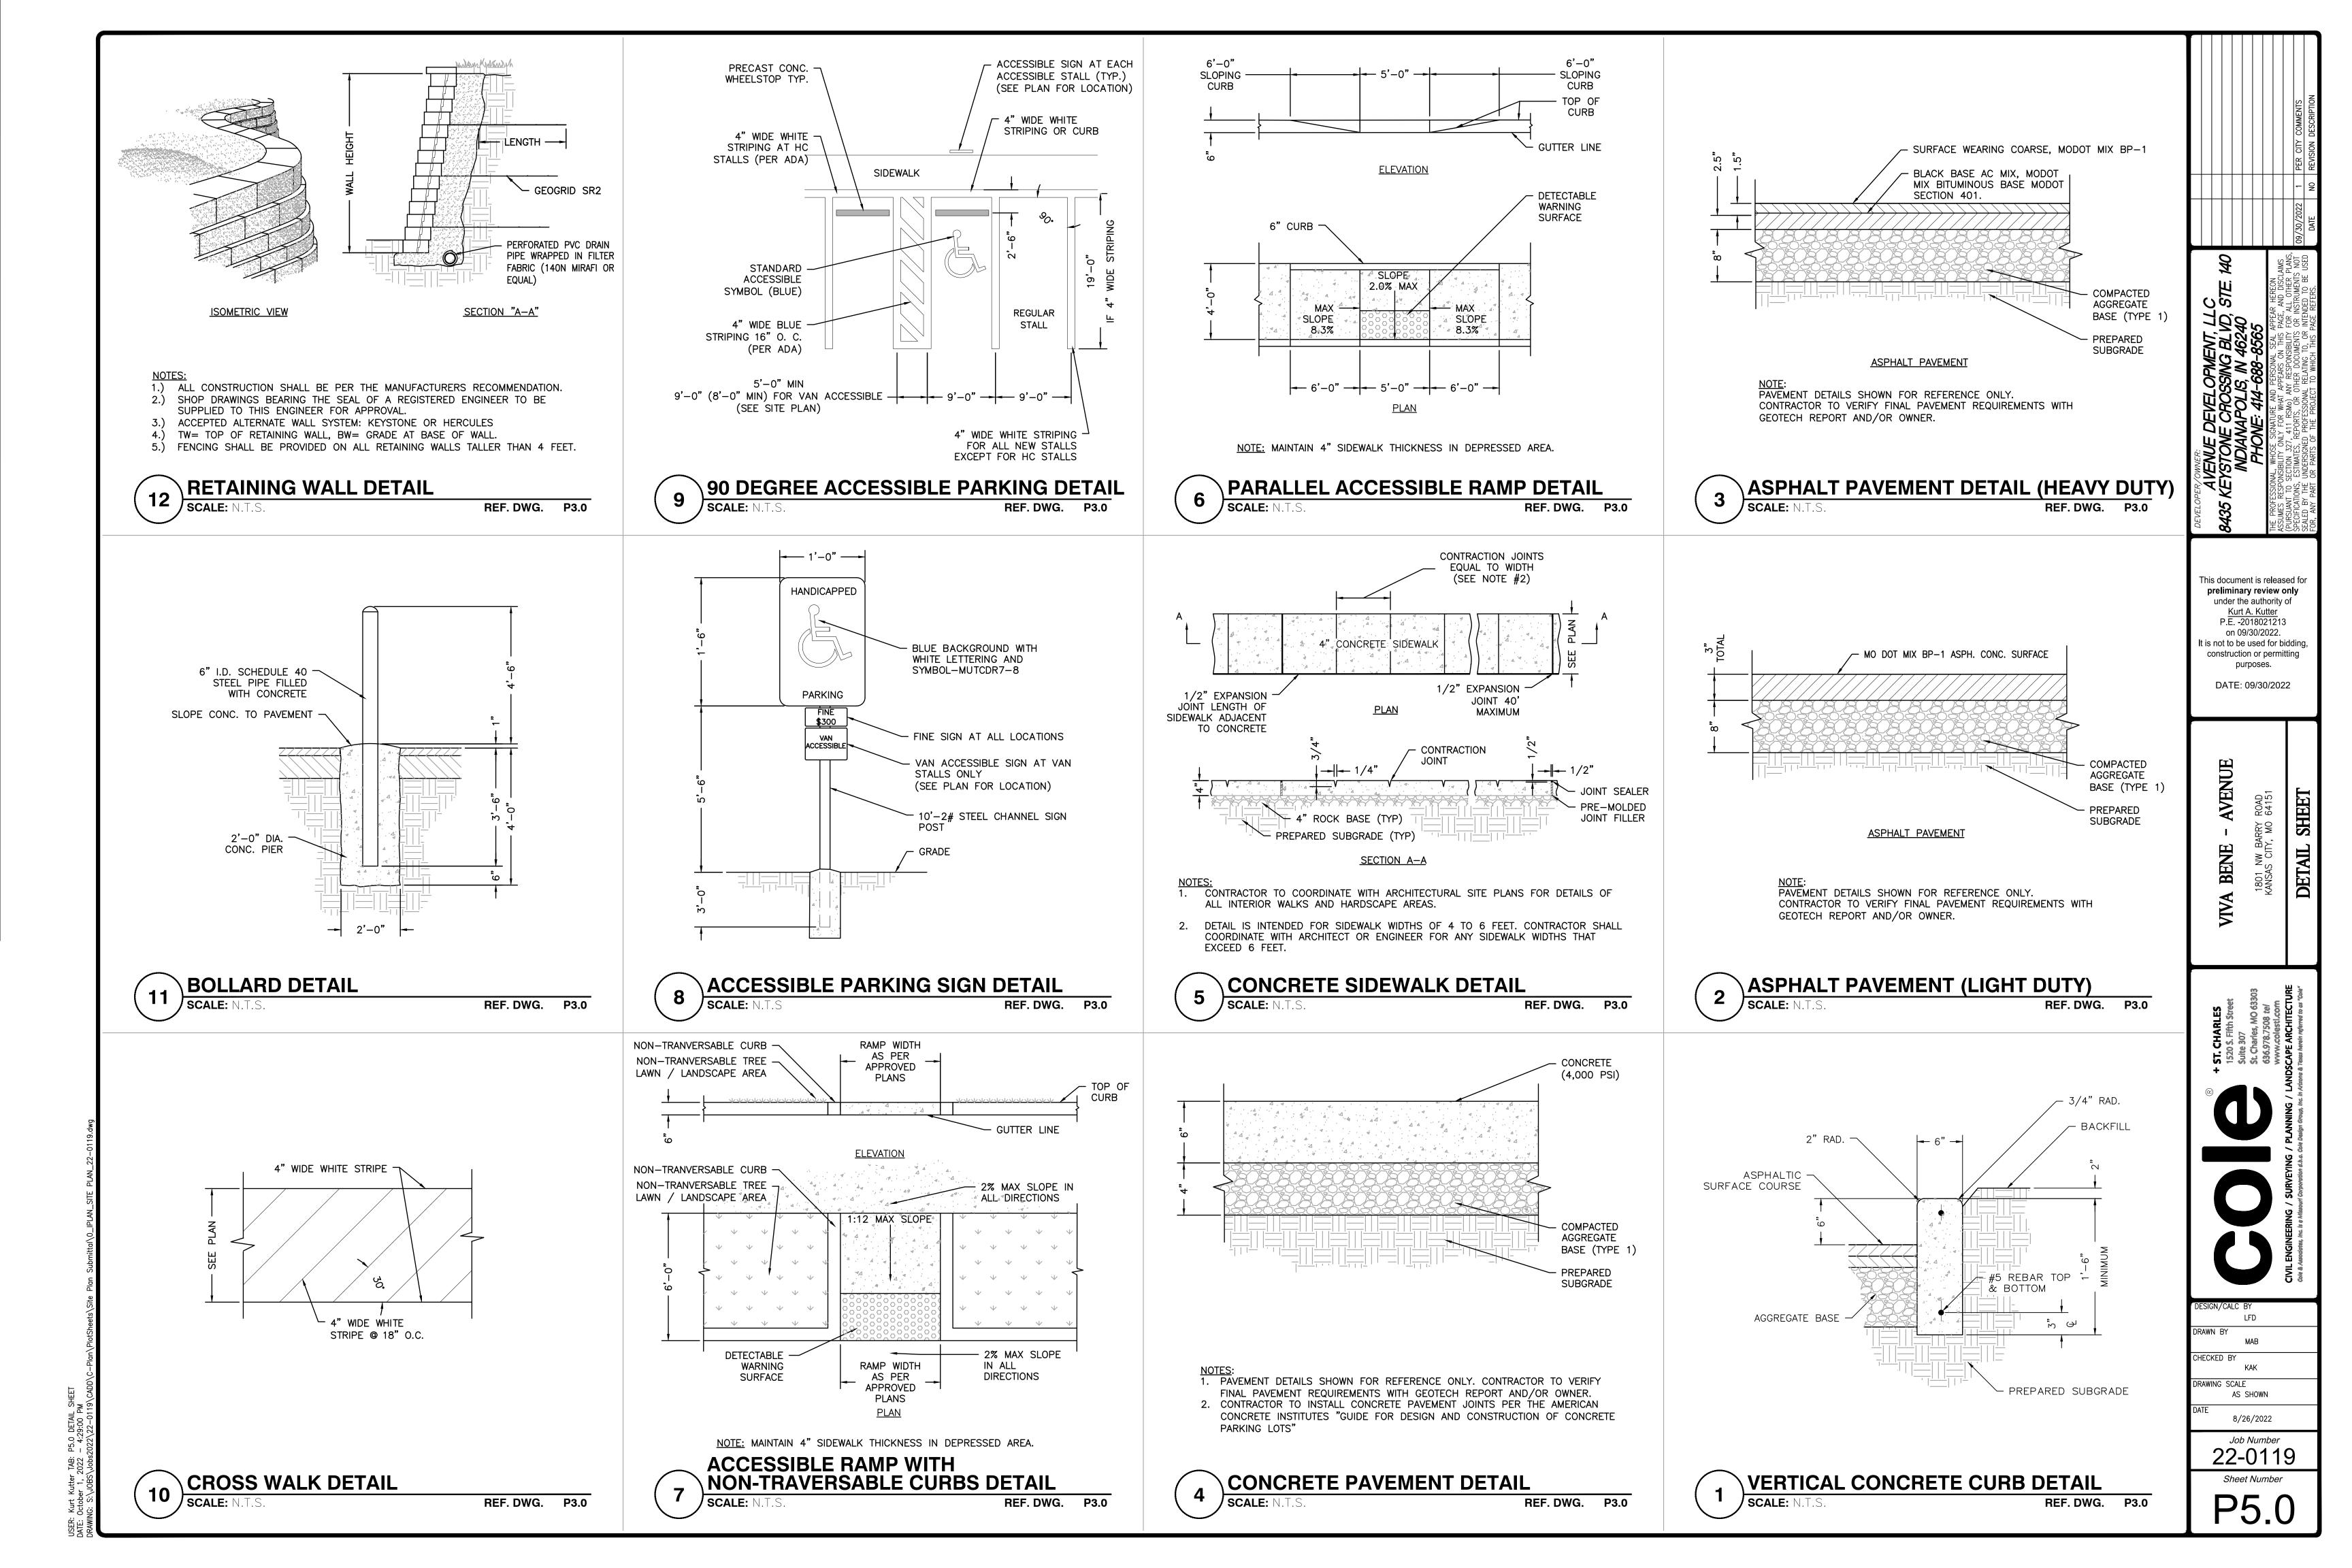
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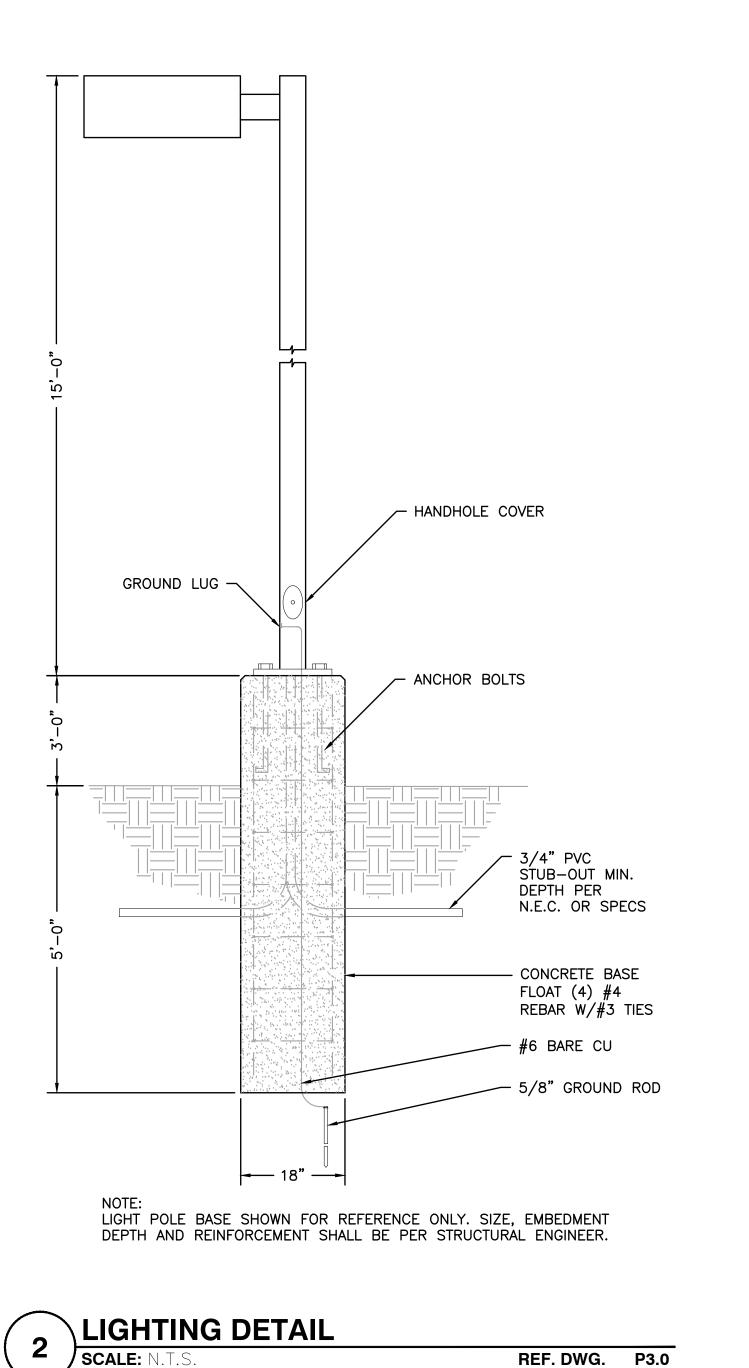
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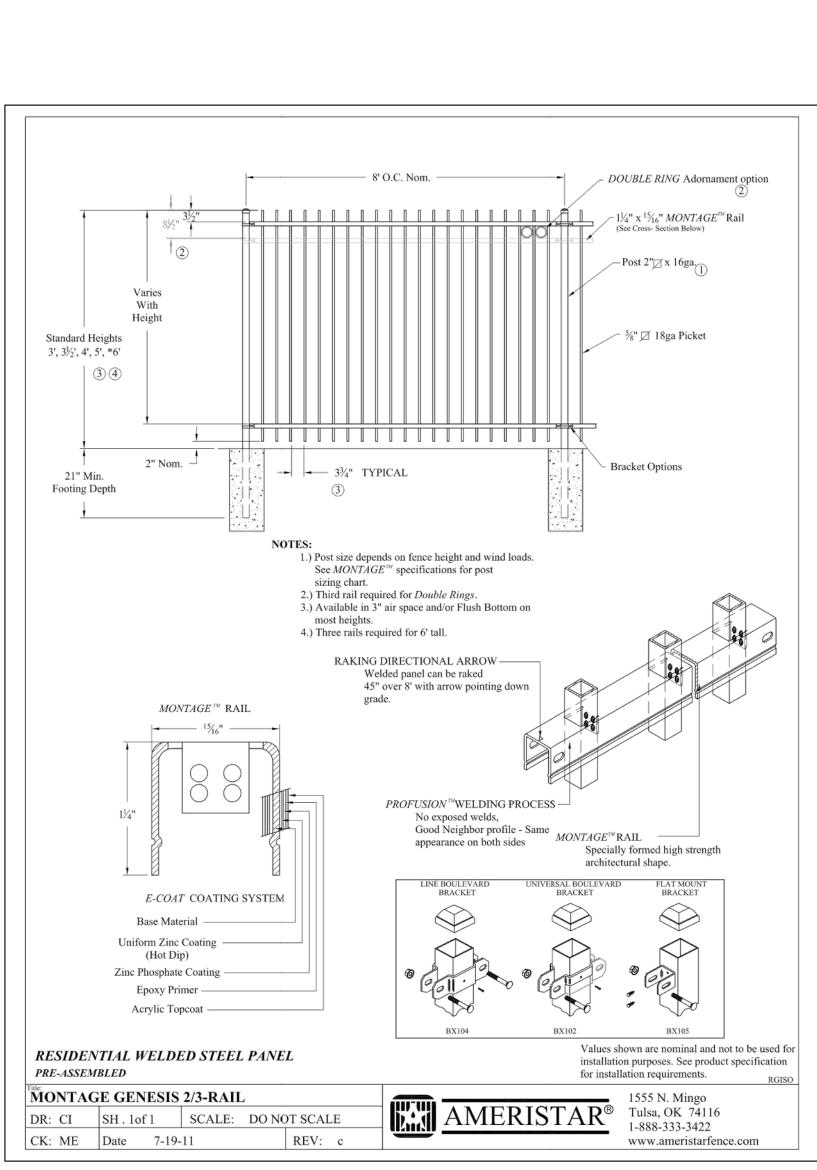
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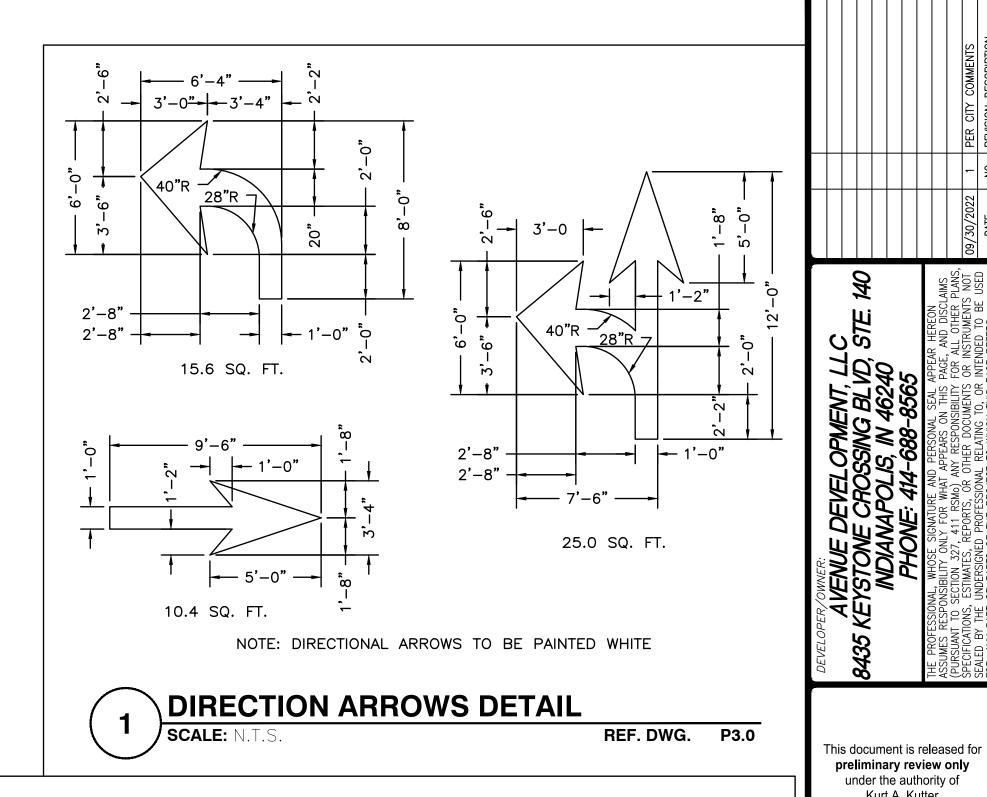
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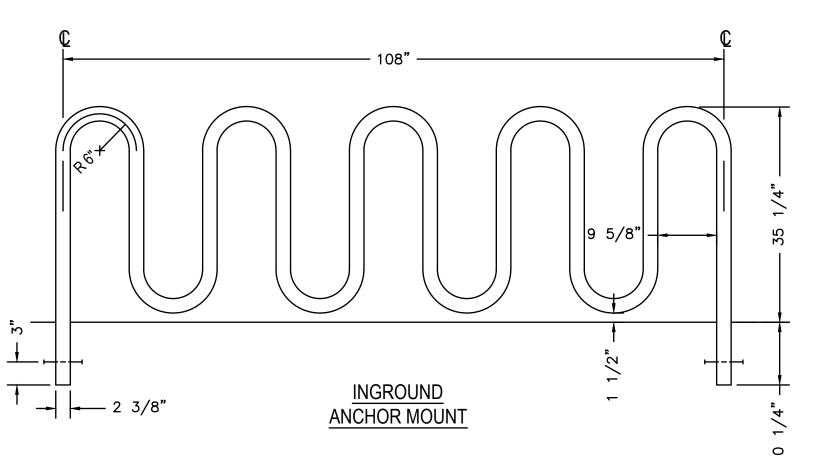







The Original RIBBON® BIKE RACK

A A A RIBBON BIKE RACK COMPANY 521 FIFTH AVENUE, 17TH FLOOR NEW YORK, NY 10175 TOLL FREE: 1 (800) 849-3488 www.ribbonrack.com



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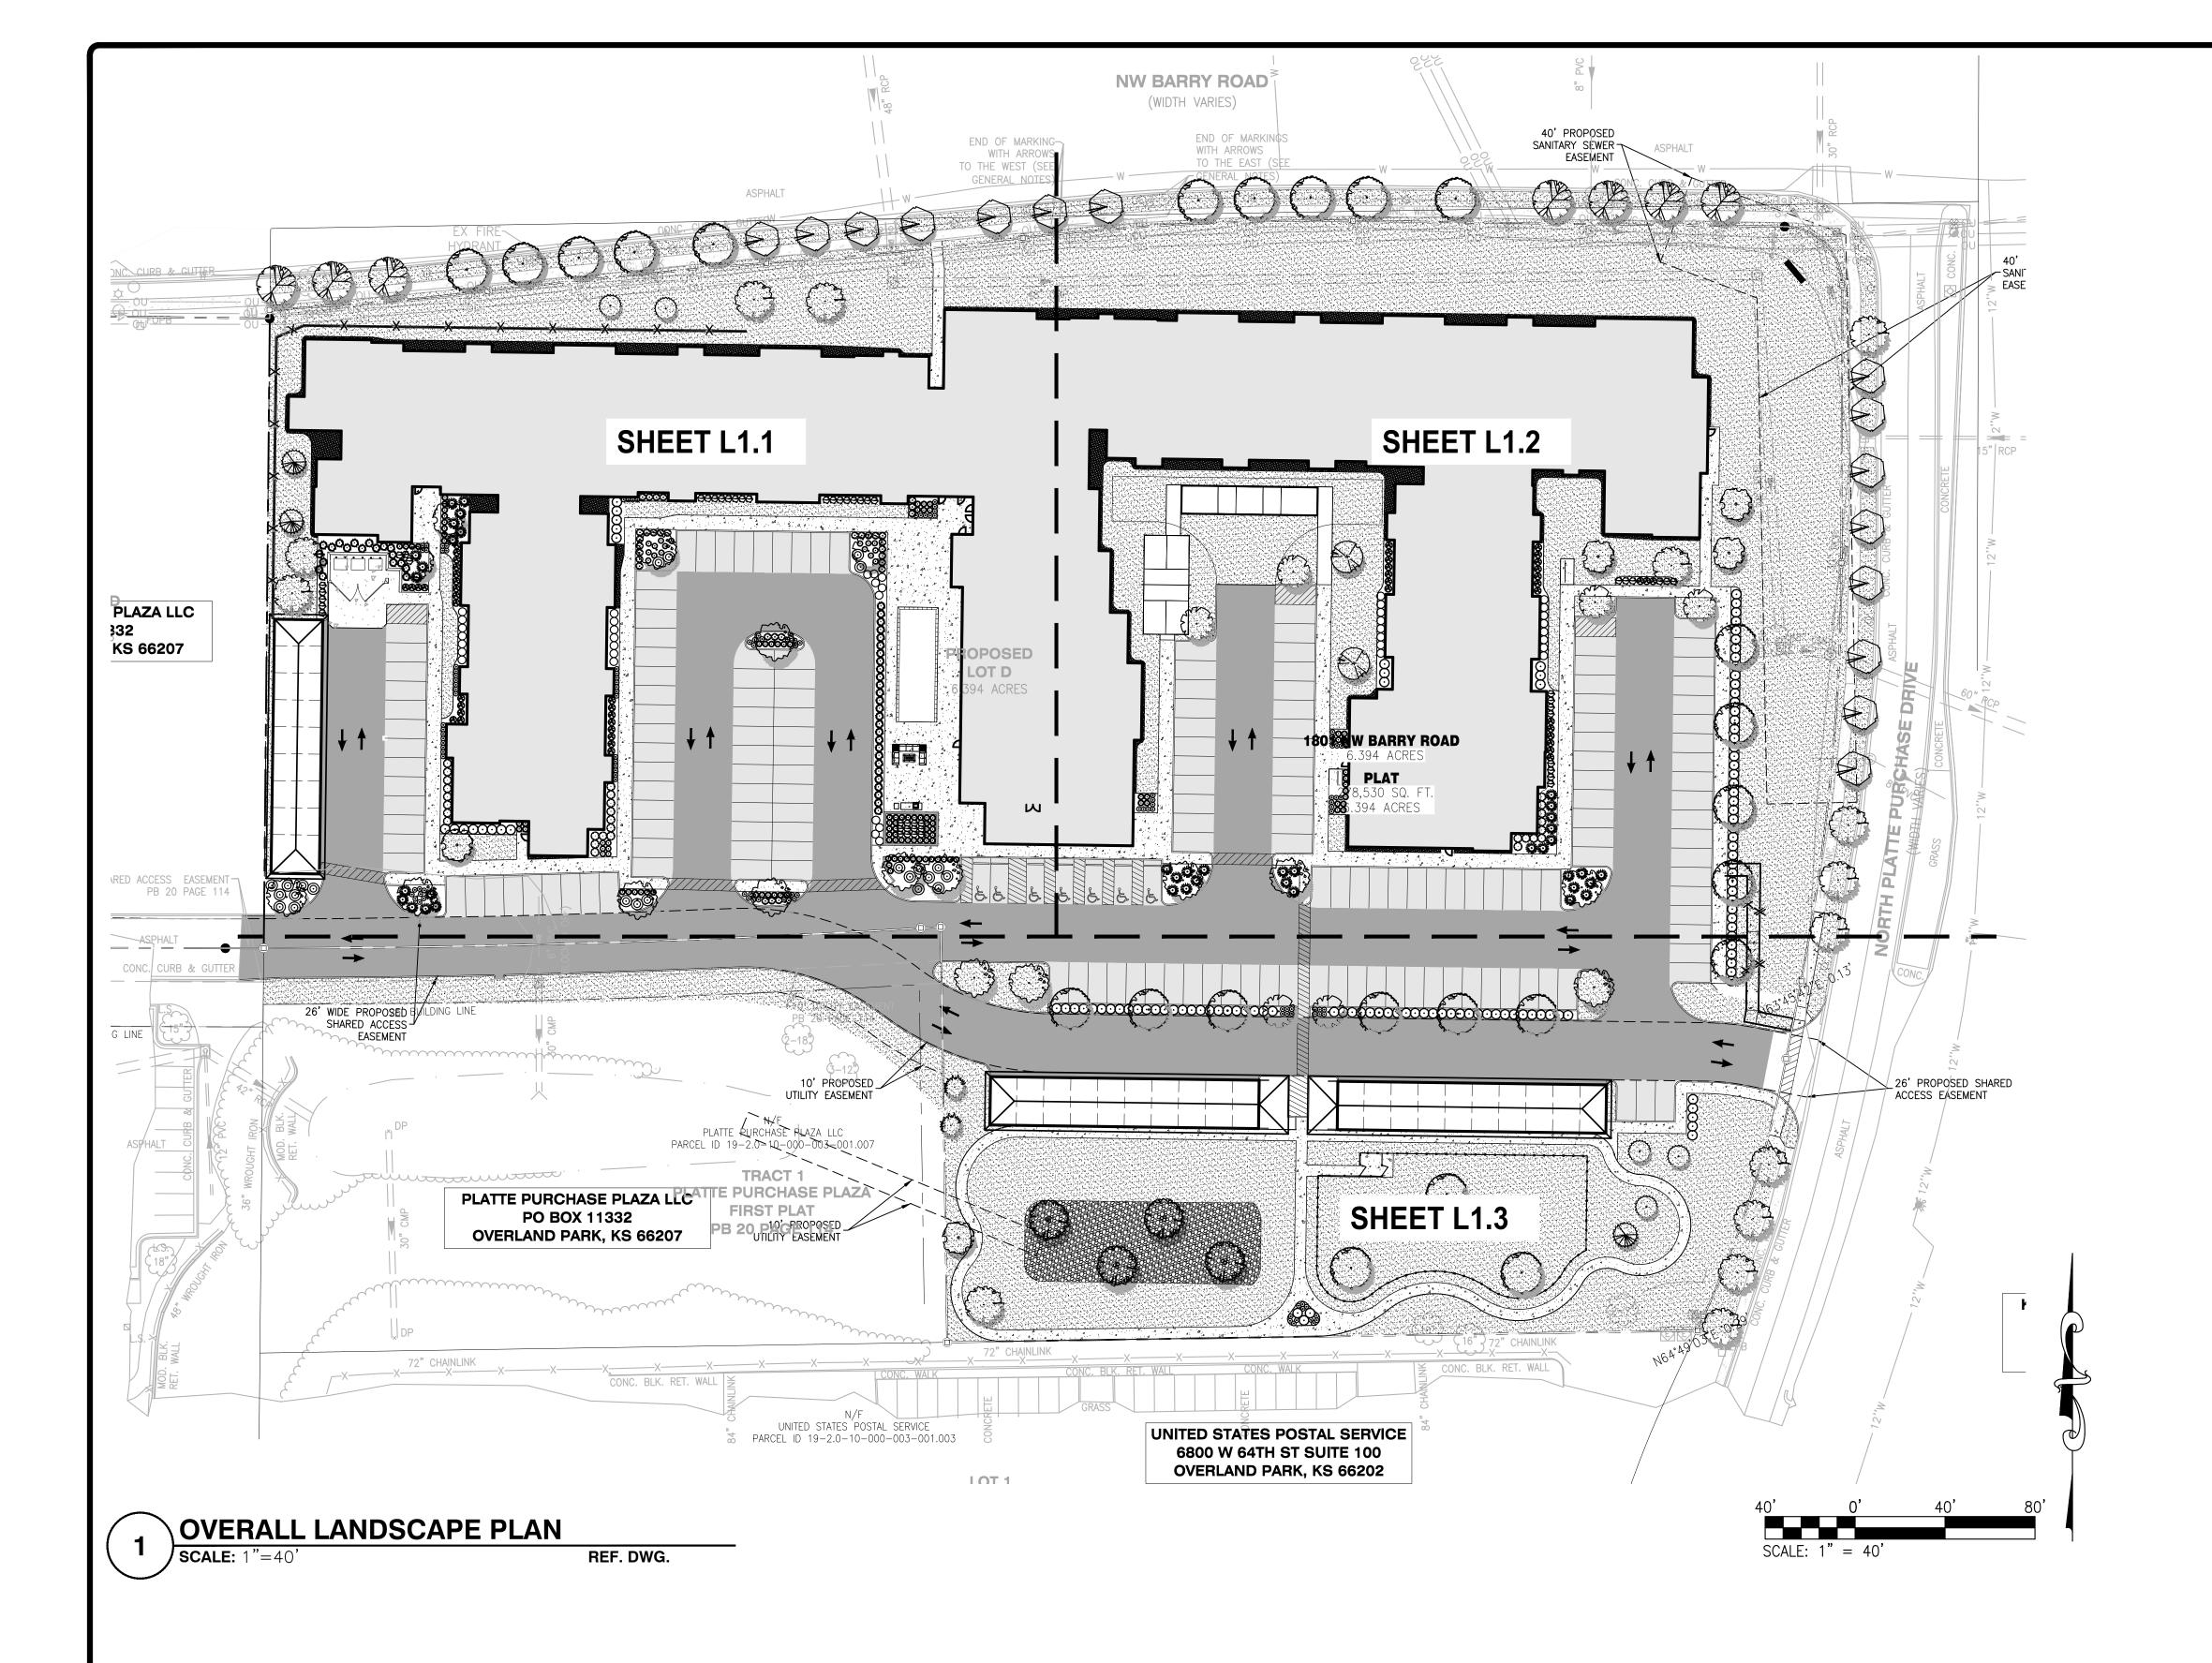
DATE: 09/30/2022
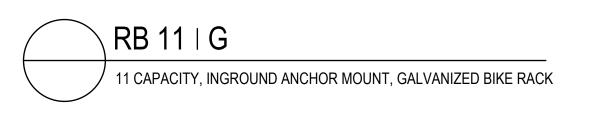
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22-0119 Sheet Number

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	T LANT GOTTLEGEL	
LARGE & MEDIUM DECIDUOUS TREES	BOTANICAL NAME	COMMON NAME
	Acer rubrum 'red sunset'	Rd Maple
	Quercus rubra	Red Oak
	Zelkova serrata 'JFS-KW1'	City Sprite zelkova
	Tilia americana	American Linden
Explanation of the second of t	Betula nigra 'BNMTF'	Dura Heat®River Birch
EVERGREEN TREES	BOTANICAL NAME	COMMON NAME
	Pinus echinata	Short—Leaf Pine
Why .	Juniperus virginiana	Red Cedar
	Thuja 'Green Giant'	Arborvitae
SMALL DECIDUOUS TREES	BOTANICAL NAME	COMMON NAME
	Cornus florida	Flowering Dogwood
	Cercis canadensis	Red Bud
	Amelanchier x grandiflora 'Autumn Brilliance'	Autumn Brilliance®Apple Serviceberry
	Carpinus caroliniana	American Hornbeam
SHRUBS	BOTANICAL NAME	COMMON NAME
\bigcirc	Buxus x 'Green Velvet'	Green Velvet Boxwood
	Taxus ×media	Yew
	Physocarpus opulifolius	Tiny Wine Ninebark
$\overline{\bigcirc}$	Juniperus ×pfitzeriana 'Sea Green'	Chinese Juniper
	ITEA VIRGINICA 'LITTLE HENRY'	'LITTLE HENRY' SWEET SPIRE
Sand Sand	Ceanothus americanus	New Jersey Tea
antalreys	Thuja occidentalis 'Smaragd'	Emerald Green Arborvitae
(i)	Rhus aromatica 'Gro-Low'	Gro-Low Fragrant Sumac
	Spiraea japonica	Japanese spirea
ORNAMENTAL GRASS & GROUND COVER	BOTANICAL NAME	COMMON NAME
GROUND COVER	Schizachyrium scoparium	Little Bluestem
	Sorghastrum nutans	Indiangrass
	Juniperus procumbens 'Green	Green Mound Juniper
79 1 100	Mound'	AREA TO BE TURF
		DECODATE CONT
		DECORATIVE GRAVEL

PLANT SCHEDULE

* SEE SHEET L1.4 FOR LANDSCAPE NOTES, CALCULATIONS AND FULL PLANT SCHEDULE WITH QUANTITIES

VEHICLE PARKING CALCULATIONS

MINIMUM PARKING REQUIREMENTS
ELDERLY HOUSING

1 SPACE PER 3 DWELLING UNITS

MEDICAL OFFICES 4 SPACES PER 1,000 SQUARE FEET OF GROSS FLOOR AREA CALCULATION

205 SPACES

162 DWELLING UNITS * 0.33 SPACES = 54 SPACES

<u>1,149 S.F./1,000 S.F. * 4 SPACES = 5 SPACES</u> TOTAL = 59 SPACES

PARKING DATA (REQUIRED) SPACES REQUIRED (STANDARD)

SPACES REQUIRED (ACCESSIBLE) SPACES REQUIRED (TOTAL)

PARKING DATA (PROVIDED)

SPACES PROVIDED (TOTAL)

SPACES PROVIDED (STANDARD) SPACES PROVIDED (COVERED)

SPACES PROVIDED (ACCESSIBLE)

3 SPACES (1 VAN ACCESSIBLE) (3 REQ PER 51 - 75 TOTAL SPACES) 59 SPACES

169 SPACES 29 SPACES 7 SPACES (1 VAN ACCESSIBLE) (7 REQ PER 151 - 200 TOTAL SPACES) PERTINENT DATA

SITE ADDRESS = 1801 NW BARRY ROAD KANSAS CITY, MO 64151

PARCEL ID = 231808

FIRE DISTRICT = KANSAS CITY FIRE DEPARTMENT FEMA MAP PANEL = 29095C0126G, DATE: JAN 20, 2017

GROSS SITE AREA = 6.394 AC.


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22-0119 Sheet Number



	KEYED NOTES						
KEY	FURNISHING	DETAIL					
1	PATIO STANDARD CONCRETE WITH BROOM FINISH, SCORED PER PLAN HAND TOOLED OR MACHINE CUT	SEE CIVIL DRAWINGS					
2	CONCRETE SIDEWALK STANDARD CONCRETE WITH BROOM FINISH, SCORED PER PLAN, HAND TOOLED OR MACHINE CUT	SEE CIVIL DRAWINGS					
$\boxed{3}$	TYPICAL SHRUB PLANTING	_					
4	TYPICAL FLOWERING/ORNAMENTAL TREE PLANTING	_					
5	TYPICAL LARGE DECIDUOUS TREE PLANTING	_					
6	TYPICAL EVERGREEN TREE PLANTING	_					
7	TYPICAL GROUND COVER PLANTING	-					
8	TYPICAL ORNAMENTAL GRAS PLANTING	_					

9	METAL EDGE	-
(10)	TURF	-
(11)	POOL	-
(12)	FIRE PIT	-
(13)	OUTDOOR KITCHEN	-
(14)	PICKLE BALL COURT	-
(15)	BOCCE BALL COURT	-
(16)	DOG PARK	_

LARGE & MEDIUM DECIDUOUS TREES	BOTANICAL NAME	COMMON NAME
	Acer rubrum 'red sunset'	Rd Maple
	Quercus rubra	Red Oak
E. J.	Zelkova serrata 'JFS-KW1'	City Sprite zelkova
	Tilia americana	American Linden
End of	Betula nigra 'BNMTF'	Dura Heat®River Birch
EVERGREEN TREES	BOTANICAL NAME	COMMON NAME
	Pinus echinata	Short—Leaf Pine
Mary .	Juniperus virginiana	Red Cedar
•	Thuja 'Green Giant'	Arborvitae
SMALL DECIDUOUS TREES	BOTANICAL NAME	COMMON NAME
	Cornus florida	Flowering Dogwood
Eight State of the	Cercis canadensis	Red Bud
	Amelanchier x grandiflora 'Autumn Brilliance'	Autumn Brilliance®Apple Serviceberry
	Carpinus caroliniana	American Hornbeam
SHRUBS	BOTANICAL NAME	COMMON NAME
0	Buxus x 'Green Velvet'	Green Velvet Boxwood
	Taxus ×media	Yew
	Physocarpus opulifolius	Tiny Wine Ninebark
$\overline{\bigcirc}$	Juniperus ×pfitzeriana 'Sea Green'	Chinese Juniper
	ITEA VIRGINICA 'LITTLE HENRY'	'LITTLE HENRY' SWEET SPIRE
(°)	Ceanothus americanus	New Jersey Tea
MW MAN	Thuja occidentalis 'Smaragd'	Emerald Green Arborvitae
- Frank	Rhus aromatica 'Gro-Low'	Gro-Low Fragrant Sumac
	Spiraea japonica	Japanese spirea
ORNAMENTAL GRASS &	BOTANICAL NAME	COMMON NAME
GROUND COVER	Schizachyrium scoparium	Little Bluestem
	Sorghastrum nutans	Indiangrass
Times .	Juniperus procumbens 'Green	Green Mound Juniper
TAME	Mound'	AREA TO BE TURF
		DECORATIVE GRAVEL

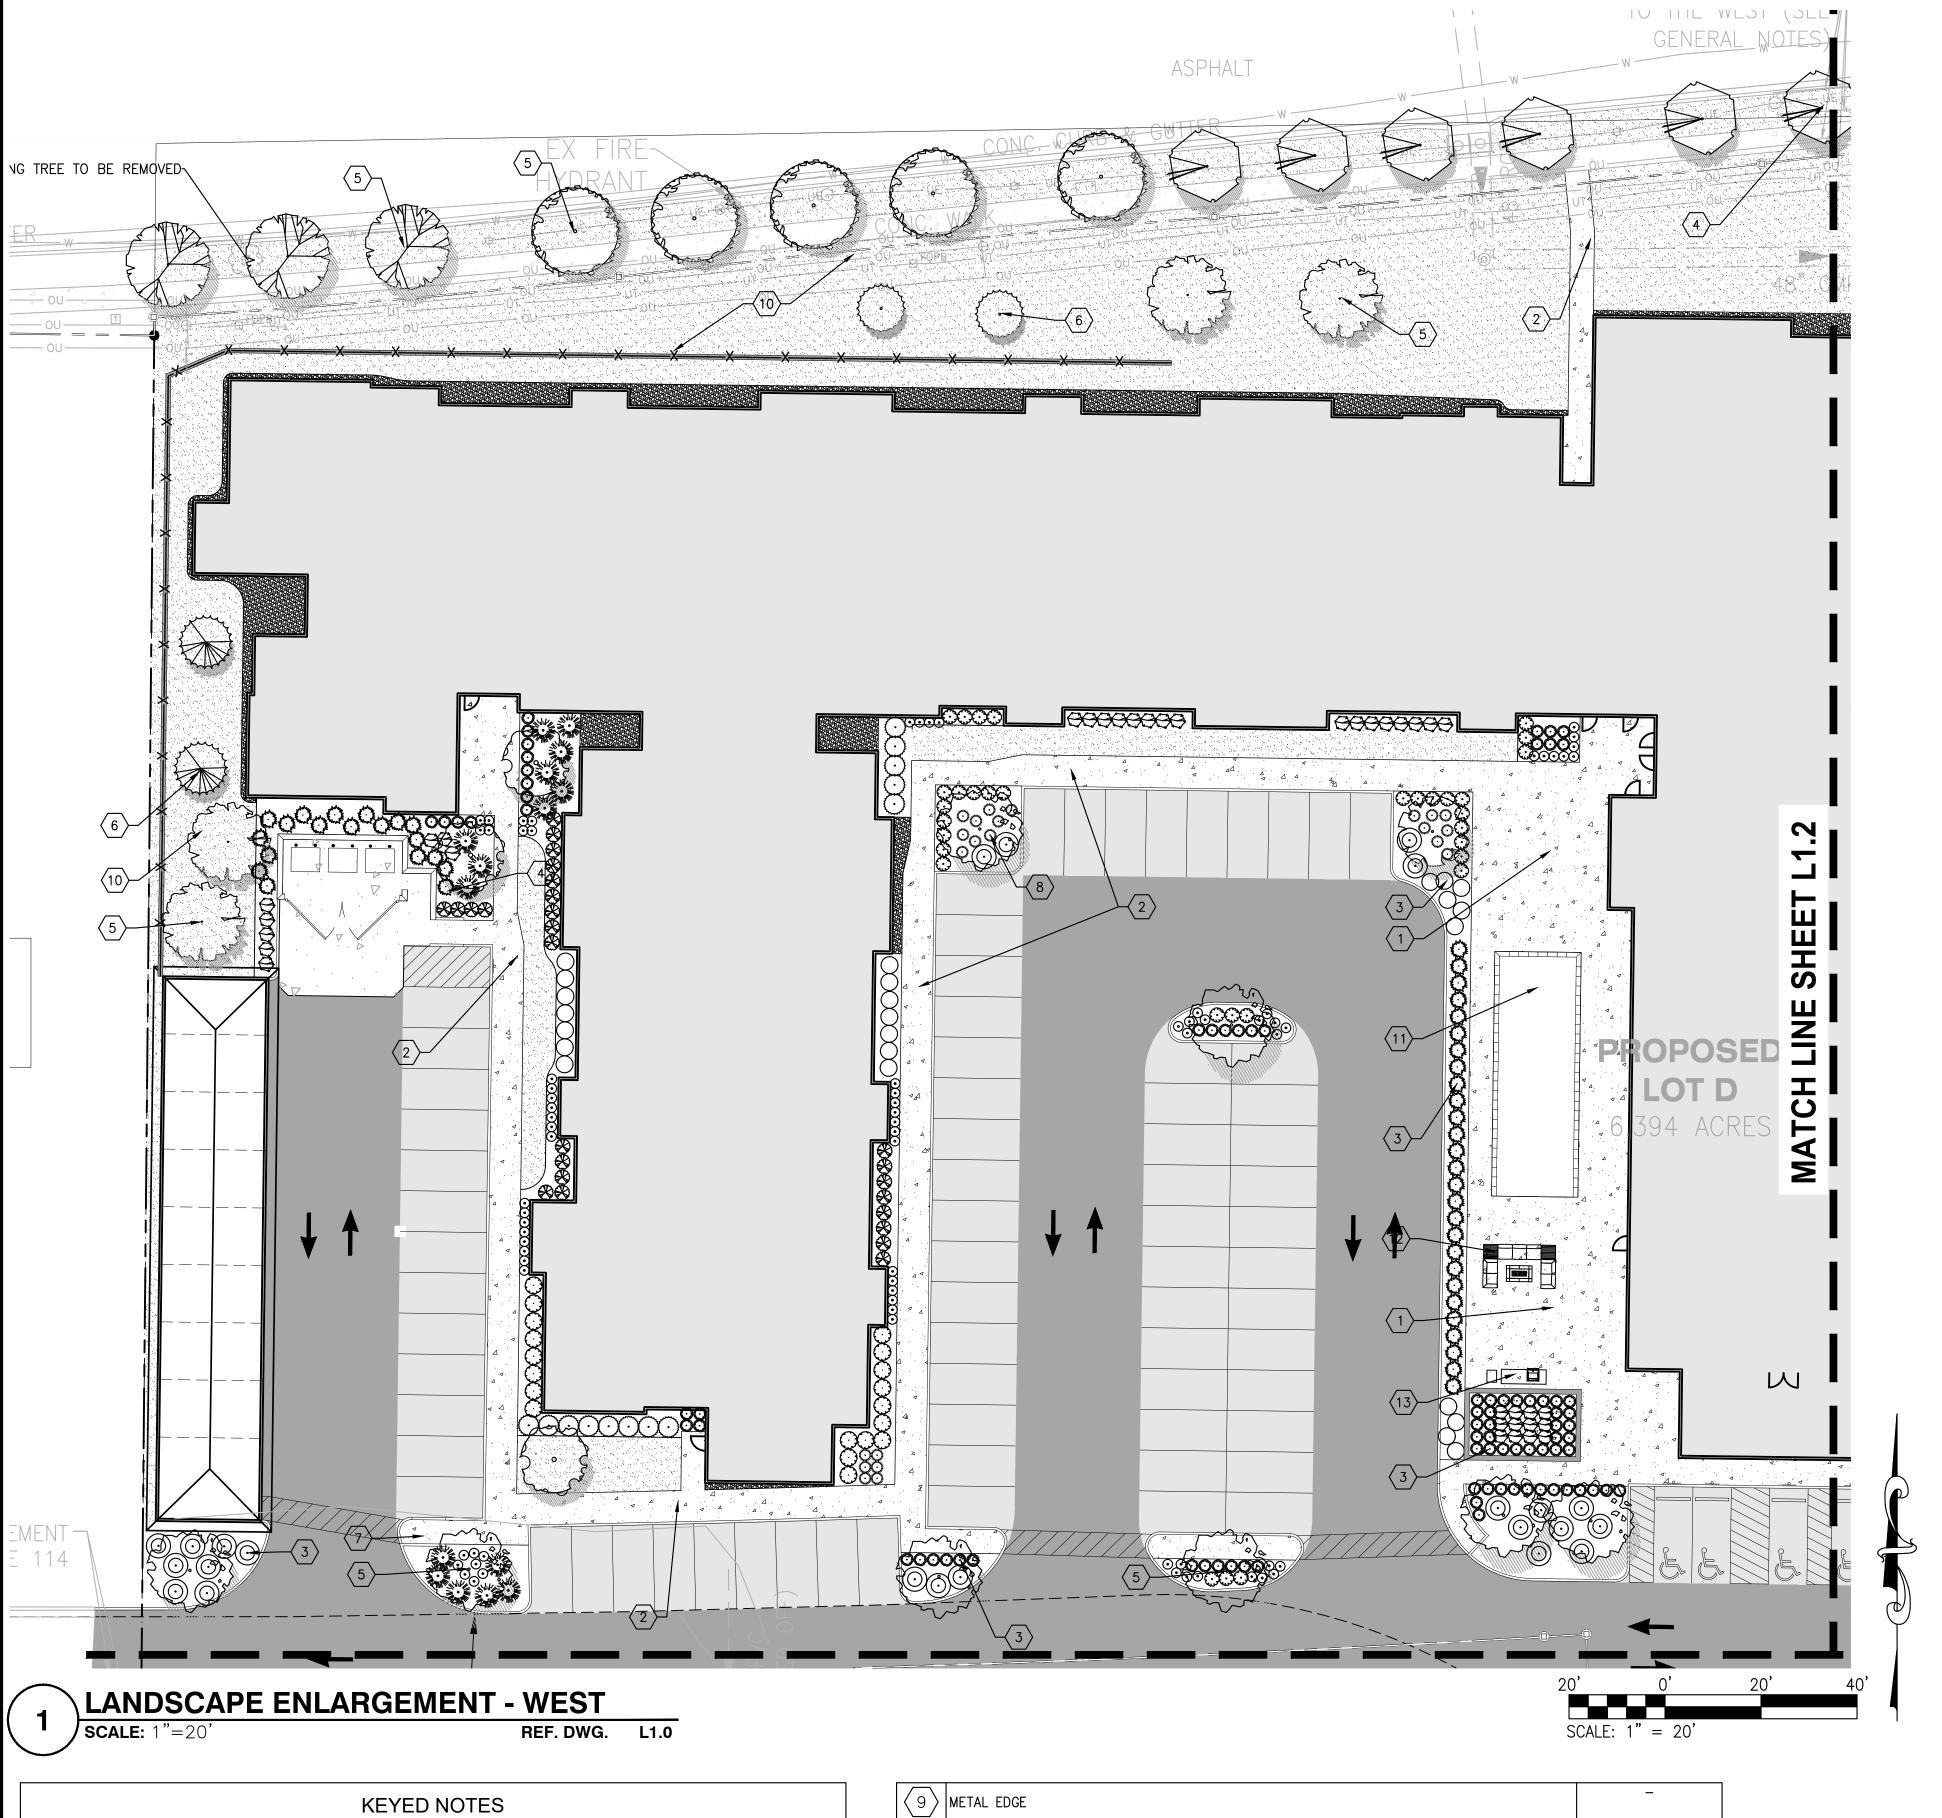
* SEE SHEET L1.4 FOR LANDSCAPE NOTES, CALCULATIONS AND FULL PLANT SCHEDULE WITH QUANTITIES

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8/26/2022 Job Number 22-0119



	Acer rubrum 'red sunset'	Rd Maple
	0	D. 1.0.1
	Quercus rubra	Red Oak
	Zelkova serrata 'JFS-KW1'	City Sprite zelkova
	Tilia americana	American Linden
E & B	Betula nigra 'BNMTF'	Dura Heat®River Birch
EVERGREEN TREES	BOTANICAL NAME	COMMON NAME
	Pinus echinata	Short-Leaf Pine
Mahy, war	Juniperus virginiana	Red Cedar
•	Thuja 'Green Giant'	Arborvitae
SMALL DECIDUOUS TREES	BOTANICAL NAME	COMMON NAME
	Cornus florida	Flowering Dogwood
	Cercis canadensis	Red Bud
	Amelanchier x grandiflora 'Autumn Brilliance'	Autumn Brilliance®Apple Serviceberry
	Carpinus caroliniana	American Hornbeam
SHRUBS	BOTANICAL NAME	COMMON NAME
0	Buxus x 'Green Velvet'	Green Velvet Boxwood
	Taxus ×media	Yew
	Physocarpus opulifolius	Tiny Wine Ninebark
\odot	Juniperus ×pfitzeriana 'Sea Green'	Chinese Juniper
$\overline{\bigcirc}$	ITEA VIRGINICA 'LITTLE HENRY'	'LITTLE HENRY' SWEET SPIR
£1.3	Ceanothus americanus	New Jersey Tea
Mary Markey E	Thuja occidentalis 'Smaragd'	Emerald Green Arborvitae
· mut	Rhus aromatica 'Gro—Low'	Gro-Low Fragrant Sumac
	Spiraea japonica	Japanese spirea
ORNAMENTAL GRASS &	BOTANICAL NAME	COMMON NAME
GROUND COVER	Schizachyrium scoparium	Little Bluestem
Similar Simila	Sorghastrum nutans	Indiangrass
Since	Juniperus procumbens 'Green	Green Mound Juniper
	Mound'	AREA TO BE TURF
		DECORATIVE GRAVEL

PLANT SCHEDULE

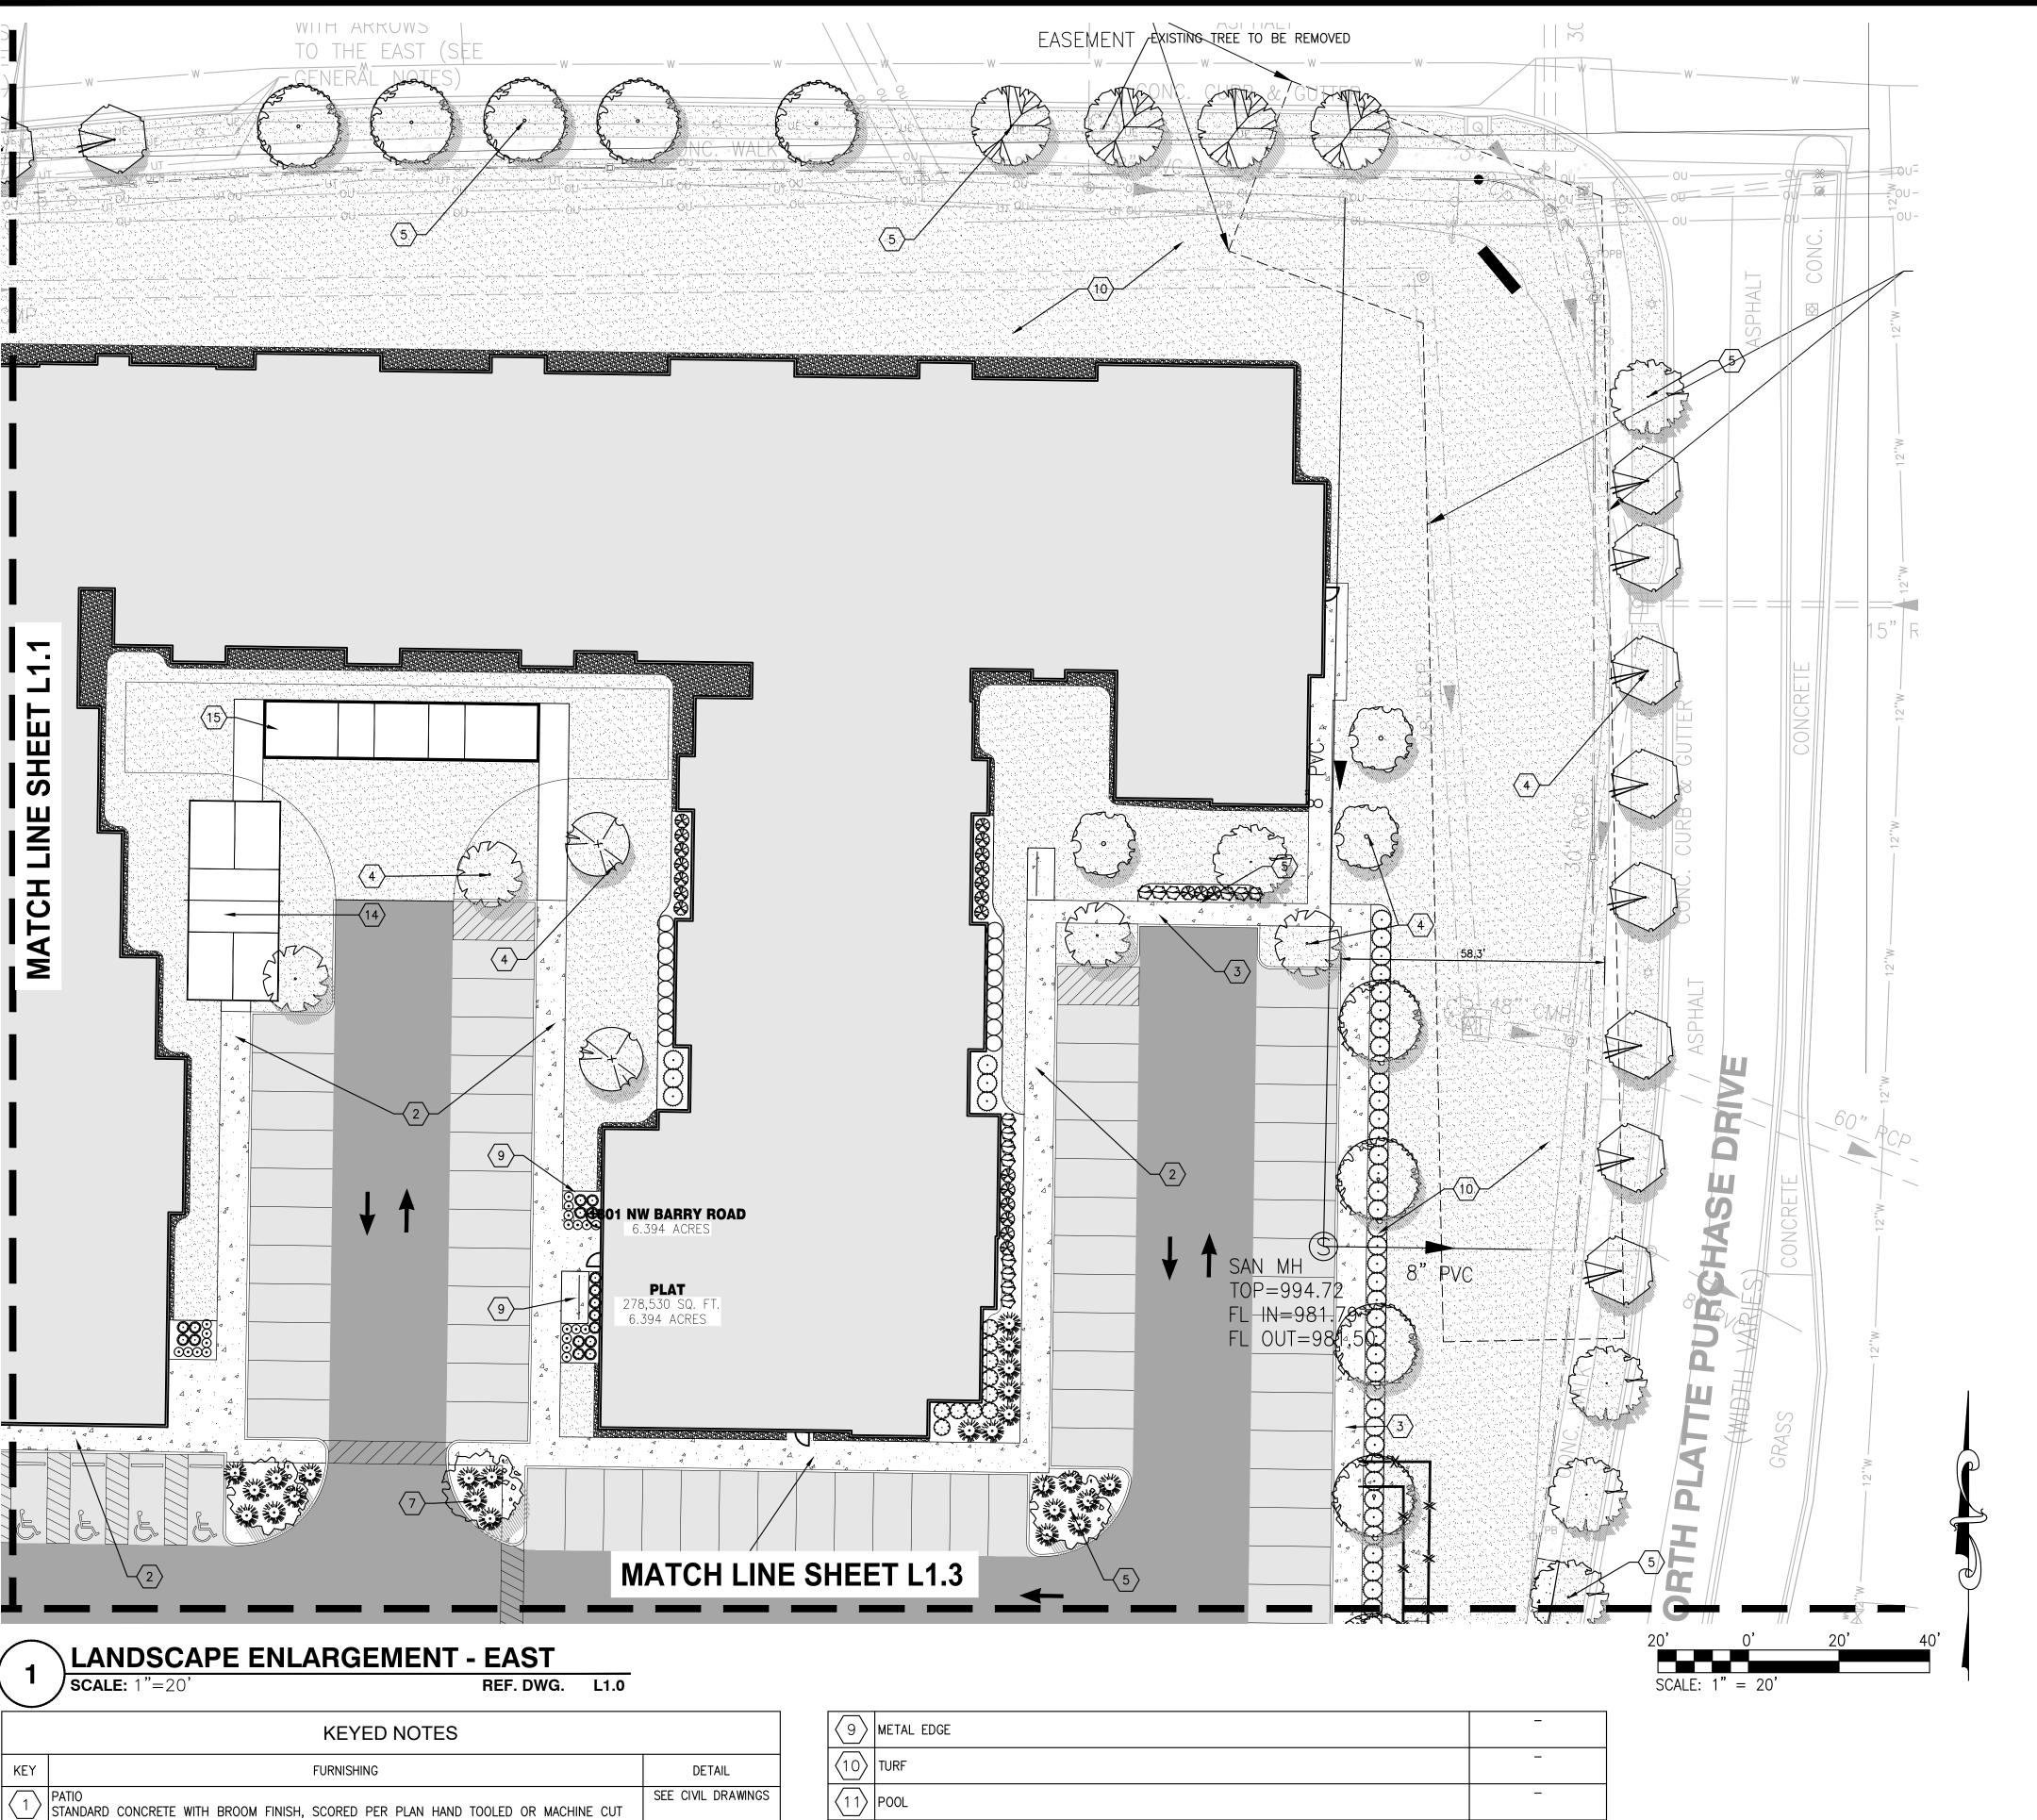* SEE SHEET L1.4 FOR	LANDSCAPE NOTES,	CALCULATIONS	AND	FUL
PLANT SCHEDULE WITH	QUANTITIES			

	DETAIL	$\langle 10 \rangle$	TURF	_
	SEE CIVIL DRAWINGS	$\langle 11 \rangle$	POOL	-
	SEE CIVIL DRAWINGS	(12)	FIRE PIT	_
	-	(13)	OUTDOOR KITCHEN	_
	-	(14)	PICKLE BALL COURT	_
	-	(15)	BOCCE BALL COURT	_
	-	(16)	DOG PARK	-
-				

CONCRETE SIDEWALK
STANDARD CONCRETE WITH BROOM FINISH, SCORED PER PLAN, HAND TOOLED OR MACHINE CUT

3 TYPICAL SHRUB PLANTING

4 TYPICAL FLOWERING/ORNAMENTAL TREE PLANTING

TYPICAL LARGE DECIDUOUS TREE PLANTING

6 > TYPICAL EVERGREEN TREE PLANTING

TYPICAL GROUND COVER PLANTING

| TYPICAL ORNAMENTAL GRAS PLANTING

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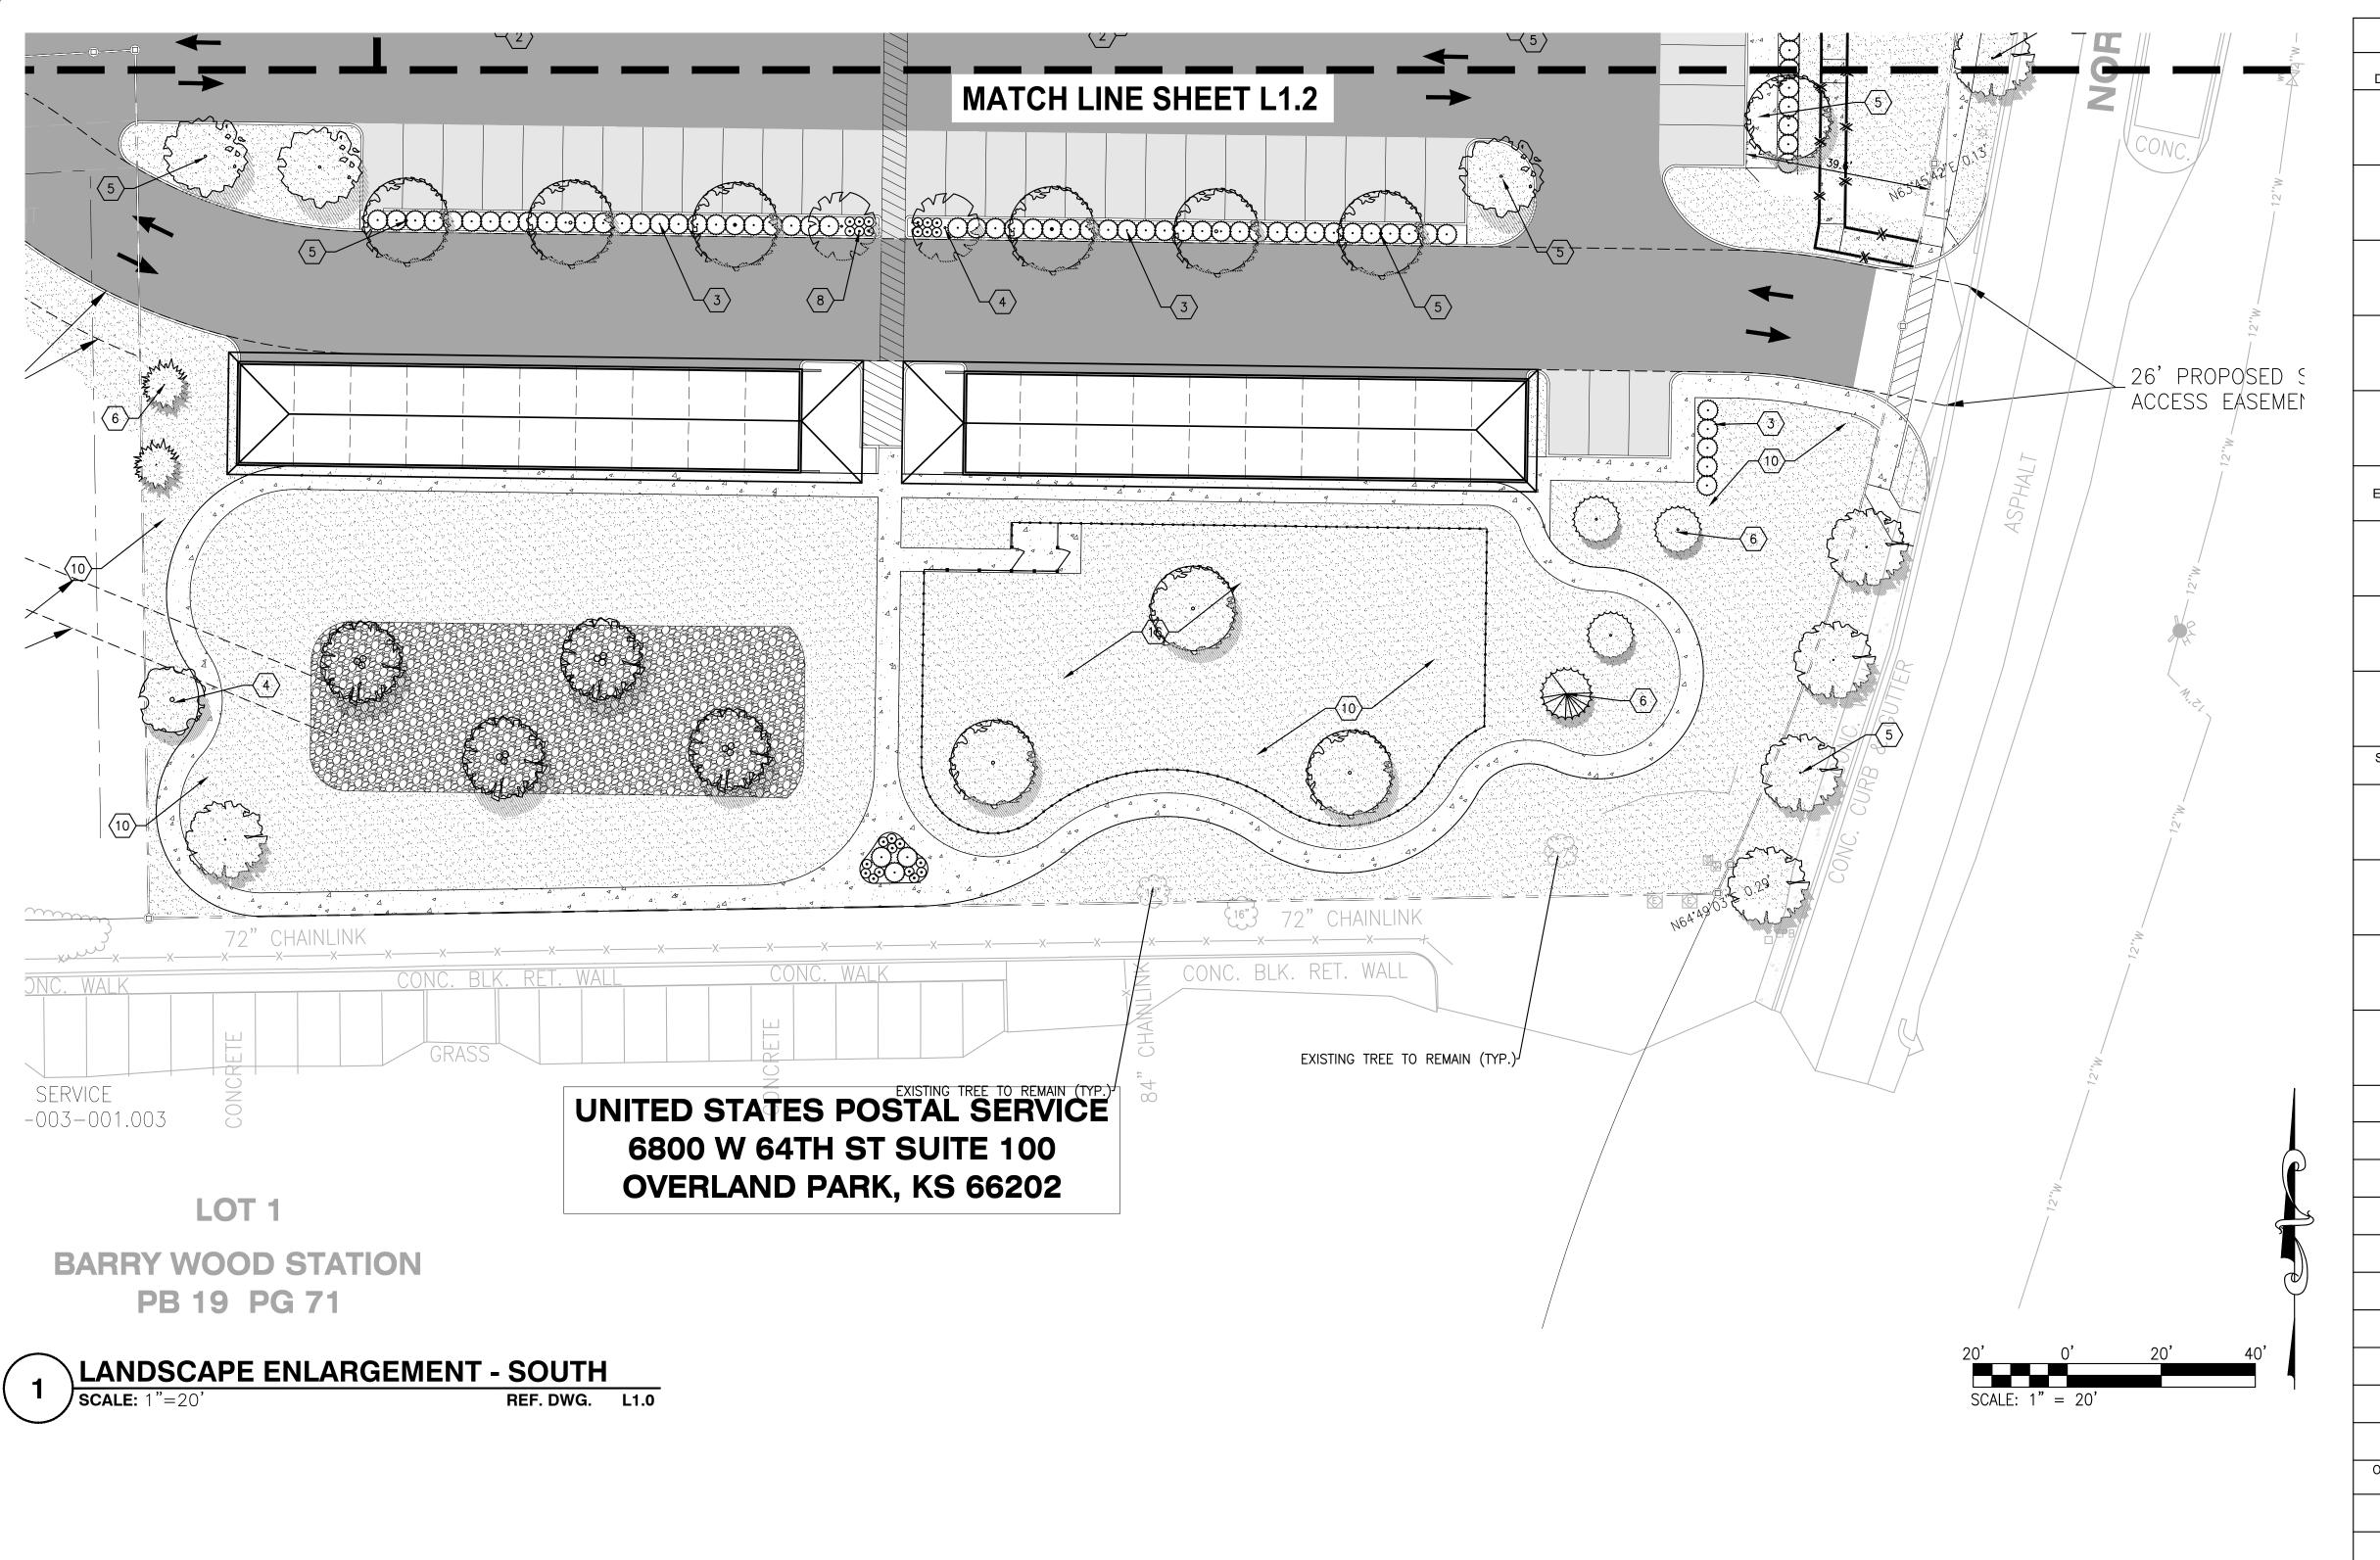
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Job Number 22-0119

8/26/2022



LARGE & MEDIUM DECIDUOUS TREES	PLANT SCHEDULE BOTANICAL NAME	COMMON NAME
DECIDOOUS TREES	Acer rubrum 'red sunset'	Rd Maple
	Quercus rubra	Red Oak
(· · · · · · · · · · · · · · · · · · ·	Zelkova serrata 'JFS-KW1'	City Sprite zelkova
	Tilia americana	American Linden
production of the second	Betula nigra 'BNMTF'	Dura Heat®River Birch
EVERGREEN TREES	BOTANICAL NAME	COMMON NAME
	Pinus echinata	Short-Leaf Pine
Many Many	Juniperus virginiana	Red Cedar
•	Thuja 'Green Giant'	Arborvitae
SMALL DECIDUOUS TREES	BOTANICAL NAME	COMMON NAME
	Cornus florida	Flowering Dogwood
	Cercis canadensis	Red Bud
	Amelanchier x grandiflora 'Autumn Brilliance'	Autumn Brilliance®Apple Serviceberry
	Carpinus caroliniana	American Hornbeam
SHRUBS	BOTANICAL NAME	COMMON NAME
0	Buxus x 'Green Velvet'	Green Velvet Boxwood
	Taxus ×media	Yew
	Physocarpus opulifolius	Tiny Wine Ninebark
\odot	Juniperus ×pfitzeriana 'Sea Green'	Chinese Juniper
	ITEA VIRGINICA 'LITTLE HENRY'	'LITTLE HENRY' SWEET SPIRI
(m)	Ceanothus americanus	New Jersey Tea
Endology Endology	Thuja occidentalis 'Smaragd'	Emerald Green Arborvitae
\odot	Rhus aromatica 'Gro-Low'	Gro-Low Fragrant Sumac
$\overline{\bigcirc}$	Spiraea japonica	Japanese spirea
ORNAMENTAL GRASS & GROUND COVER	BOTANICAL NAME	COMMON NAME
•	Schizachyrium scoparium	Little Bluestem
in the second	Sorghastrum nutans	Indiangrass
	Juniperus procumbens 'Green Mound'	Green Mound Juniper
		AREA TO BE TURF DECORATIVE GRAVEL

* SEE SHEET L1.4 FOR LANDSCAPE NOTES, CALCULATIONS AND FULL PLANT SCHEDULE WITH QUANTITIES

	KEYED NOTES	
KEY	FURNISHING	DETAIL
1	PATIO STANDARD CONCRETE WITH BROOM FINISH, SCORED PER PLAN HAND TOOLED OR MACHINE CUT	SEE CIVIL DRAWINGS
2	CONCRETE SIDEWALK STANDARD CONCRETE WITH BROOM FINISH, SCORED PER PLAN, HAND TOOLED OR MACHINE CUT	SEE CIVIL DRAWINGS
(3)	TYPICAL SHRUB PLANTING	-
4	TYPICAL FLOWERING/ORNAMENTAL TREE PLANTING	-
<u>(5)</u>	TYPICAL LARGE DECIDUOUS TREE PLANTING	_
<u>(6)</u>	TYPICAL EVERGREEN TREE PLANTING	-
7	TYPICAL GROUND COVER PLANTING	-
$\overline{\langle 8 \rangle}$	TYPICAL ORNAMENTAL GRAS PLANTING	_

9	METAL EDGE	_
(10)	TURF	_
(11) F	POOL	_
(12) F	FIRE PIT	_
(13)	OUTDOOR KITCHEN	_
(14) F	PICKLE BALL COURT	_
(15) E	BOCCE BALL COURT	_
(16)	DOG PARK	_

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LFD

DRAWN BY

MAB

CHECKED BY

KAK

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AS SHOWN

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3/26/2022

Job Number

22-0119

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LARGE & MEDIUM DECIDUOUS TREES	QTY	BOTANICAL NAME	COMMON NAME	SPACING	SIZE	COMMENTS
	24	Acer rubrum 'red sunset'	Rd Maple	As Shown	2" Cal. Min.	B&B
	7	Quercus rubra	Red Oak	As Shown	2" Cal. Min.	B&B
(· · · · · · · · · · · · · · · · · · ·	14	Zelkova serrata 'JFS—KW1'	City Sprite zelkova	As Shown	2" Cal. Min.	B&B
	14	Tilia americana	American Linden	As Shown	2" Cal. Min.	B&B
E & B	4	Betula nigra 'BNMTF'	Dura Heat®River Birch	As Shown	2" Cal. Min.	B&B
EVERGREEN TREES	QTY	BOTANICAL NAME	COMMON NAME	SPACING	SIZE	COMMENTS
	3	Pinus echinata	Short-Leaf Pine	As Shown	6'-8' HT. MIN.	B&B
Many way	2	Juniperus virginiana	Red Cedar	As Shown	6'-8' HT. MIN.	B&B
•	5	Thuja 'Green Giant'	Arborvitae	As Shown	6'-8' HT. MIN.	B&B
SMALL DECIDUOUS TREES	QTY	BOTANICAL NAME	COMMON NAME	SPACING	SIZE	COMMENTS
	2	Cornus florida	Flowering Dogwood	As Shown	1.5" Cal. Min.	B&B
	4	Cercis canadensis	Red Bud	As Shown	1.5" Cal. Min.	B&B
	15	Amelanchier x grandiflora 'Autumn Brilliance'	Autumn Brilliance® Apple Serviceberry	As Shown	1.5" Cal. Min.	B&B SINGLE STEM
	7	Carpinus caroliniana	American Hornbeam	As Shown	1.5" Cal. Min.	B&B
SHRUBS	QTY	BOTANICAL NAME	COMMON NAME	SPACING	SIZE	COMMENTS
	99	Buxus x 'Green Velvet'	Green Velvet Boxwood	As Shown	18" min.	Cont.
	49	Taxus ×media	Yew	As Shown	24" min.	Cont.
	50	Physocarpus opulifolius	Tiny Wine Ninebark	As Shown	18" min.	Cont.
$\overline{\bigcirc}$	123	Juniperus ×pfitzeriana 'Sea Green'	Chinese Juniper	As Shown	24" min.	Cont.
	40	ITEA VIRGINICA 'LITTLE HENRY'	'LITTLE HENRY' SWEET SPIRE	As Shown	24" min.	Cont.
- Constitution of the cons	33	Ceanothus americanus	New Jersey Tea	As Shown	24" min.	Cont.
Markey grand and a second	46	Thuja occidentalis 'Smaragd'	Emerald Green Arborvitae	As Shown	4' HT. min.	Cont.
The state of the s	23	Rhus aromatica 'Gro-Low'	Gro-Low Fragrant Sumac	As Shown	24" min.	Cont.
	29	Spiraea japonica	Japanese spirea	As Shown	24" min.	Cont.
ORNAMENTAL GRASS &	QTY	BOTANICAL NAME	COMMON NAME	SPACING	SIZE	COMMENTS
GROUND COVER	120	Schizachyrium scoparium	Little Bluestem	As Shown	2 gal.	Cont.
	22	Sorghastrum nutans	Indiangrass	As Shown	2 gal.	Cont.
	40	Juniperus procumbens 'Green	Green Mound Juniper	3' O.C.	2 gal.	Cont.
✓™ .~	TBD	Mound'	AREA TO BE TURF			
	TBD		DECORATIVE GRAVEL			

	LANDSCAPE AND	TREE REQUIREM	ENTS	
CODE SEC. 88-425-03-C TREE PLAN	TING REQUIREMENTS - STREET TREES			
REQUIREMENT	AREA / MEASUREMENT	REQ'D	PROV'D	APPROVED
1 STREET TREE FOR EACH 30' OF STREET FRONTAGE	NW BARRY RD. +/- 700 L.F. 700/30=23.3	24 TREES	24 TREES	
NO MORE THAN 50% ONE TREE SPECIES	N PLATTE PURCHASE RD +/- 500 L.F. 500-26LF ENTRY DRIVE= 474 474/30=15.8	16 TREES	16 TREES	
CODE SEC. 88-425-04-D TREES - GB	ENERAL LANDSCAPING REQUIREMENTS			
REQUIREMENT	AREA / MEASUREMENT	REQ'D	PROV'D	APPROVED
1 TREE PER 5,000 S.F. OF PRINCIPAL BUILDING COVERAGE	77,232.8 S.F. OF BUILDING COVERAGE 77,232.8/5,000 = 15.4	16 TREES	16 TREES	
CODE SEC.88-425-06-B - MIN. INTER	IOR LANDSCAPE AREA - INTERIOR LAND	SCAPING OF PARKING LOTS		
REQUIREMENT	AREA / MEASUREMENT	REQ'D	PROV'D	APPROVED
MIN. 35 S.F. OF INTERIOR LANDSCAPE AREA FOR EACH PARKING SPACE	210 PARKING SPACES 210X35=7,350 S.F.OF INTERIOR LANDSCAPE AREA REQUIRED	7,350 S.F.	7,416 S.F.	
CODE SEC. 88-425-06-E - PLANT MA	TERIALS - INTERIOR LANDSCAPING OF P	ARKING LOTS		
REQUIREMENT	AREA / MEASUREMENT	REQ'D	PROV'D	APPROVED
1 TREE PER 5 PARKING STALLS 1 SHRUB PER PARKING SPACE GROUND COVER PLANTS MUST COVER ALL INTERIOR LANDSCAPE AREAS	205 PARKING SPACES 205/5 = 41 TREES 205X1 = 205 SHRUBS REQUIRED	41 TREES 205 SHRUBS	41 TREES 205 SHRUBS	
CODE SEC. 88-425-05-B - ADJACENT	TO STREETS - PERIMETER LANDSCAPI	NG OF VEHICULAR USE AREA	NS .	
REQUIREMENT	AREA / MEASUREMENT	REQ'D	PROV'D	APPROVED
- 10' WIDE BUFFER STRIP - 1 TREE PER 30 LINEAR FEET OF LANDSCAPE STRIP * TREES PLANTED FOR STREET TREE PLANTING REQUIREMENTS MAY BE COUNTED - EVERGREEN SHRUBS TO FORM A VISUAL SCREEN AT LEAST 3' IN HEIGHT AFTER FIRST GROWING SEASON - GROUND COVER PLANTS MUST COVER THE REMAINDER OF THE REQUIRED LANDSCAPE STRIP.	+/- 180 L.F. OF PARKING LOT FRONTAGE 180/30 = 6 TREES & EVERGREEN SHRUB SCREEN	6 TREES EVERGREEN SHRUB SCREEN	6 TREES * INCLUDES PROPOSED STREET TREES EVERGREEN SHRUB SCREEN	

LANDSCAPE NOTES:

- 1. LANDSCAPE CONTRACTOR TO VERIFY LOCATION OF UNDERGROUND UTILITIES BEFORE BEGINNING WORK. 2. ALL LANDSCAPE SHALL COMPLY WITH THE CURRENT EDITION OF ANSI Z 60.1 "AMERICAN STANDARD FOR NURSERY STOCK.'
- 3. ALL PLANTS SHALL MEET THE REQUIREMENTS OF THE STATE AND FEDERAL LAW WITH RESPECT TO DISEASE AND INSECT INFESTATION.
- 4. MULCH AREAS WITH TRIPLE GROUND HARDWOOD MULCH 3" MIN. DEPTH. 5. ALL LANDSCAPE SUBSTITUTIONS MUST BE APPROVED BY THE OWNER'S REPRESENTATIVE/LANDSCAPE
- 6. FORMAL LINES AND GROUPINGS OF A SPECIES OF TREE, SHRUB, OR GROUNDCOVER SHALL BE MATCHED FOR SIZE, FORM, AND COLOR. 7. ALL BACKFILL IN PLANTING BEDS AND TREE PITS SHALL BE BACKFILLED WITH PLANTING SOIL AS CALLED
- OUT IN THE SPECIFICATIONS. 8. ALL TREES OUTSIDE OF PLANT BEDS SHALL BE PLANTED WITH A MULCH RING. OBTAIN APPROVAL FROM OWNER'S REPRESENTATIVE/LANDSCAPE ARCHITECT FOR ANY TREES THAT WILL NOT BE MULCHED FOR
- EXCESSIVE MOISTURE REASONS. 9. ALL LANDSCAPING SHALL BE INSTALLED AS SHOWN ON THE APPROVED PLAN.
- 10. AT PLANTING, TREE TRUNKS MUST BE STRAIGHT WITH MINIMAL DOGLEGS. 11. WIRE BASKETS, BURLAP WRAPPINGS, ROPE, TWINE OR ANY SIMILAR SHIPPING MATERIALS SHALL BE REMOVED BEFORE PLANTING.
- 12. A SPADE CUT EDGE SHALL BE CREATED AT ALL LOCATIONS WHERE PLANTING BEDS ARE ADJACENT TO
- GRASS AREAS UNLESS OTHERWISE NOTED. 13. SEE CIVIL PLANS FOR TYPE AND LOCATION OF EROSION CONTROL MATERIALS.
- 14. DO NOT DISTURB EXISTING UTILITIES WITHIN WORK AREA. SILT FENCE AND PLANTINGS SHALL AVOID ANY EXISTING UTILITIES.
- 15. THE CONTRACTOR SHALL FOLLOW THE LANDSCAPE PLANS. ANY SUBSTITUTION OR ALTERATION SHALL NOT BE ALLOWED WITHOUT APPROVAL OF THE OWNER'S REPRESENTATIVE/LANDSCAPE ARCHITECT. OVERALL PLANT QUANTITY AND QUALITY SHALL BE CONSISTENT WITH THE PLANS.
- 16. THE CONTRACTOR IS RESPONSIBLE FOR VERIFYING ALL PLANT QUANTITIES. WRITTEN QUANTITIES TAKES PRECEDENCE OVER GRAPHIC QUANTITIES. NOTIFY OWNER'S REPRESENTATIVE/LANDSCAPE ARCHITECT OF DISCREPANCIES.
- 17. THE OWNER'S REPRESENTATIVE/LANDSCAPE ARCHITECT RESERVES THE RIGHT TO INSPECT AND TAG ALL PLANT MATERIAL PRIOR TO SHIPPING TO THE SITE. IN ALL CASES, THE LANDSCAPE ARCHITECT MAY REJECT PLANT MATERIAL AT THE SITE IF MATERIAL IS DAMAGED, DISEASED, OR DECLINING IN HEALTH AT THE TIME OF ONSITE INSPECTIONS OR IF THE PLANT MATERIAL DOES NOT MEET THE MINIMUM SPECIFIED STANDARD IDENTIFIED ON THE PLANS AND IN THE SPECIFICATIONS. THE CONTRACTOR SHALL COORDINATE WITH THE OWNER'S REPRESENTATIVE/LANDSCAPE ARCHITECT FOR INSPECTION AND APPROVAL OF ALL MATERIALS AND PRODUCTS PRIOR TO INSTALLATION.
- 18. THE OWNER'S REPRESENTATIVE/LANDSCAPE ARCHITECT MAY ELECT TO UPSIZE PLANT MATERIAL AT THEIR DISCRETION BASED ON SELECTION, AVAILABILITY, OR TO ENHANCE SPECIFIC AREAS OF THE PROJECT. THE CONTRACTOR SHALL VERIFY PLANT MATERIAL SIZES WITH OWNER'S REPRESENTATIVE/LANDSCAPE ARCHITECT PRIOR TO PURCHASING, SHIPPING OR STOCKING OF PLANT MATERIALS. SUBMIT CHANGE ORDER REQUEST TO CONTRACTOR PRIOR TO INSTALLATION. RE-STOCKING CHARGES WILL NOT BE APPROVED IF THE CONTRACTOR FAILS TO SUBMIT A REQUEST FOR MATERIAL CHANGES.
- AFTER SUBSTANTIAL COMPLETION HAS BEEN ISSUED BY THE OWNER'S REPRESENTATIVE/LANDSCAPE ARCHITECT FOR THE ENTIRE PROJECT UNLESS OTHERWISE SPECIFIED IN THE CONTRACT DOCUMENTS OR SPECIFICATIONS.
- 20. THE DEVELOPER, HIS SUCCESSORS AND ASSIGNS SHALL BE RESPONSIBLE FOR THE INSTALLATION, MAINTENANCE AND REPLACEMENT OF ALL LANDSCAPING MATERIALS SHOWN OR INDICATED ON THE APPROVED LANDSCAPE PLAN ON FILE WITH THE PLANNING DEPARTMENT. ALL LANDSCAPING WILL BE INSTALLED AS DELINEATED ON THE PLAN, PRIOR TO ISSUANCE OF CERTIFICATE OF OCCUPANCY.
- 21. PRIOR TO INSTALLATION OF PLANT MATERIALS, AREAS THAT HAVE BEEN COMPACTED OR DISTURBED BY CONSTRUCTION ACTIVITY SHALL BE THOROUGHLY LOOSENED TO A DEPTH OF 8" - 12" AND AMENDED PER
- YDS. OF ORGANIC MATTER PER 1000 S.F.). TREES SHALL NOT BE LOCATED IN DRAINAGE SWALES, DRAINAGE AREAS, OR UTILITY EASEMENTS. CONTACT OWNER'S REPRESENTATIVE/LANDSCAPE ARCHITECT FOR RELOCATION OF PLANTS IN QUESTIONABLE AREAS PRIOR TO INSTALLATION.
- 23. ALL EVERGREEN TREES SHALL BE FULLY BRANCHED TO THE GROUND AND SHALL NOT EXHIBIT SIGNS OF

- ACCELERATED GROWTH AS DETERMINED BY THE OWNER'S REPRESENTATIVE/LANDSCAPE ARCHITECT.
- 24. ALL TREES ARE TO BE STAKED AND GUYED PER DETAILS FOR A PERIOD OF 1 YEAR. THE CONTRACTOR SHALL BE RESPONSIBLE FOR REMOVING STAKES AT THE END OF 1 YEAR FROM ACCEPTANCE OF LANDSCAPE INSTALLATION BY THE OWNER'S REPRESENTATIVE/LANDSCAPE ARCHITECT. OBTAIN APPROVAL BY OWNER'S REPRESENTATIVE PRIOR TO REMOVAL.
- 25. ALL TREES INSTALLED ABOVE RETAINING WALLS UTILIZING GEO-GRID MUST BE HAND DUG TO PROTECT GEO-GRID. IF GEO-GRID MUST BE CUT TO INSTALL TREES, APPROVAL MUST BE GIVEN BY OWNER'S REPRESENTATIVE/LANDSCAPE ARCHITECT PRIOR TO DOING WORK.
- 26. PLACE PLANT MATERIAL IN SHRUB BED SO THAT ONCE PLANTS GROW TO FULL SIZE THEY ARE FULLY
- CONTAINED WITHIN THE SHRUB BED AREA AND DO NOT HANG OVER THE EDGER LINE. 27. REFER TO IRRIGATION PLANS FOR LIMITS AND TYPES OF IRRIGATION DESIGNED FOR THE LANDSCAPE. IN NO CASE SHALL IRRIGATION BE EMITTED WITHIN THE MINIMUM DISTANCE FROM BUILDING OR WALL FOUNDATIONS AS STIPULATED IN THE GEOTECHNICAL REPORT. ALL IRRIGATION DISTRIBUTION LINES, HEADS AND EMITTERS SHALL BE KEPT OUTSIDE THE MINIMUM DISTANCE AWAY FROM ALL BUILDING AND WALL FOUNDATIONS AS STIPULATED IN THE GEOTECHNICAL REPORT.
- 28. LANDSCAPE AREAS SHALL BE IRRIGATED WITH AN AUTOMATIC UNDERGROUND IRRIGATION SYSTEM WITH INDIVIDUAL ZONES FOR TURF AND NON-TURF AREAS, AND MUST INCLUDE A MOISTURE DETECTION DEVICE TO PREVENT OPERATION DURING RAINY PERIODS. TURF AREAS SHALL BE IRRIGATED WITH AN AUTOMATIC POP-UP IRRIGATION SYSTEM. SHRUB AND PERENNIAL BEDS SHALL HAVE DRIP IRRIGATION.
- 29. LANDSCAPE MATERIAL LOCATIONS SHALL HAVE PRECEDENCE OVER IRRIGATION MAINLINE AND LATERAL LOCATIONS. COORDINATE INSTALLATION OF IRRIGATION EQUIPMENT SO THAT IT DOES NOT INTERFERE WITH THE PLANTING OF TREES OR OTHER LANDSCAPE MATERIAL.
- 30. THE LANDSCAPE CONTRACTOR SHALL BE RESPONSIBLE FOR ENSURING POSITIVE DRAINAGE EXISTS IN ALL LANDSCAPE AREAS. SURFACE DRAINAGE ON LANDSCAPE AREAS SHALL NOT FLOW TOWARD STRUCTURES AND FOUNDATIONS. MAINTAIN SLOPE AWAY FROM FOUNDATIONS PER THE GEOTECHNICAL REPORT RECOMMENDATIONS, ALL LANDSCAPE AREAS BETWEEN WALKS AND CURBS SHALL DRAIN FREELY TO THE CURB UNLESS OTHERWISE IDENTIFIED ON THE GRADING PLAN. IN NO CASE SHALL THE GRADE, TURF THATCH, OR OTHER LANDSCAPE MATERIALS DAM WATER AGAINST WALKS. MINIMUM SLOPES ON LANDSCAPE AREAS SHALL BE 2%; MAXIMUM SLOPE SHALL BE 25% UNLESS SPECIFICALLY IDENTIFIED ON THE PLANS OR APPROVED BY THE OWNER'S REPRESENTATIVE/LANDSCAPE ARCHITECT.
- 31. SHRUB, GROUNDCOVER AND PERENNIAL BEDS ARE TO BE CONTAINED BY A SPADE CUT EDGE. EDGER IS NOT REQUIRED WHEN ADJACENT TO CURBS, WALLS, WALKS OR SOLID FENCES WITHIN 3"OF PRE-MULCHED FINAL GRADE. EDGER SHALL NOT BE REQUIRED TO SEPARATE MULCH TYPES UNLESS SPECIFIED ON THE
- 32. ALL SHRUB BEDS ARE TO BE MULCHED WITH MIN. 3" DEPTH, SHREDDED HARDWOOD BARK MULCH.
- 33. AT SEED AREA BOUNDARIES ADJACENT TO EXISTING NATIVE AREAS, OVERLAP ABUTTING NATIVE AREAS BY THE FULL WIDTH OF THE SEEDER. 34. EXISTING TURF AREAS THAT ARE DISTURBED DURING CONSTRUCTION, ESTABLISHMENT AND THE MAINTENANCE
- PERIOD SHALL BE RESTORED WITH NEW SOD TO MATCH EXISTING TURF SPECIES. DISTURBED NATIVE AREAS WHICH ARE TO REMAIN SHALL BE OVER SEEDED AND RESTORED WITH SPECIFIED SEED MIX. 35. CONTRACTOR SHALL OVER SEED ALL MAINTENANCE OR SERVICE ACCESS BENCHES AND ROADS WITH SPECIFIED SEED MIX UNLESS OTHERWISE NOTED ON THE PLANS.
- OWNER'S REPRESENTATIVE/LANDSCAPE ARCHITECT FOR APPROVAL IF ADDITIONAL COST IS REQUESTED BY THE 36. ALL SEEDED SLOPES EXCEEDING 25% IN GRADE (4:1) SHALL RECEIVE EROSION CONTROL BLANKETS. PRIOR TO INSTALLATION, NOTIFY OWNER'S REPRESENTATIVE FOR APPROVAL OF LOCATION AND ANY ADDITIONAL COST IF A CHANGE ORDER IS NECESSARY.
- 19. THE CONTRACTOR SHALL WARRANTY ALL CONTRACTED WORK AND MATERIALS FOR A PERIOD OF ONE YEAR 37. WHEN COMPLETE, ALL GRADES SHALL BE WITHIN +/- 1/8" OF FINISHED GRADES AS SHOWN ON THE PLANS.THESE PLANS ARE NOT INTENDED FOR CONSTRUCTION OR PERMITTING UNLESS STATED IN THE TITLE
 - 38. DRAWINGS ARE INTENDED TO BE PRINTED ON 24" X 36" PAPER. PRINTING THESE DRAWINGS AT A DIFFERENT SIZE WILL IMPACT THE SCALE. VERIFY THE GRAPHIC SCALE BEFORE REFERENCING ANY MEASUREMENTS ON THESE SHEETS. THE RECIPIENT OF THESE DRAWINGS SHALL BE RESPONSIBLE FOR ANY ERRORS RESULTING FROM INCORRECT PRINTING, COPYING, OR ANY OTHER CHANGES THAT ALTER THE SCALE OF THE DRAWINGS.
 - 39. VERIFY ALL PLAN DIMENSIONS PRIOR TO START OF CONSTRUCTION. NOTIFY THE OWNER'S REPRESENTATIVE
 - TO ADDRESS ANY QUESTIONS OR CLARIFY ANY DISCREPANCIES. 40. WRITTEN DIMENSIONS TAKE PRECEDENCE OVER SCALED DIMENSIONS.
- 22. ALL LANDSCAPED AREAS ARE TO HAVE SOIL PREPARATION PER SPECIFICATIONS. (MINIMUM RATE OF 3 CU. 41. SUBMIT A CHANGE ORDER FOR APPROVAL FOR ANY CHANGES TO WORK SCOPE RESULTING FROM FIELD CONDITIONS OR DIRECTION BY OWNER'S REPRESENTATIVE WHICH REQUIRE ADDITIONAL COST TO THE OWNER PRIOR TO PERFORMANCE OF WORK.
 - 42. THE CONTRACTOR SHALL PROVIDE A STAKED LAYOUT OF ALL SITE IMPROVEMENTS FOR INSPECTION BY THE OWNER'S REPRESENTATIVE AND MAKE MODIFICATIONS AS REQUIRED.

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DATE: 09/30/2022


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CHECKED BY DRAWING SCALE AS SHOWN

8/26/2022

22-0119 Sheet Number

Job Number

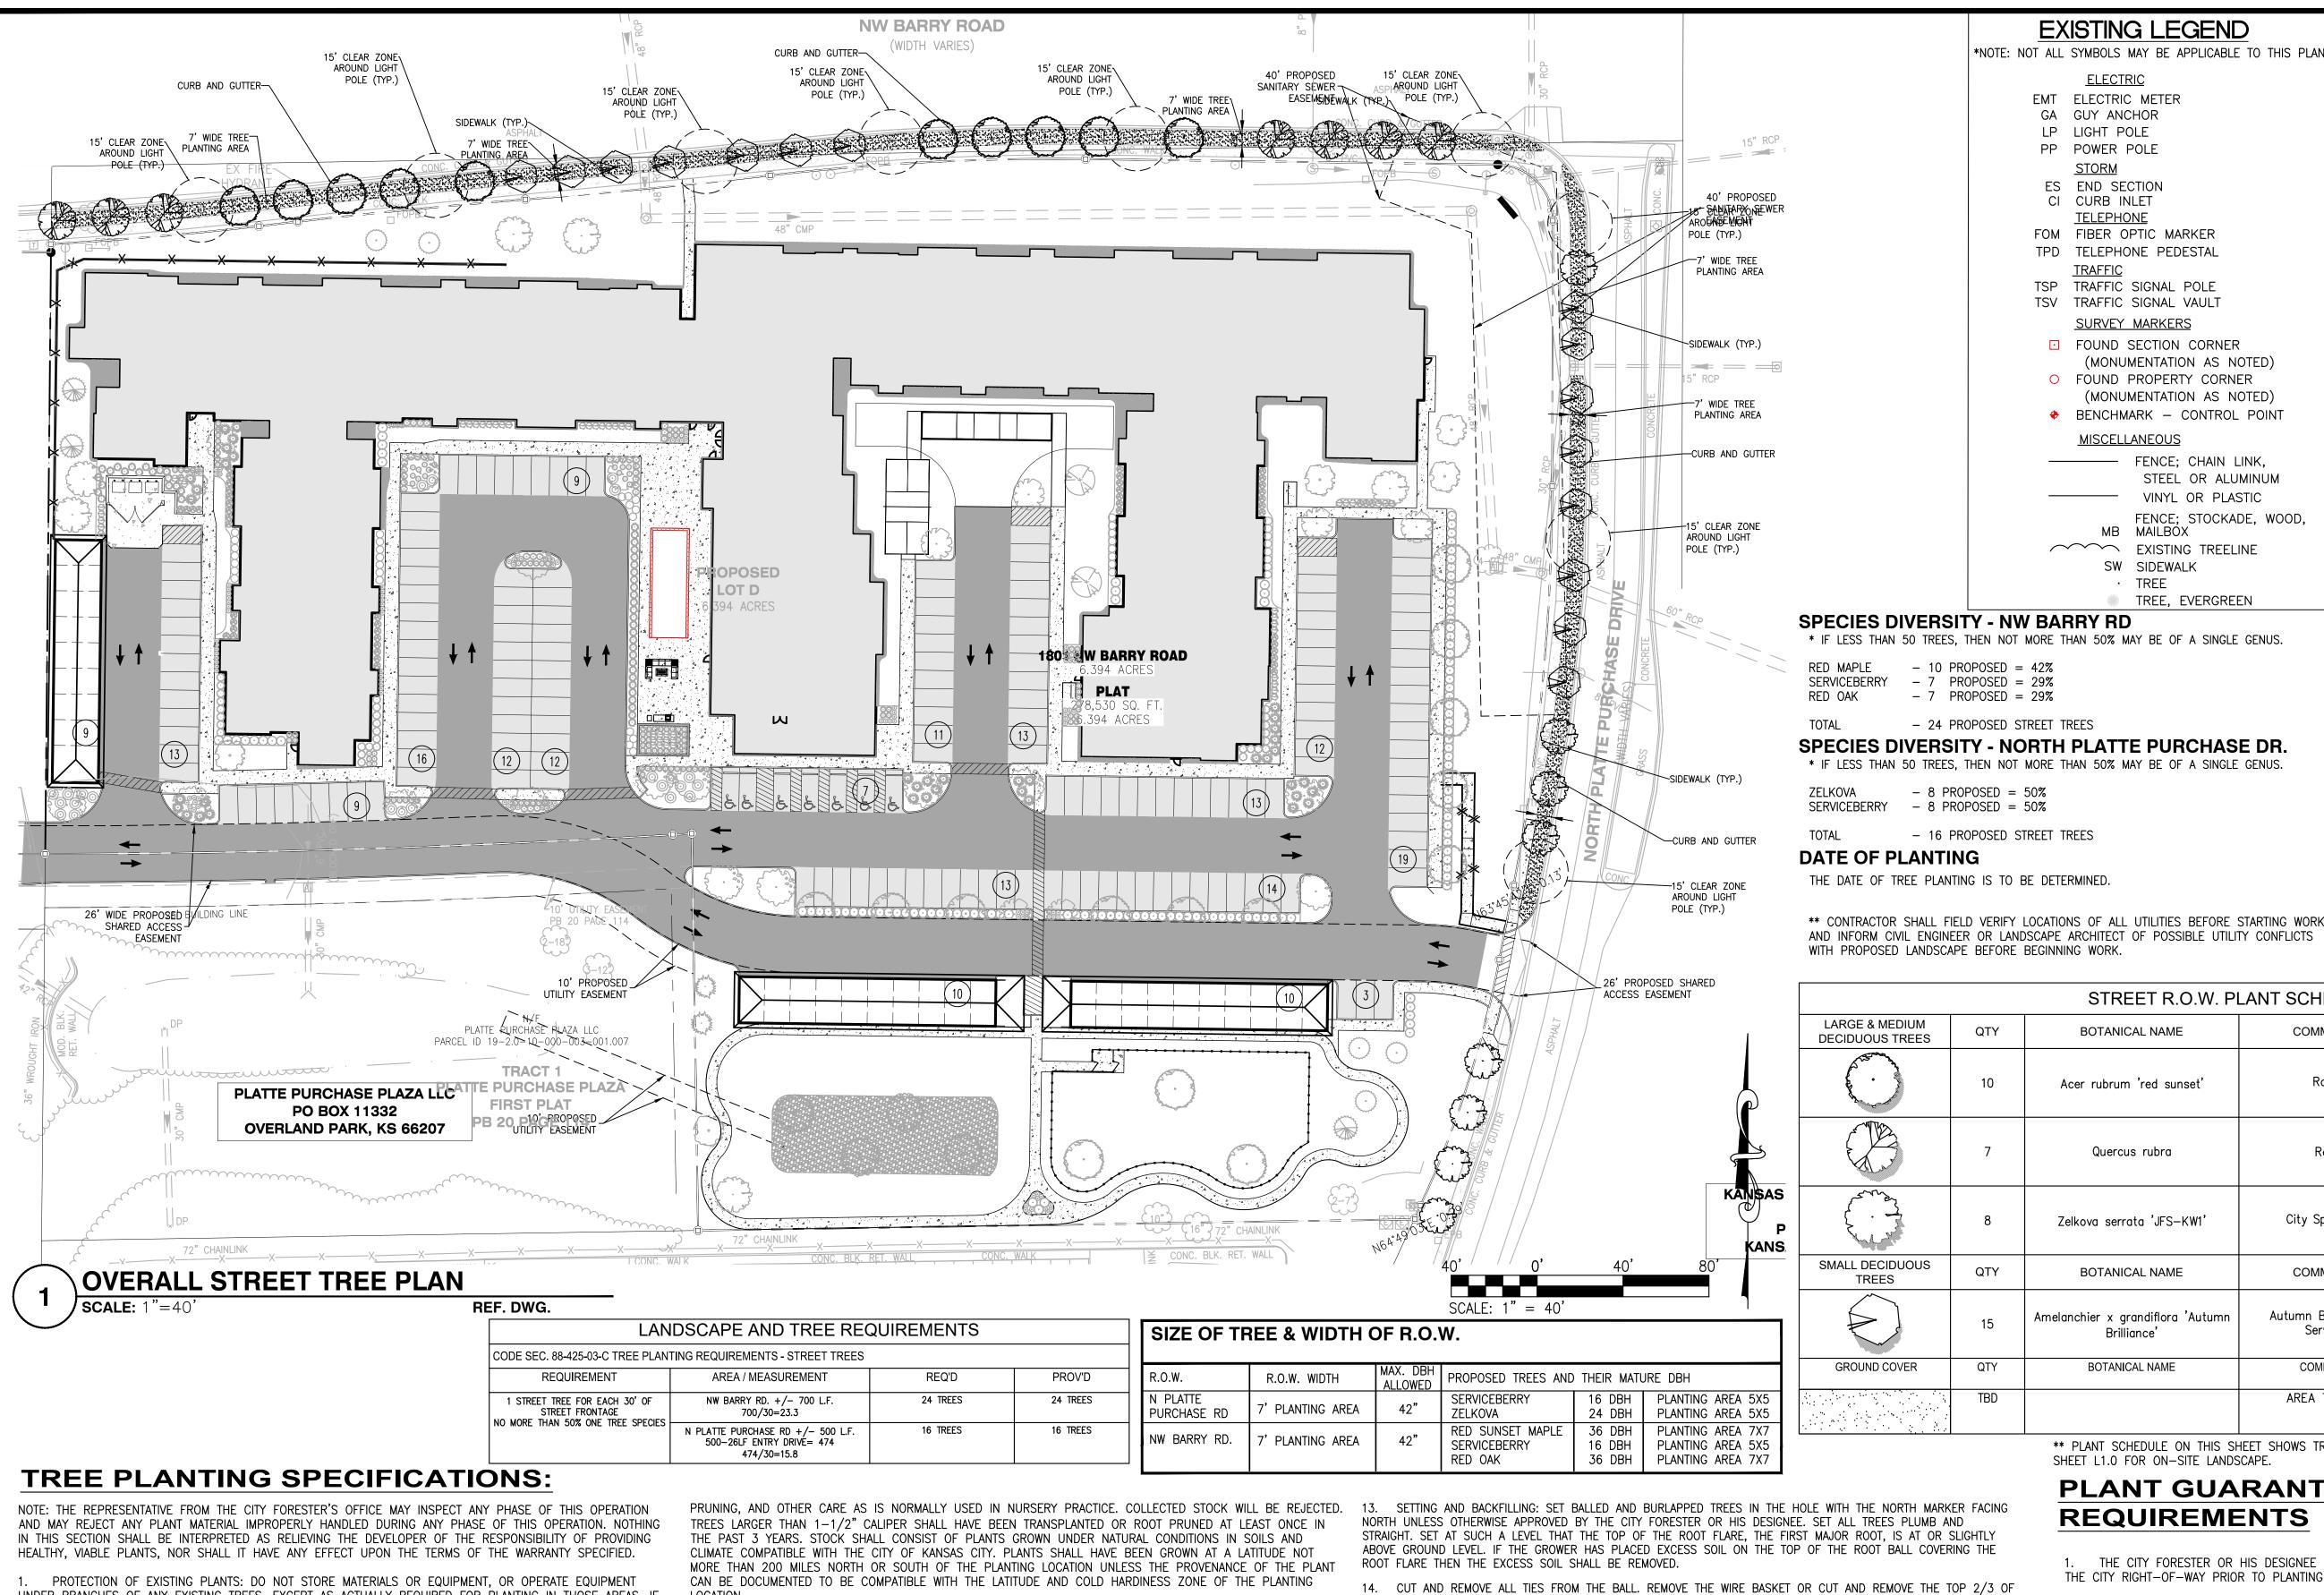

THEIR MATUR	RE DBH		GROUND COVER	QTY	BOTANICAL NAME	COMMON NAME	SPACING	SIZE
16 DBH 24 DBH	PLANTING AREA 5X5 PLANTING AREA 5X5			TBD		AREA TO BE TURF		
36 DBH 16 DBH 36 DBH	PLANTING AREA 7X7 PLANTING AREA 5X5 PLANTING AREA 7X7		[MTATES TARTE g _{1.1} day]		** PLANT SCHEDULE ON THIS SE SHEET L1.0 FOR ON-SITE LANDS	L HEET SHOWS TREES WITHIN THE RIC SCAPE.	<u> </u> GHT-OF-WAY ON	L LY. SEE
		•			PLANT GUA	RANTEE & M	AINTE	NAN
BY THE CITY F	FORESTER OR HIS DESIG	NE	HOLE WITH THE NORTH MARKI E. SET ALL TREES PLUMB AN ST MAJOR ROOT, IS AT OR S	ND	REQUIREME	ENTS		
THE TOP OF	THE NOOT LEANE, THE	ш,	SI WIMOUN NOOT, IS AT ON S	JLIGITILI				

UNDER BRANCHES OF ANY EXISTING TREES, EXCEPT AS ACTUALLY REQUIRED FOR PLANTING IN THOSE AREAS. IF LOCATION. EXISTING PLANTS ARE DAMAGED DURING PLANTING, DEVELOPER SHALL REPLACE SUCH PLANTS WITH THE SAME SPECIES AND SIZE AS THOSE DAMAGED AT NO COST TO PARKS AND RECREATION. DETERMINATION OF THE EXTENT OF DAMAGE AND VALUE OF DAMAGED PLANT SHALL REST SOLELY WITH THE REPRESENTATIVE OF THE CITY FORESTER. (SEE FIGURE 5 FOR TREE PROTECTION GUIDELINES).

2. ALL BROADLEAF TREES SHALL BE 2" MINIMUM CALIPER AND EVERGREEN TREES MUST HAVE A MINIMUM PLANTED HEIGHT OF FIVE (5) FEET, SMALLER SIZES REQUIRE PRIOR APPROVAL FROM THE CITY FORESTER.

3. ALL PLANTS SHALL BE SYMMETRICAL IN GROWTH WITH BALANCED ROOT AND TOP GROWTH AND SHALL BE NO. 1 IN GRADE OR TYPE, CONFORMING TO THE LATEST EDITION OF "AMERICAN STANDARD OF NURSERY STOCK", ANSI Z60.1 (2014) REFERENCED HEREIN. TREES SHALL HAVE A SINGLE STRAIGHT TRUNK, SINGLE DOMINANT CENTRAL LEADER (WHEN CHARACTERISTIC OF THE SPECIES), AND A WELL-BALANCED BRANCH STRUCTURE.

4. DURING TRANSPORTATION OF PLANT MATERIAL. CARE WILL BE TAKEN TO PREVENT INJURY OR DRYING OUT OF THE TREES. TREES WILL BE REJECTED IF THE ROOTS ARE DRIED OUT OR IF THE TREE HAS BEEN DAMAGED DURING TRANSIT. PLANTS MUST BE PROTECTED AT ALL TIMES FROM SUN OR DRYING WINDS. PLANTS SHALL BE LIFTED AND HANDLED WITH SUITABLE SUPPORT OF THE SOIL BALL TO AVOID DAMAGE TO THE TRUNK OF THE

5. PLANT MATERIAL SPECIFIED AS BALLED AND BURLAPPED (B&B) MUST HAVE A BALL OF FIRM EARTH FROM THE ORIGINAL SOIL IN WHICH THE PLANT GREW. THE BALL SHALL BE WRAPPED WITH NON-SYNTHETIC, ROTTABLE BURLAP AND TIGHTLY TIED WITH NON-SYNTHETIC, ROTTABLE TWINE TO HOLD IT FIRM AND INTACT. ANY PLANTS WITH LOOSE OR BROKEN BALLS OR MANUFACTURED BALLS WILL BE REJECTED. WIRE BASKETS SHALL BE USED WHERE NECESSARY TO PROTECT THE BALLS.

PLANTS SHALL BE NURSERY GROWN AND SHALL HAVE RECEIVED THE PROPER FERTILIZING, WATERING, ROOT

PLANTS SHALL BE FREE FROM DEFECTS, DISEASE, INSECTS, EGGS OR LARVAE AND INJURIES OR OTHER CONDITIONS THAT WOULD PREVENT VIGOROUS GROWTH. THE CITY RESERVES THE RIGHT TO REJECT ANY AND ALL PLANTS THAT IN ITS OPINION ARE POOR IN QUALITY, HEALTH, AND/OR FORM. ALL FIELD GROWN TREES SHALL BE MARKED TO INDICATE THE TREE'S NORTH ORIENTATION IN THE NURSERY. ALL SHIPMENTS OF PLANT STOCK SHALL COMPLY WITH EXISTING STATE AND FEDERAL LAWS AND REGULATIONS GOVERNING PLANT DISEASE AND INFECTION, AND INTERSTATE MOVEMENT OF NURSERY STOCK.

FERTILIZER: FERTILIZE TREES AFTER PLANTING WITH A "PLANT STARTER/ROOT STIMULATOR" LIQUID SOLUTION APPLIED ACCORDING TO THE MANUFACTURER'S INSTRUCTIONS.

MULCH: WOOD MULCH SHALL CONSIST OF BAGGED OR BULK AGED WOOD CHIPS, OR SHREDDED HARDWOOD BARK. WALNUT BARK OR CHIPS ARE NOT ACCEPTABLE.

TREE GUARDS: EACH TREE SHALL BE PROTECTED AFTER PLANTING WITH A PLASTIC PROTECTOR, 9" NOMINAL HEIGHT, 4" MINIMUM DIAMETER. MATERIAL SHALL BE VENTED POLYETHYLENE OR EQUIVALENT LIGHT IN COLOR NOT BLACK.

11. EXCAVATION FOR PLANTING: PLANTING HOLES SHALL BE A MINIMUM OF 10" LARGER IN DIAMETER THAN THE SPREAD OF ROOTS OR SIZE OF ROOT BALL. THE BOTTOM OF THE HOLE SHALL BE NO DEEPER THAN THE HEIGHT OF THE ROOT BALL SO THAT THE TREE BALL IS PLACED ON SOLID EARTH. PLANTING HOLES SHALL HAVE APPROXIMATELY 45 DEGREE VERTICAL SIDES AND FLAT BOTTOMS. ALL UNDERGROUND UTILITY LOCATIONS ARE TO BE LOCATED IN THE PLANTING AREAS. MISSOURI LAW REQUIRES THAT A LOCATE REQUEST BE PLACED BEFORE BEGINNING ANY EXCAVATION. WHERE TURFED AREAS ARE DAMAGED BY PLANTING OPERATIONS, THEY SHALL BE RESTORED AND REPLACED WITH EQUAL QUALITY TURF.

ABOVE GROUND LEVEL. IF THE GROWER HAS PLACED EXCESS SOIL ON THE TOP OF THE ROOT BALL COVERING THE

THE BASKET. CUT AND REMOVE THE TOP 2/3 OF THE BURLAP. DO NOT TURN UNDER AND BURY PORTIONS OF BURLAP AT TOP OF BALL. IN NO CASE SHOULD THE BURLAP BE PULLED OUT FROM UNDER THE BALLS. DO NOT PLANT TREES WHOSE BALLS HAVE BEEN BROKEN DURING THE PLANTING PROCESS. PLANTS GROWN IN CONTAINERS SHALL BE OF APPROPRIATE SIZE FOR THE CONTAINER AS SPECIFIED IN THE

LATEST EDITION OF "AMERICAN STANDARD OF NURSERY STOCK", ANSI Z60.1 (2014) REFERENCED HEREIN AND SHALL BE FREE OF CIRCLING ROOTS ON THE EXTERIOR AND INTERIOR OF THE ROOT BALL

SOIL USED FOR BACKFILLING ALL PLANTS SHALL CONSIST OF THE SOIL EXCAVATED AT THE TIME OF PLANTING. BACKFILL EACH HOLE ABOUT 2/3. FLOOD THE PLANT WITH WATER AND ALLOW SOIL TO SETTLE. ROOT STIMULATOR SHALL BE APPLIED AT THE TIME OF WATERING. BACKFILL THE REMAINING 1/3 OF THE HOLE NOT EXCEEDING THE ROOT COLLAR OR THE TOP OF THE ROOT BALL. ALL EXCESS EXCAVATED SOIL SHALL BE REMOVED FROM THE PLANTING SITE.

17. IN AREAS WHERE COMPACTED SOIL EXISTS LOOSEN SOIL BEYOND THE PLANTING HOLE APPROXIMATELY 3 FEET IN DIAMETER FROM THE BASE OF THE TREE.

18. APPLICATION OF MULCH: PLACE 2 TO 4 INCHES OF MULCH AROUND ALL TREES TO COVER AN AREA APPROXIMATELY 3 FEET IN DIAMETER. DO NOT MOUND MULCH AGAINST THE TREE TRUNK.

19. FINAL OPERATIONS: REMOVE ALL REMAINING TAGS, TIES, TREE WRAP AND TRANSIT PROTECTORS FROM TREES. INSTALL TREE GUARD AS SPECIFIED. STAKES AND GUYS ARE NOT REQUIRED BUT MAY BE NEEDED WHERE TREES ARE LOCATED IN EXTREMELY WINDY CONDITIONS OR REQUIRED BY THE CITY FORESTER OR HIS DESIGNEE. IN NO CASE SHALL TREES THAT HAVE SETTLED OUT OF PLUMB BE PULLED UPRIGHT USING GUY WIRES. STAKING AND GUYING METHOD SHOULD BE APPROVED BY THE CITY FORESTER BEFORE INSTALLING.

20. REMOVE ALL EXCESS AND WASTE MATERIALS FROM THE SITE PROMPTLY. EXISTING TURF OR ANY OTHER CONDITIONS DAMAGED DURING PLANTING SHALL BE REPAIRED. WHEN COMPLETED. THE AREA SHALL BE NEAT AND

GUARANTEE & MAINTENANCE

- 1. THE CITY FORESTER OR HIS DESIGNEE SHALL HAVE THE RIGHT TO INSPECT ALL TREES PLANTED IN THE CITY RIGHT-OF-WAY PRIOR TO PLANTING.
- REJECTED TREES SHALL BE PROMPTLY REMOVED AND REPLACED.

STREET R.O.W. PLANT SCHEDULE ONLY

COMMON NAME

Rd Maple

Red Oak

City Sprite zelkova

COMMON NAME

Autumn Brilliance®Apple

Serviceberry

EXISTING LEGEND

EMT ELECTRIC METER

GA GUY ANCHOR

PP POWER POLE

<u>STORM</u> ES END SECTION

CI CURB INLET

<u>TELEPHONE</u>

FOM FIBER OPTIC MARKER

TPD TELEPHONE PEDESTAL

TSP TRAFFIC SIGNAL POLE TSV TRAFFIC SIGNAL VAULT

SURVEY MARKERS

MISCELLANEOUS

FOUND SECTION CORNER

FOUND PROPERTY CORNER

MB MAILBOX

EXISTING TREELINE

SW SIDEWALK

TREE

BOTANICAL NAME

Acer rubrum 'red sunset'

Quercus rubra

Zelkova serrata 'JFS-KW1'

BOTANICAL NAME

Amelanchier x grandiflora 'Autumr

Brilliance'

- 10 PROPOSED = 42%

-7 PROPOSED = 29%

-7 PROPOSED = 29%

- 8 PROPOSED = 50%

- 8 PROPOSED = 50%

- 24 PROPOSED STREET TREES

16 PROPOSED STREET TREES

QTY

10

QTY

(MONUMENTATION AS NOTED)

(MONUMENTATION AS NOTED)

— FENCE; CHAIN LINK,

TREE, EVERGREEN

STEEL OR ALUMINUM

FENCE: STOCKADE, WOOD,

VINYL OR PLASTIC

BENCHMARK - CONTROL POINT

LP LIGHT POLE

*NOTE: NOT ALL SYMBOLS MAY BE APPLICABLE TO THIS PLAN

PROPOSED LEGEND

*NOTE: NOT ALL SYMBOLS MAY BE APPLICABLE TO THIS PLAN

CONTOURS

TREE

BUSH

STORM MANHOLE

AREA INLET

CURB INLET

GRATED INLET

FLARED END SECTION

STORM SEWER

GRATED MANHOLE

STORM DESIGNATOR

DRAINAGE PIPE

SANITARY MANHOLE

SANITARY SEWER

CLEAN OUT

SANITARY DESIGNATOR

LIGHT POLE

POWER POLE

OVERHEAD UTILITY

UNDERGROUND ELECTRIC

UNDERGROUND TELEPHONE

GAS LINE

GAS VALVE

GAS METER

GAS MARKER

WATER LINE

WATER VALVE

WATER METER

FIRE HYDRANT

LIGHT STANDARD

FENCE

BOLLARD

RETAINING WALI

CONCRETE PAVEMENT

GUARD RAI

PROPERTY LIN

EASEMENT SETBACK

SPACING

As Shown

As Shown

As Shown

SPACING

As Shown

SIZE

2" Cal. Min.

SIZE

1.5" Cal. Min

SIGN

PROPOSED

COMMENTS

B&B

B&B

COMMENTS

STEM

MAINTENANCE SHALL BEGIN IMMEDIATELY AFTER EACH PLANT IS PLANTED AND CONTINUE UNTIL ITS ACCEPTANCE HAS BEEN CONFIRMED BY THE CITY FORESTER OR HIS DESIGNEE.

4. ALL TREES SHALL BE GUARANTEED BY THE DEVELOPER TO BE IN VIGOROUS GROWING CONDITION AT THE TIME OF PLANTING. ACCEPTANCE OF PLANT MATERIAL SHALL BE FOR GENERAL CONFORMANCE TO SPECIFIED SIZE, CHARACTER, AND QUALITY AND SHALL NOT RELIVE THE CONTRACTOR OF RESPONSIBILITY FOR FULL CONFORMANCE TO THE CONTRACT DOCUMENTS, INCLUDING CORRECT SPECIES AND/OR CULTIVAR.

DEVELOPER SHALL PROMPTLY RAISE AND STRAIGHTEN TREES THAT SETTLE OR LEAN, FOR A PERIOD O 18 MONTHS.

6. DEVELOPER WILL TREAT FOR ANY DISEASE, OR INSECT PROBLEM THAT COULD CAUSE SIGNIFICANT HARM

DEVELOPER WILL GUARANTEE AND REPLACE ANY TREE THAT DIES FOR A PERIOD OF 18 MONTHS. THE CITY FORESTER OR HIS DESIGNEE SHALL HAVE THE RIGHT TO INSPECT TREES FOR GROWING CONDITION, AND REQUIRE REPLACEMENT IF NECESSARY. TO BE CONSIDERED ACCEPTABLE, PLANTS SHALL BE FREE OF DEAD OR DYING BRANCHES AND BRANCH TIPS AND SHALL BEAR FOLIAGE OF NORMAL DENSITY, SIZE, AND COLOR. REPLACEMENTS SHALL BE SUBJECT TO ALL REQUIREMENTS STATED IN THIS SPECIFICATION. REPLACEMENT TREES WILL ALSO BE GUARANTEED FOR A PERIOD OF ONE YEAR FROM THE DATE THAT THEY WERE PLANTED

DEVELOPER WILL NOT BE HELD RESPONSIBLE FOR TREES THAT ARE VANDALIZED, OR OTHERWISE DAMAGED DUE TO CIRCUMSTANCES BEYOND THE CONTRACTOR'S CONTROL, ANY TREES IDENTIFIED AS DYING DUE TO CIRCUMSTANCES BEYOND THE CONTROL OF THE DEVELOPER, MUST BE INSPECTED AND VERIFIED BY A REPRESENTATIVE FROM THE CITY FORESTER'S OFFICE.

ON-SITE LANDSCAPE **IREMENTS**

COMMENTS	+ ST. C 1520 \$ 5 cute 3 5t. Che 636.97 www.
	PLANN
<u>.</u>	URVEYING
ED IN	ERING / S
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Kurt A. Kutter

P.E. -2018021213

on 09/30/2022.

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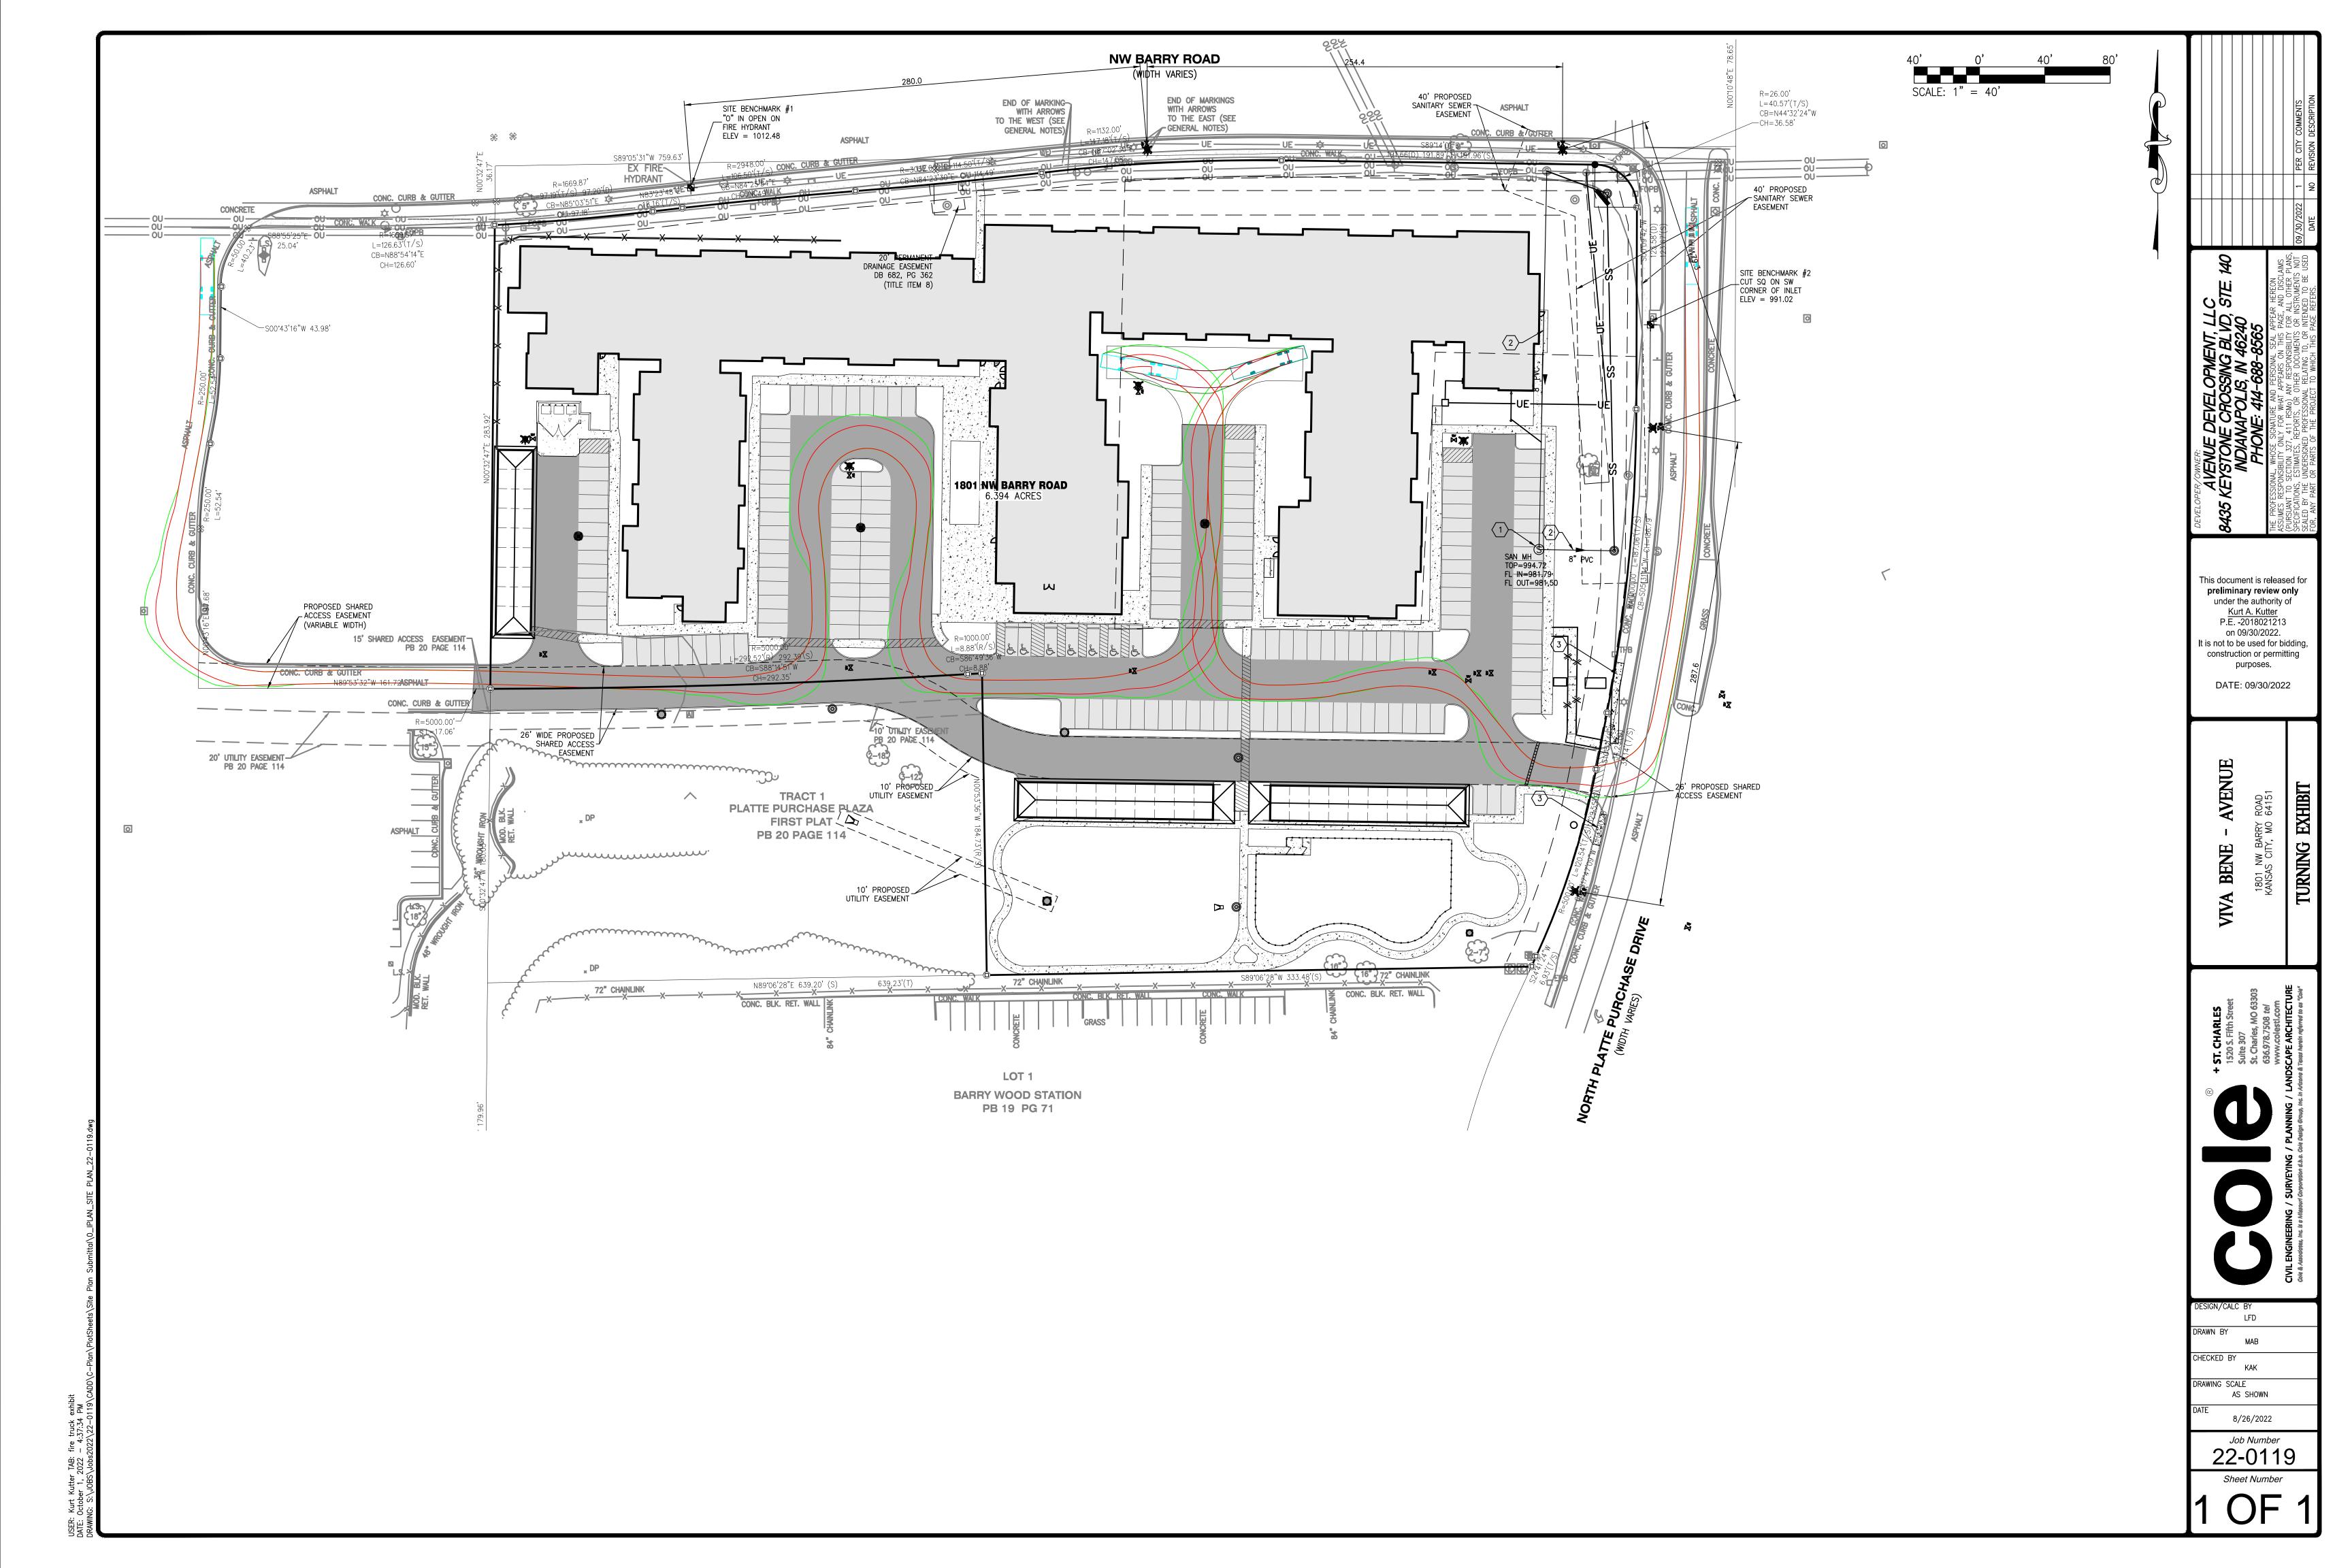
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DRAWING SCALE

AS SHOWN 8/26/2022

Job Number 22-0119








MATERIAL LEGEND



ASPHALT SHINGLE

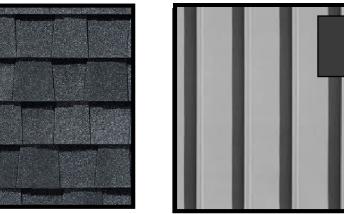

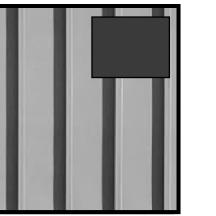

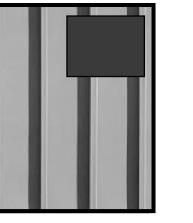




METAL ROOFING







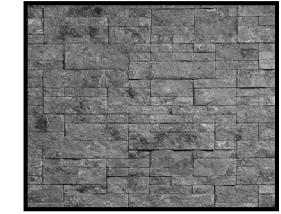

BRICK MASONRY VENEER WHITE WASHED - RED BRICK STONE MASONRY VENEER GRAY COLORED STONE



CONEXUS


DESIGN

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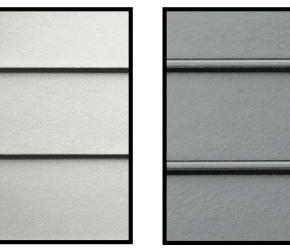
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WITHOUT PRIOR WRITTEN AUTHORIZATION

COMMUNIT


BOARD AND BATTEN

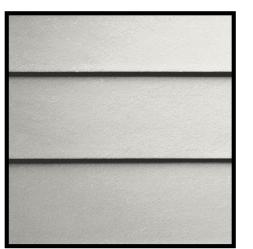

FIBER CEMENT SIDING 1



FIBER CEMENT SIDING 2 STABLE GRAY OR SIMILAR

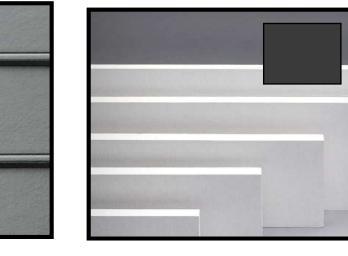

FIBER CEMENT TRIM **BOARDS** CHARCOAL




ALUMINUM STOREFRONT / HANDRAILS BLACK

FIBER CEMENT

PANEL WITH




METAL FASCIAS

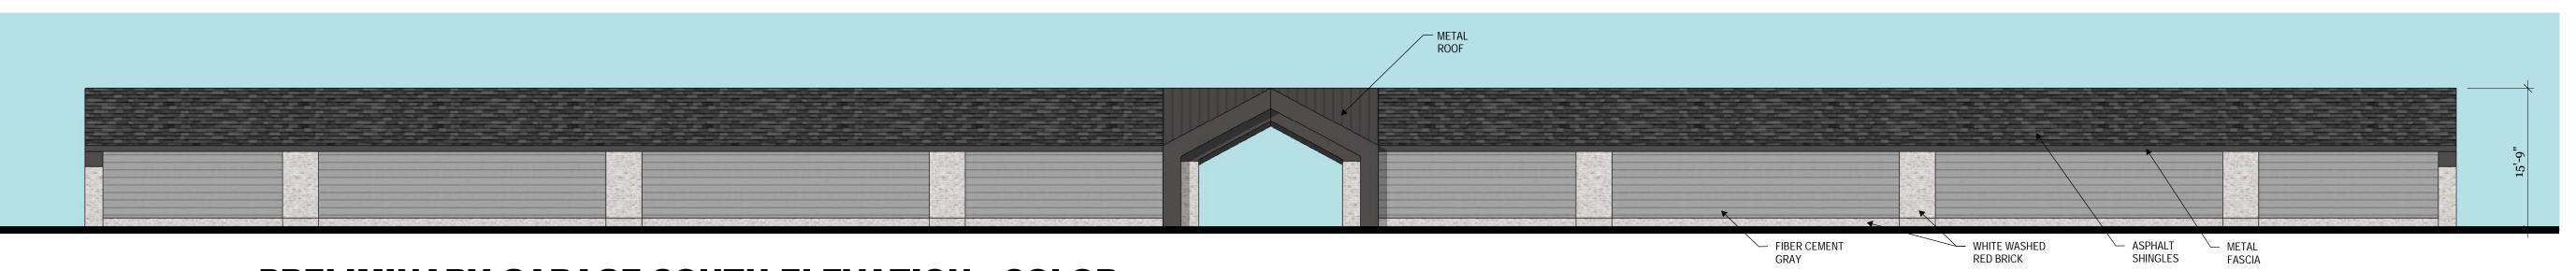


PRELIMINARY GARAGE SOUTH ELEVATION - COLOR

SCALE: 1" = 10'

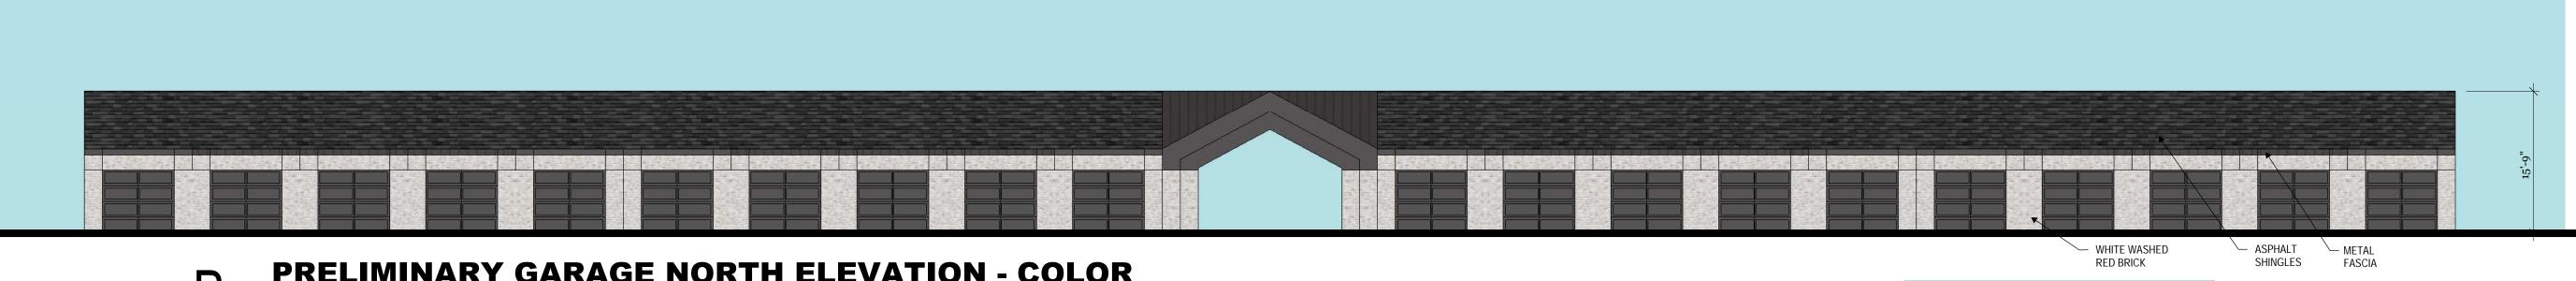


PRELIMINARY GARAGE NORTH ELEVATION - COLOR


SCALE: 1" = 10'

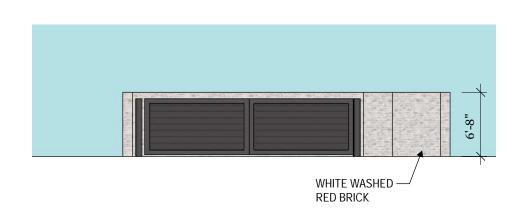


PRELIMINARY DUMPSTER FRONT

SCALE: 1" = 10'

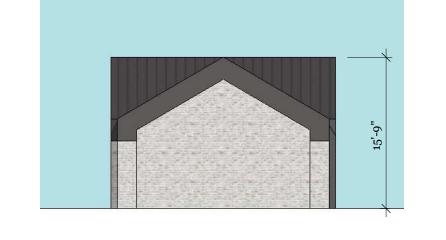

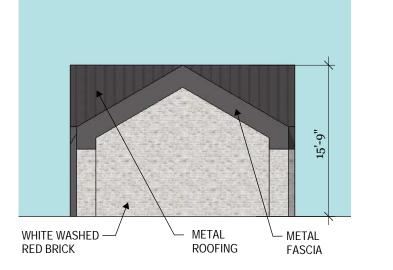

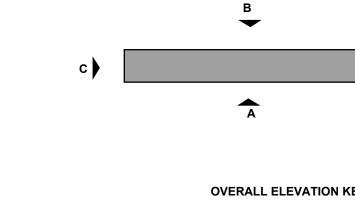

OVERALL ELEVATION KEY

9/23/2022

REVISIONS

SHEET TITLE

RENDERING /ACCESSORY

BUILDING ELEVATIONS

A200

PROJECT NO. **05-2022-001-MO**

PRELIMINARY EAST AND WEST ELEVATION - COLOR

SCALE: 1" = 10'



PRELIMINARY NORTH ELEVATION - COLOR

SCALE: 1/8" = 1'-0"



PRELIMINARY NORTH ELEVATION - COLOR

SCALE: 1/8" = 1'-0"



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- VIVA BENE E ADULT COMMUNITY

REVISIONS

SHEET TITLE
COLOR
BUILDING ELEVATIONS

SEAL

SCALE

6 OVERALL ELEVATION KEY
 PROJECT NO.
 05-2022-001-MO

 PHASE
 PRELIMINARY

 DATE
 9/23/2022

A201

1/8" = 1'-0"



PRELIMINARY NORTH ELEVATION - COLOR

SCALE: 1/8" = 1'-0"





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COMMUNITY BENE

REVISIONS

SHEET TITLE
COLOR BUILDING ELEVATIONS

PROJECT NO. **05-2022-001-MO** 9/23/2022

A202



5 PRELIMINARY SOUTH ELEVATION - COLOR SCALE: 1/8" = 1'-0"



CONE XUS.

DESIGN
PLLC

1724 EAST COCONINO DRIVE, CHANDLER ARIZONA 85249

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VIVA BENE

REVISIONS

SHEET TITLE
RENDERING /ACCESSORY
BUILDING ELEVATIONS

SEAL

PROJECT NO. 05-2022-001-MO
PHASE PRELIMINARY

DATE 9/23/2022

SCALE 1/8" = 1'-0"

A203

6 OVERALL ELEVATION KEY

PRELIMINARY SOUTH ELEVATION - COLOR

SCALE: 1/8" = 1'-0"



PRELIMINARY SOUTH ELEVATION - COLOR

SCALE: 1/8" = 1'-0"



3 2 1 8 OVERALL ELEVATION KEY

GRADE/ RETAINING — WALL IN FRONT OF ELEVATION CONE WUS.

DESIGN
PLLC

1724 EAST COCONINO DRIVE, CHANDLER ARIZONA 85249
(317) 753-5259 WWW.CONEXUSDESIGN.COM

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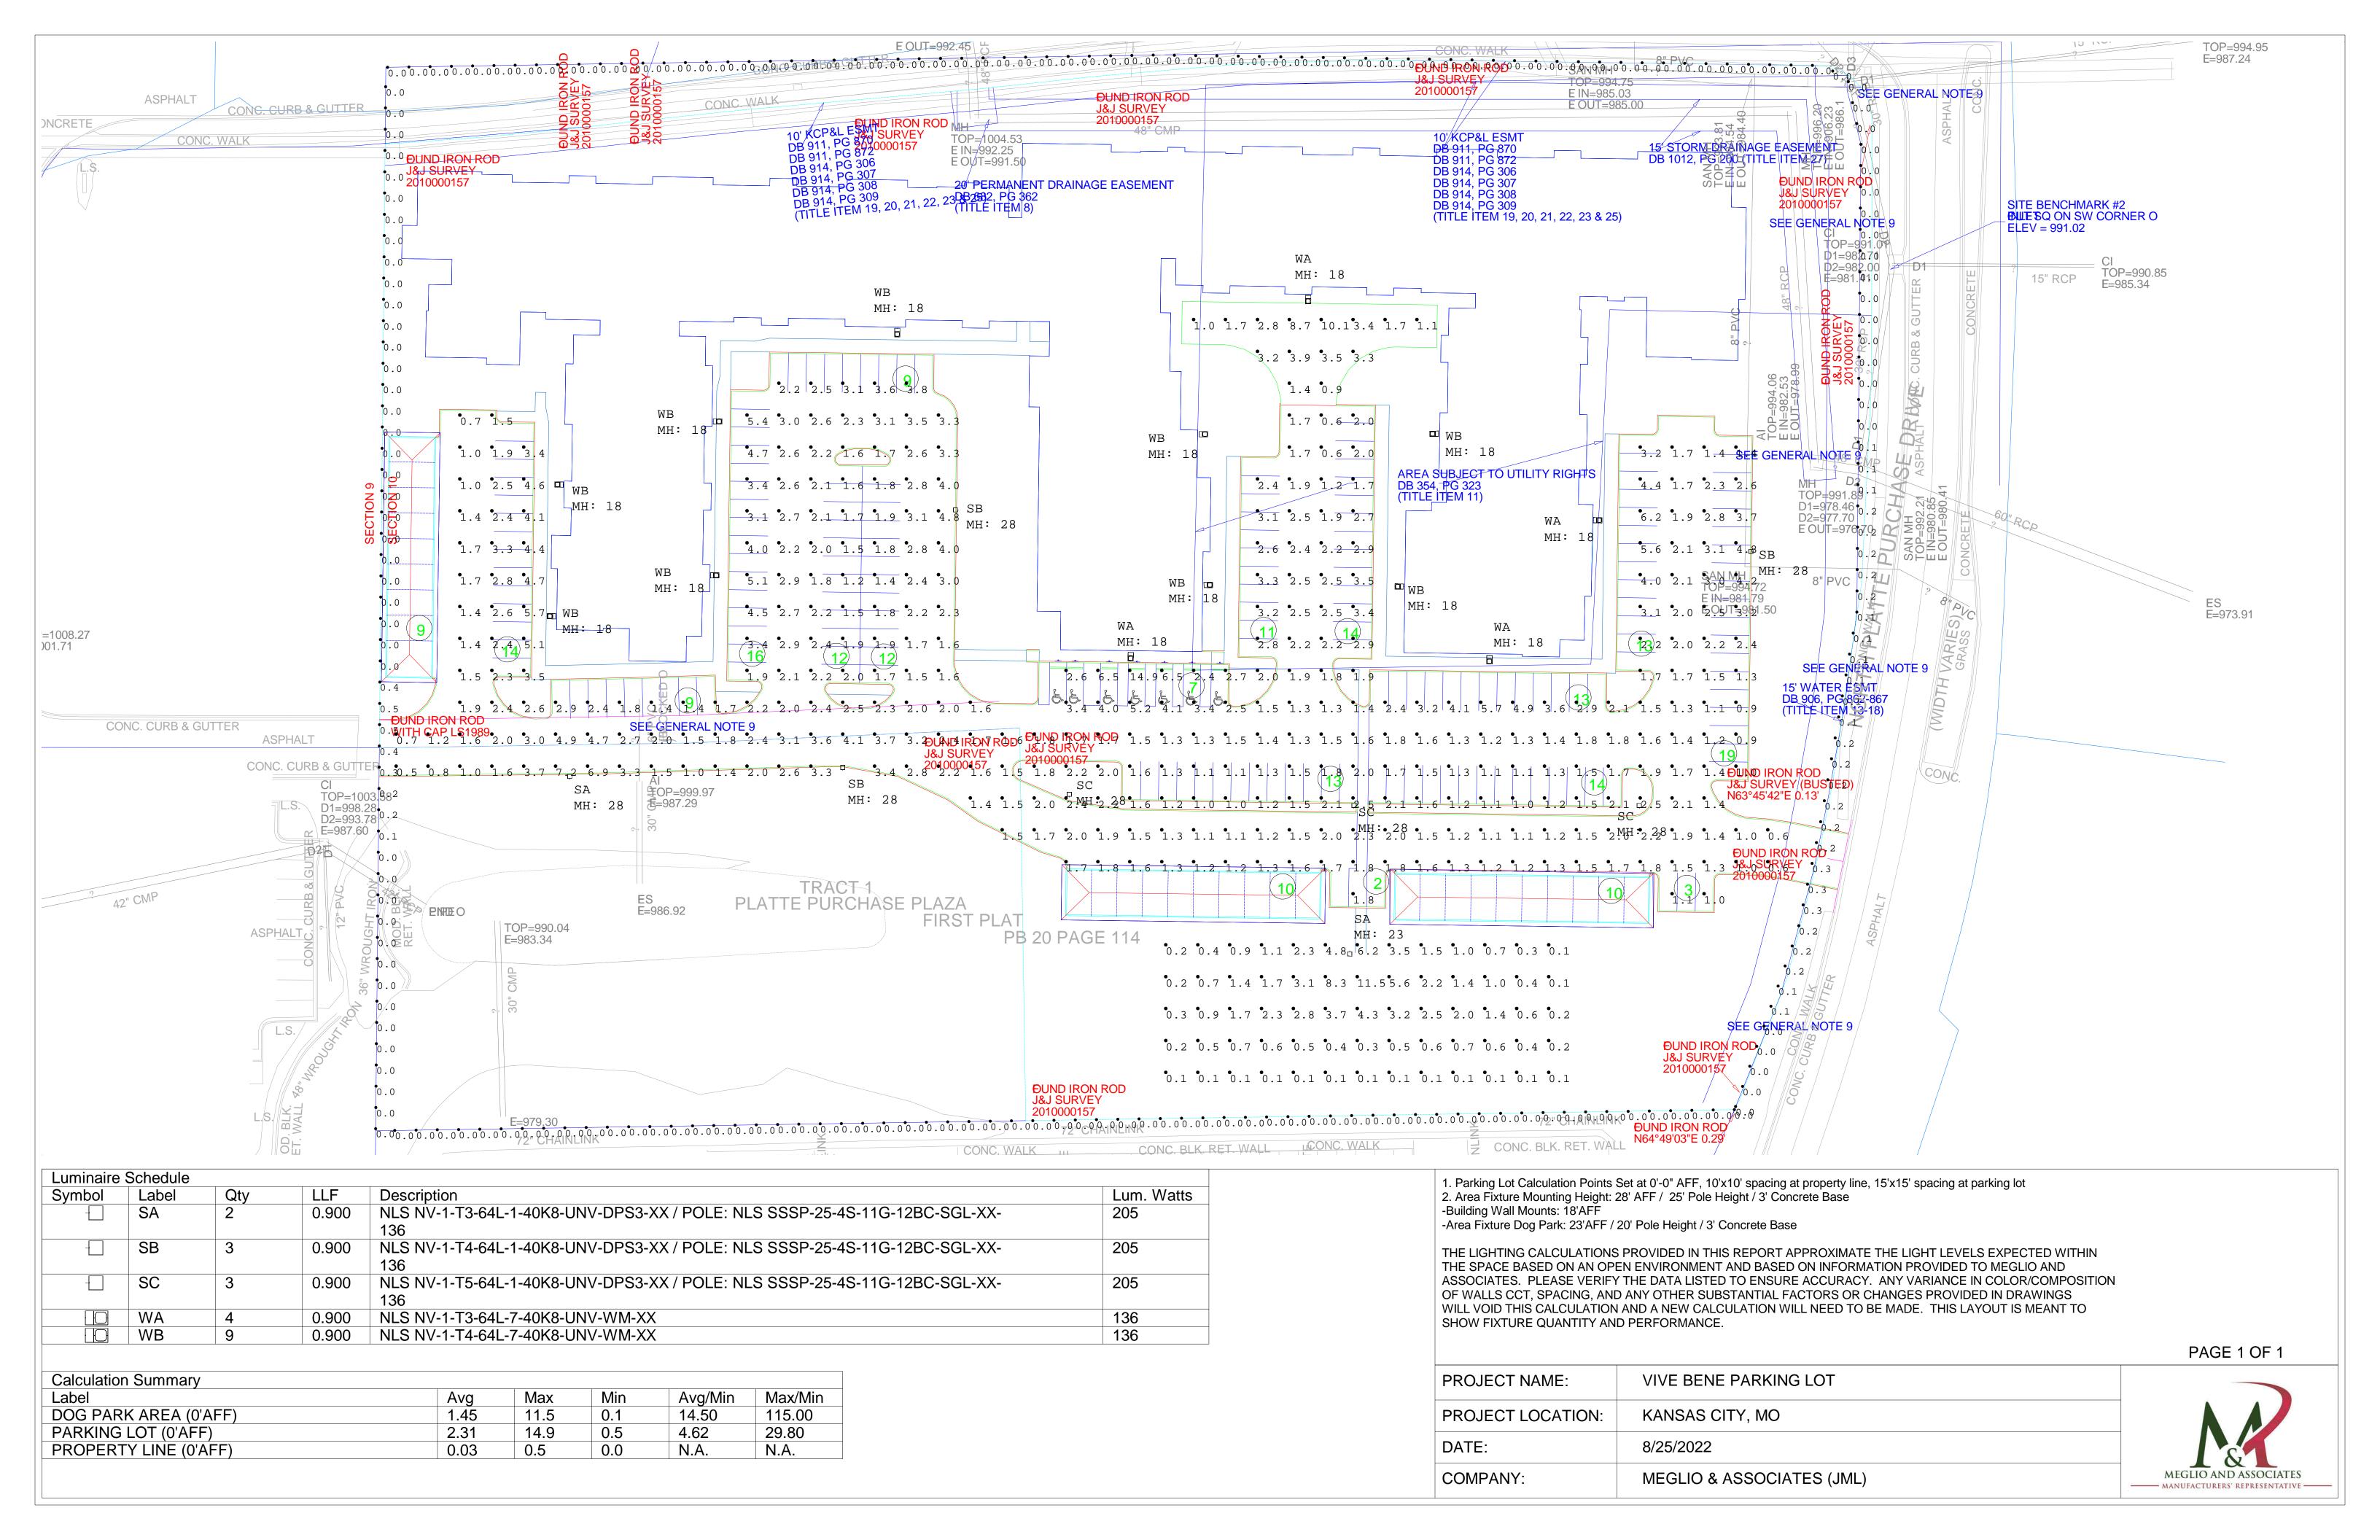
REVISIONS

BUILDING ELEVATIONS

SEAL

PROJECT NO. **05-2022-001-MO**PHASE **PRELIMINARY**DATE **9/23/2022**SCALE **1/8" = 1'-0"**

A204



Public Meeting Notice

Please join							
for a meeting about							
case number							
case number							
proposed for the following address:							
Meeting Date:							
Meeting Time:							
Meeting Location:							
Project Description:							
If you have any questions, please contact:							
Name:							
Phone:							
Email:							

You are receiving this notice in accordance with city code that requires a public meeting with neighborhoods for certain types of development projects. You can read more about the process requirements at kcmo.gov/publicengagement



If you would like further information on this proposed project, please visit the city's planning and permitting system, Compass KC, at Compasskc.kcmo.org. You may search by project type and address/case number to find project details.

Sincerely,

SIGN IN SHEET	30-Aug-22
Location: Barry School - 2001 N	W 87 Terrace, Kansas City, MO
KANSAS CITY VIVA BEN	E - CD-CPC-2022-00162
Name (First, Last) Email	Phone Number Signature
Javier & mangt. cu-	9) 593-6125
Time Hay D. Walters time mol mgt. com	913 - 972-4260
KUET KUTTER COLESTE COM KKUTTER (2) COM	314749-0770
TAYLOR WILLIAMSON TWILLIAMSON® ROCEMANN.COM	34.409.1905
MATT Kwapio	414-617-9171
Meg Sutton Meg Sutton Montton Cavenneder.com	4146888565 USuth
LOOPER @ POTEMINO, COM	314 678 H48
•	





Public Meeting Summary Form

Project Case #
Meeting Date:
Meeting Location:
Meeting Time (include start and end time):
Additional Comments (optional):