

# SHEET LIST

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A0.00	COVER SHEET
C1	OVERALL SITE PLAN
C2	SITE PLAN
C3	DEVELOPMENT GRADING PLAN
C4	DEVELOPMENT UTILITY PLAN
L1.00	STREETSCAPE PLAN
L1.01	GRAND AVE. AMENITY LANDSCAPE PLAN
L2.00	ROOFTOP AMENITY PLAN
L2.01	TYPICAL DETAILS
L3.00	PLANTING DETAILS
( A2.00 (A2.01 (A2.02 (A2.03	LOWER LEVEL PLAN FIRST FLOOR PLAN SECOND FLOOR PLAN THIRD THROUGH SIXTH FLOOR PLANS
A3.01	BUILDING ELEVATIONS
(A3.02	BUILDING ELEVATIONS
(A3.03	BUILDING ELEVATIONS

# **PROJECT DATA**

## **DEVELOPMENT SUMMARY TABLE:**

- a. ZONING: EXISTING ZONING: DC-15, MI-5, UR PROPOSED ZONING: DC-15, MI-5, UR
- TOTAL LAND AREA: b. SQUARE FEET: 27,698 SF ACRES: 0.636 ACRES
- c. RIGHT-OF-WAY: NO EXISTING OR PROPOSED R.O.W. ON SITE
- d. NET LAND AREA: SQUARE FEET: 27,698 SF
- ACRES: 0.636 ACRES
- e. PROPOSED USE: MIXED-USE TO INCLUDE MULTI-FAMILY RENTAL AND COMMERCIAL / RETAIL
- BUILDING HEIGHT: HEIGHT ABOVE GRADE: 75'-0" **STORIES: 7 STORIES**
- a. GROSS FLOOR AREA:

LEVEL	AREA	UNITS	UNIT DIVISION
LOWER LEVEL	24,579 SF	0 UNITS	(0) UNITS
FIRST FLOOR	24,126 SF	5 UNITS	(5) 1 BR;
SECOND FLOOR	17,827 SF	17 UNITS	(15) 1 BR; (2) 2 B
THIRD FLOOR	17,861 SF	20 UNITS	(18) 1 BR; (2) 2 B
FOURTH FLOOR	17,861 SF	20 UNITS	(18) 1 BR; (2) 2 B
FIFTH FLOOR	17,861 SF	20 UNITS	(18) 1 BR, (2) 2 B
SIXTH FLOOR	17,861 SF	20 UNITS	(18) 1 BR; (2) 2 B
TOTAL	137,976 SF	102 UNITS	(92) 1 BR; (10) 2

# **PROJECT TEAM**

#### **OWNER:**

OAKS PROPERTIES LLC 3550 EAST 46TH ST., SUITE 120 MINNEAPOLIS, MN 55406 P. (612) 630-5943

PROJECT CONTACT:

JEFF MCMAHON P. (913) 313-8806 E. JM-Kramerica@outlook.com

#### ARCHITECT:

NSPJ ARCHITECTS, P.A. 3515 W. 75TH ST, SUITE 201 PRAIRIE VILLAGE, KS 66208 P. (913) 831-1415 F. (913) 831-1563

PROJECT CONTACT: IRIS ABRAMOF P. (913) 831-1415 E. IABRAMOF@NSPJARCH.COM

#### LANDSCAPE:

NSPJ ARCHITECTS, P.A. 3515 W. 75TH ST, SUITE 201 PRAIRIE VILLAGE, KS 66208 P: (913) 831-1415 F: (913) 831-1563

PROJECT CONTACT:

BRAD HUS P. (913) 831-1415 E. BHUS@NSPJARCH.COM

## **OAKS - RIVER MARKET** 110 E 3RD STREET | KANSAS CITY, MISSOURI

DEVELOPMENT PLAN SUBMITTAL | 18 JULY 2022

- h. BUILDING COVERAGE & F.A.R. LOT COVERAGE: 87% F.A.R.: 5.0
- A. DENSITY: GROSS DENSITY: 160 DU/AC. NET DENSITY: 160 DU/AC.
- REQUIRED VEHICULAR PARKING RATIO REQUIRED SPACES: 0 SPACES PROVIDED SPACES: 106 SPACES
- REQUIRED BICYCLE PARKING RATIO: REQUIRED SPACES: 11 SHORT TERM / 34 LONG TERM PROVIDED SPACES: 18 SHORT TERM / 36 LONG TERM
- AMENDMENT REQUESTS NO AMENDMENT REQUESTS
- m. AMENDMENT REQUESTS NO AMENDMENT REQUESTS
- n. GROUND-FLOOR COMMERCIAL FLOOR SPACE: REQUIRED: 5,428 SF
- PROVIDED: 6,593 SF Anne

## LEGAL DESCRIPTION

#### TRACT 1

ALL OF THE EASTERLY 60 FEET OF LOT 72, MEASURED AT RIGHT ANGLES TO THE NORTHEASTERLY OR ALLEY LINE OF LOT 72, AND ALL OF THE SOUTHEASTERLY 40 FEET OF THE EASTERLY 40 OF LOT 72, MEASURED PARALLEL TO AND AT RIGHT ANGLES TO THE NORTHEASTERLY OR ALLEY LINE OF LOT 73, IN BLOCK 7, ON THE PLAT OF THE TOWN OF KANSAS, COMMONLY CALLED OLD TOWN, A SUBDIVISION OF LAND IN KANSAS CITY, JACKSON COUNTY, MISSOURI.

ALL OF LOT 71, EXCEPT THE WEST 23 FEET, IN BLOCK 7, ON THE PLAT OF THE TOWN OF KANSAS, COMMONLY CALLED OLD TOWN, A SUBDIVISION OF LAND IN KANSAS CITY, JACKSON COUNTY, MISSOURI.

ALL OF THE EAST 57.5 FEET OF THE WEST 82 FEET OF LOT 72, BLOCK 7, ON THE PLAT OF THE TOWN OF KANSAS, COMMONLY CALLED OLD TOWN, A SUBDIVISION OF LAND IN KANSAS CITY, JACKSON COUNTY, MISSOURI.

#### TRACT 2

ALL OF LOT 70, EXCEPT THE NORTH 20 FEET THEREOF, BLOCK 7, ON THE PLAT OF THE TOWN OF KANSAS, COMMONLY CALLED OLD TOWN, A SUBDIVISION OF LAND IN KANSAS CITY, JACKSON COUNTY, MISSOURI.

TRACT 3

THE WEST 24.5 FEET OF LOT 72 AND THE SOUTH 40 FEET OF WEST 102 FEET OF LOT 73 AND THE NORTH 20 FEET OF LOT 73, BLOCK 7, ON THE PLAT OF THE TOWN OF KANSAS, COMMONLY CALLED OLD TOWN, A SUBDIVISION OF LAND IN KANSAS CITY, JACKSON COUNTY, MISSOURI.

#### STRUCTURAL:

BOB C. CAMPBELL & CO., INC. 4338 BELLEVIEW KANSAS CITY, MO 64111 P: (816) 531-4144 F: (913) 531-8572

PROJECT CONTACT:

MIKE FALBE P. (816) 531-4144 E. MFALBE@BDC-ENGRS.COM

## MEP:

RTM ENGINEERING CONSULTANTS 9225 INDIAN CREEK PKWY, SUITE 1075 OVERLAND PARK, KS 66210 P: (913) 322-1400

PROJECT CONTACT: JIM BASQUETTE P. (913) 322-1400 E. JIM BASQUETTE@RTMEC.COM

## CIVIL:

CFS ENGINEERS 1421 E 104TH STREET, STE 100 KANSAS CITY, MO 64131 P. (816) 333-4477

PROJECT CONTACT:

LANCE SCOTT P. (816) 333-4477 E. LSCOTT@CFSE.COM **INTERIORS:** TBD

#### TRACT 4

THE RIGHT-OF-WAY OWNED BY THE KANSAS CITY SOUTHERN RAILWAY COMPANY IN THE SOUTH 40 FEET OF LOT 70, AND IN LOTS 71, 72, AND 73, BLOCK 7, ON THE PLAT OF THE TOWN OF KANSAS, COMMONLY CALLED OLD TOWN, A SUBDIVISION OF LAND IN KANSAS CITY, JACKSON COUNTY, MISSOURI.

#### **TRACT 5**

THE WEST 23 FEET OF LOT 71, BLOCK 7, ON THE PLAT OF THE TOWN OF KANSAS, COMMONLY CALLED OLD TOWN, A SUBDIVISION IN KANSAS CITY, JACKSON COUNTY, MISSOURI.

#### **TRACT 6**

ALL OF THE PLATTED ALLEY BETWEEN LOTS 70 TO 73, BLOCK 7, AS SHOWN ON THE PLAT OF THE TOWN OF KANSAS, COMMONLY CALLED OLD TOWN, A SUBDIVISION OF LAND IN KANSAS CITY, JACKSON COUNTY, MISSOURI, DESCRIBED AS FOLLOWS:

BEGINNING ON THE WEST LINE OF LOT 70, BLOCK 7, 20 FEET SOUTH OF THE NORTHWEST CORNER; THENCE SOUTH, ALONG THE WEST LINE OF LOTS 70 AND 71, TO THE SOUTHWEST CORNER OF LOT 71 AND A POINT ON THE NORTH RIGHT OF WAY OF WEST 3<sup>RD</sup> STREET; THENCE WEST, ALONG THE NORTH RIGHT OF WAY OF WEST 3<sup>RD</sup> STREET, TO THE SOUTHEAST CORNER OF LOT 72, BLOCK 7; THENCE NORTH, ALONG THE EAST LINE OF LOTS 72 AND 73, TO THE NORTHEAST CORNER OF LOT 73; THENCE EAST 8 FEET, PERPENDICULAR TO THE EAST LINE, TO THE CENTERLINE OF THE PLATTED ALLEY; THENCE SOUTH ALONG THE CENTERLINE, TO A POINT 8 FEET WEST OF A POINT 20 FEET SOUTH OF THE WEST LINE AND THE NORTHWEST CORNER OF LOT 70; THENCE EAST 8 FEET, PERPENDICULAR TO THE WEST LING, TO THE POINT OF BEGINNING.

#### VICINITY MAP NOT TO SCALE



**CONTRACTOR:** 

HAUSMANN CONSTRUCTION 4800 MAIN STREET, SUITE 108A KANSAS CITY, MO 64112 P. (402) 438-3230

PROJECT CONTACT

JEFF NICKLAS P. (816) 260-5788 E. JEFFN@KAUSMANNCONSTRUCTION.COM E: BRANDON.FISHER@INTERTEK.COM

## **ENVELOPE:**

INTERTEK BUILDING SCIENCE SOLUTIONS 11826 BORMAN DRIVE ST.LOUIS, MO 63146

PROJECT CONTACT **BRANDON FISHER** 


P. (31) 696-1224

## GOVERNMENT


CITY OF KANSAS CITY, MISSOURI CITY PLANNING AND DEVELOPMENT 414 E. 12TH STREET, 15TH FLR P. (816) 513-1500

PROJECT CONTACT PLANNING@KCMO.ORG KANSAS CITY, MO 64106



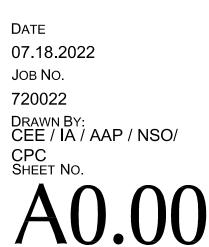


REVISIONS ● 09.05.2022 - DEVELOPMENT PLAN RESUBMITTAL

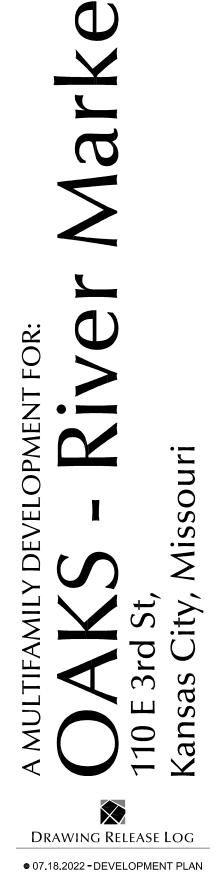





913.831.1415
913.831.1563
NSPJARCH.COM

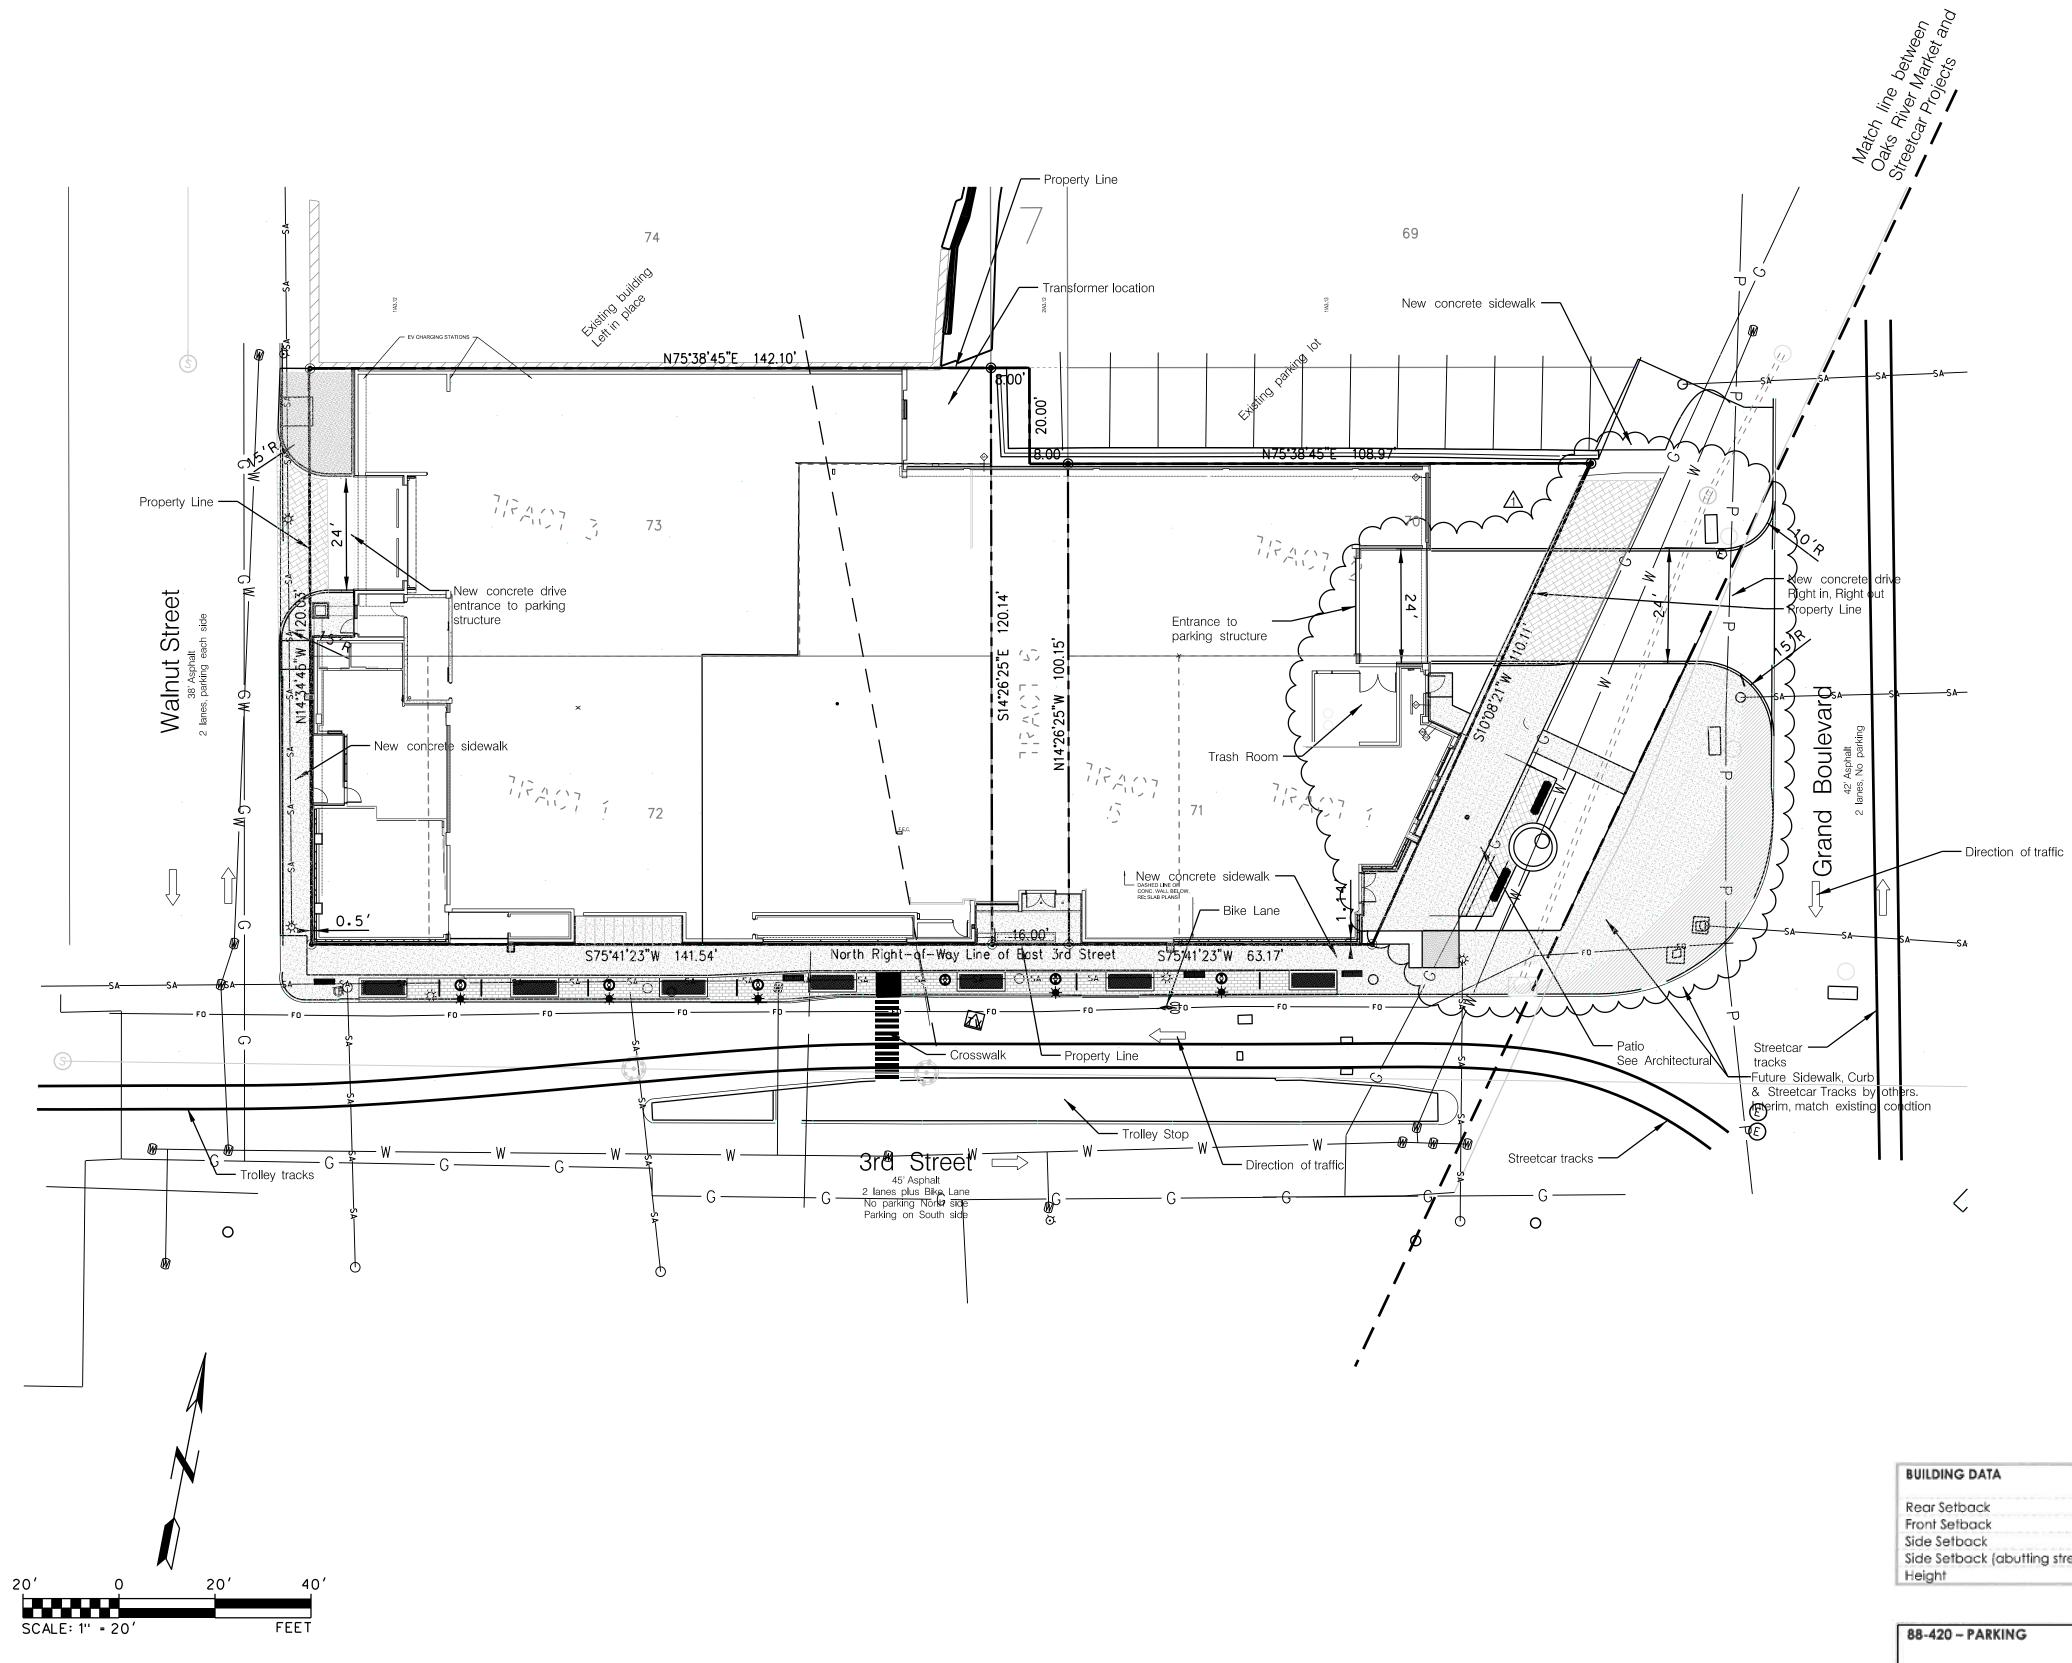

BUILDING DATA	Required	Propos		viation quested?	Approved
Rear Setback	0	0			
Front Setback	0	0			
Side Setback	0	0			
Side Setback (abutting street)	0	0			
Height	1	75' (7 5	Stories)		
	Required	Proposed	Required	Proposed	Proposed? (See 88-420-16)
88-420 - PARKING	Vehicle Sp Required		Bike Space	1	Alternatives Proposed? (See 88-420-16)
Proposed Use(s) Mixed use Mullti-family and Commercial	Retail 0		34 Long Teri	18 Short Term m36 Long Tern	n
TOTAL	0			18 Short Term m 36 Long Tern	
		$\mathcal{C}$			
		$\Lambda$			

TRACT 6

Legal	Description
TRACT 1	

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ALL OF THE EAST 57 <sup>1</sup>/2 FEET OF THE WEST 82 FEET OF LOT 72, BLOCK 7, ON THE PLAT OF THE TOWN OF KANSAS, COMMONLY CALLED OLD TOWN, A SUBDIVISION OF LAND IN KANSAS CITY, JACKSON COUNTY, MISSOURI. TRACT 2

ALL OF LOT 70, EXCEPT THE NORTH 20 FEET THEREOF, BLOCK 7, ON THE PLAT OF THE TOWN OF KANSAS, COMMONLY CALLED OLD TOWN, A SUBDIVISION OF LAND IN KANSAS CITY, JACKSON COUNTY, MISSOURI. TRACT 3

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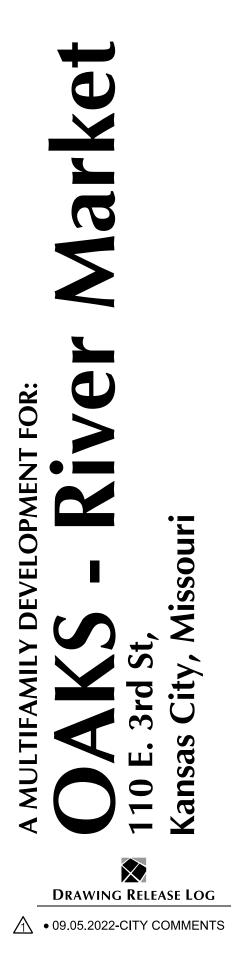
BEGINNING ON THE WEST LINE OF LOT 70, BLOCK 7, 20 FEET SOUTH OF THE NORTHWEST CORNER; THENCE SOUTH, ALONG THE WEST LINE OF LOTS 70 AND 71, TO THE SOUTHWEST CORNER OF LOT 71 AND A POINT ON THE NORTH RIGHT OF WAY OF WEST 3RD STREET; THENCE WEST, ALONG THE NORTH RIGHT OF WAY OF WEST 3RD STREET, TO THE SOUTHEAST CORNER OF LOT 72, BLOCK 7; THENCE NORTH, ALONG THE EAST LINE OF LOTS 72 AND 73, TO THE NORTHEAST CORNER OF LOT 73; THENCE EAST 8 FEET, PERPENDICULAR TO THE EAST LINE, TO THE CENTERLINE OF THE PLATTED ALLEY; THENCE SOUTH, ALONG THE CENTERLINE, TO A POINT 8 FEET WEST OF A POINT 20 FEET SOUTH OF THE WEST LINE AND THE NORTHWEST CORNER OF LOT 70; THENCE EAST 8 FEET, PERPENDICULAR TO THE WEST LING, TO THE POINT OF BEGINNING.

SITE DATA	Existing	Proposed	Deviation Requested?	Approved
Zoning	DC–15,1	MI-5,UR		
Gross Land Area				
in square feet	27,698	27,698		
in acres	0.636 Acres	0.636 Acres		
<b>Right-of-way Dedication</b>				
in square feet	0	0		
in acres	0	0		
Net Land Area				
in square feet	27,698	27,698		
in acres	0.636 Acres	0.636 Acres		
Building Area (sq. ft.)	0	24,579		
Floor Area Ratio	0%	89%		1
Residential Use Info				-
Total Dwelling Units				
Detached House				
Zero lot line House				
Cottage House				
Semi-attached House				
Townhouse				
Two-unit House				
Multi-unit House				
Colonnade				
Multiplex				
Multi-unit Building	0	102		
Total Lots				
Residential				
Public/Civic				
Commercial /Parking				
Industrial				
Other				

DEVIATION NOTE:
There are no deviations requested for
this project.


OVERALL SITE PLAN C1






REVISIONS

DATE 07.18.2022 JOB NO. 571115 DRAWN BY CEE / AAP / NSO SHEET NO.

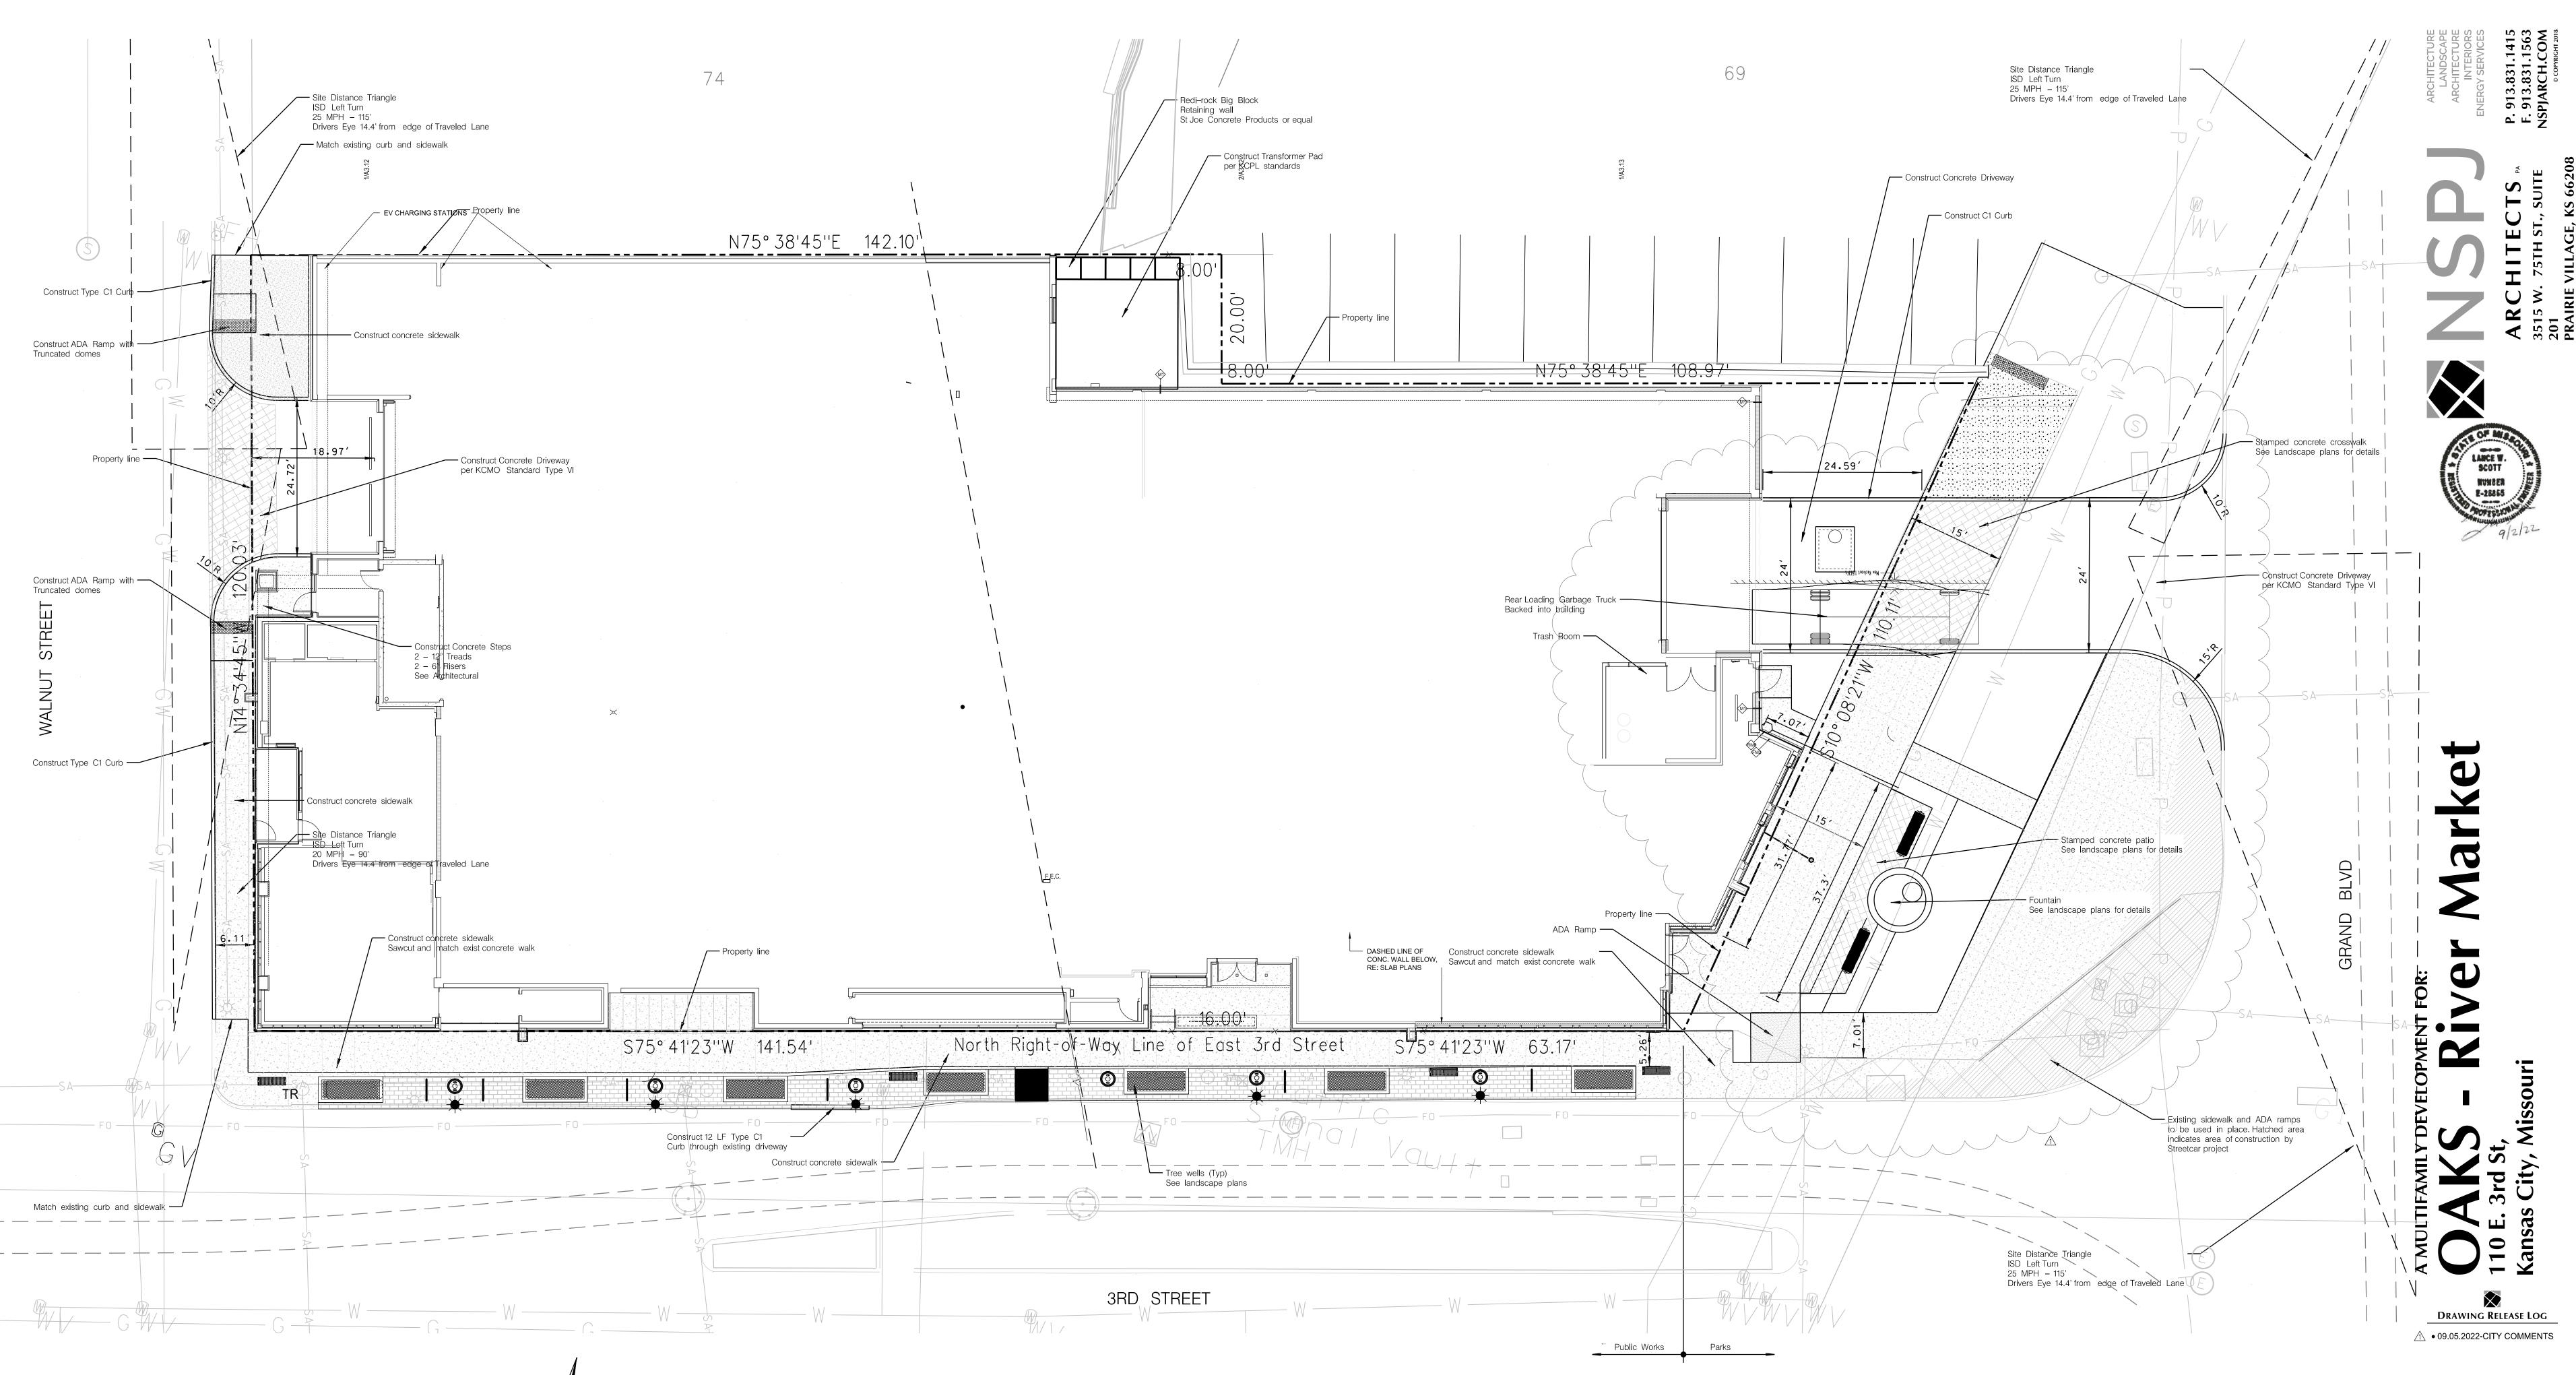

#### <u>NOTES:</u>

- 1. ALL PARKING LOT DIMENSIONS ARE TO BACK OF CURB UNLESS OTHERWISE NOTED.
- 2. CONTRACTOR IS RESPONSIBLE FOR PROTECTION OF ALL PROPERTY CORNERS.
- 3. CONTRACTOR SHALL MATCH EXISTING PAVEMENT IN GRADE AND ALIGNMENT TO PROVIDE SMOOTH SURFACE TRANSITIONS BETWEEN NEW ENTRANCE DRIVES AND EXISTING STREETS.
- 4. CONTRACTOR SHALL MATCH EXISTING CURB & GUTTER IN GRADE, SIZE, TYPE, AND ALIGNMENT AT CONNECTIONS TO EXISTING STREETS.
- 5. CONTRACTOR IS RESPONSIBLE FOR REPAIRS OF DAMAGE TO ANY EXISTING IMPROVEMENTS DURING CONSTRUCTION SUCH AS, BUT NOT LIMITED TO: DRAINAGE UTILITIES, PAVEMENT, STRIPING, CURB, ETC., AND TO INCLUDE ANY WORK IN DOT R.O.W. AND/OR CITY R.O.W. REPAIRS SHALL BE EQUAL TO OR BETTER THAN EXISTING CONDITIONS.
- 6. ALL WORK ON THIS PLAN SHALL BE DONE IN STRICT ACCORDANCE WITH THE OWNER'S SITEWORK SPECIFICATIONS AND/OR GEOTECHNICAL REPORT.
- CONTRACTOR SHALL REFER TO ARCHITECTURAL PLANS FOR EXACT LOCATIONS AND DIMENSIONS PRECISE BUILDING DIMENSIONS. SIDEWALK AND SPECIFIC BUILDING AREA TREATMENTS AND IMPROVEMENTS.
- 8. ALL DIMENSIONS SHOWN ON BUILDINGS ARE TO OUTSIDE FACE OF BUILDING.
- CONTRACTOR SHALL PROTECT BUILDING CORNERS, TRANSFORMERS, AND ALL OTHER APPLICABLE STRUCTURES WITH BOLLARDS. REFER TO ARCHITECTURAL PLANS FOR LOCATIONS.
- 10. THE EARTHWORK FOR ALL BUILDING FOUNDATIONS AND SLABS SHALL BE IN ACCORDANCE WITH THE ARCHITECTURAL SPECIFICATIONS AND GEOTECH REPORT.
- 11. PARKING LOT STRIPING SHALL BE ACCORDING TO KCMO STANDARDS. ALL STRIPING IS TO HAVE TWO COATS OF PAINT (MIN.).
- 12. ALL CONSTRUCTION WITHIN THE RIGHT-OF-WAY SHALL CONFORM TO THE CITY OF KANSAS CITY, MISSOURI STANDARDS AND SPECIFICATIONS.
- 13. ALL ACCESSIBLE PARKING SIGNAGE AND STRIPING SHALL BE IN ACCORDANCE WITH THE AMERICANS WITH DISABILITIES ACT (ADA REQUIREMENTS.
- 14. THE CONTRACTOR SHALL SUPPLY THE OWNER WITH A LIST OF ALL SUB-CONTRACTORS PRIOR TO COMMENCEMENT OF ANY CONSTRUCTION OPERATIONS.
- 15. ALL CURB AND GUTTER SHALL BE TYPE CG-1 UNLESS OTHERWISE NOTED. 16. ALL WORK SHALL CONFORM TO THE APPLICABLE SECTIONS OF THE STANDARD SPECIFICATIONS AND DESIGN CRITERIA OF THE METROPOLITAN CHAPTER OF APWA AND THE CITY OF KANSAS CITY, MISSOURI, IN CURRENT USAGE EXCEPT AS NOTED.
- 17. ALL RADII ARE 4' AT BACK OF CURB UNLESS NOTED OTHERWISE.
- 18. SHOP DRAWINGS OF EACH STRUCTURE WILL BE SUBMITTED TO THE CONSULTANT FOR THE CONSULTANT'S APPROVAL. ONCE ALL STRUCTURES ARE APPROVED BY THE CONSULTANT THE CONTRACTOR SHALL SUBMIT THE SHOP DRAWINGS TO THE SUPERVISOR OF INSPECTIONS FOR CITY APPROVAL.
- 19. THE UNDERGROUND DENTENTION SYSTEM AND BMP CONSTRUCTION WILL BE PERMITED BY THE LAND DEVELOPMENT DIVISION UNDER THE PUBLIC AND PRIVATE SEWER PLANS.

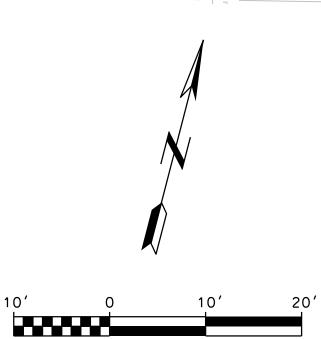


SCALE: 1" = 10'

Street Lighting Note:

REVISIONS

DATE 07.18.2022 JOB NO. 571115 DRAWN BY: CEE / AAP / NSO SHEET NO. **C2** 




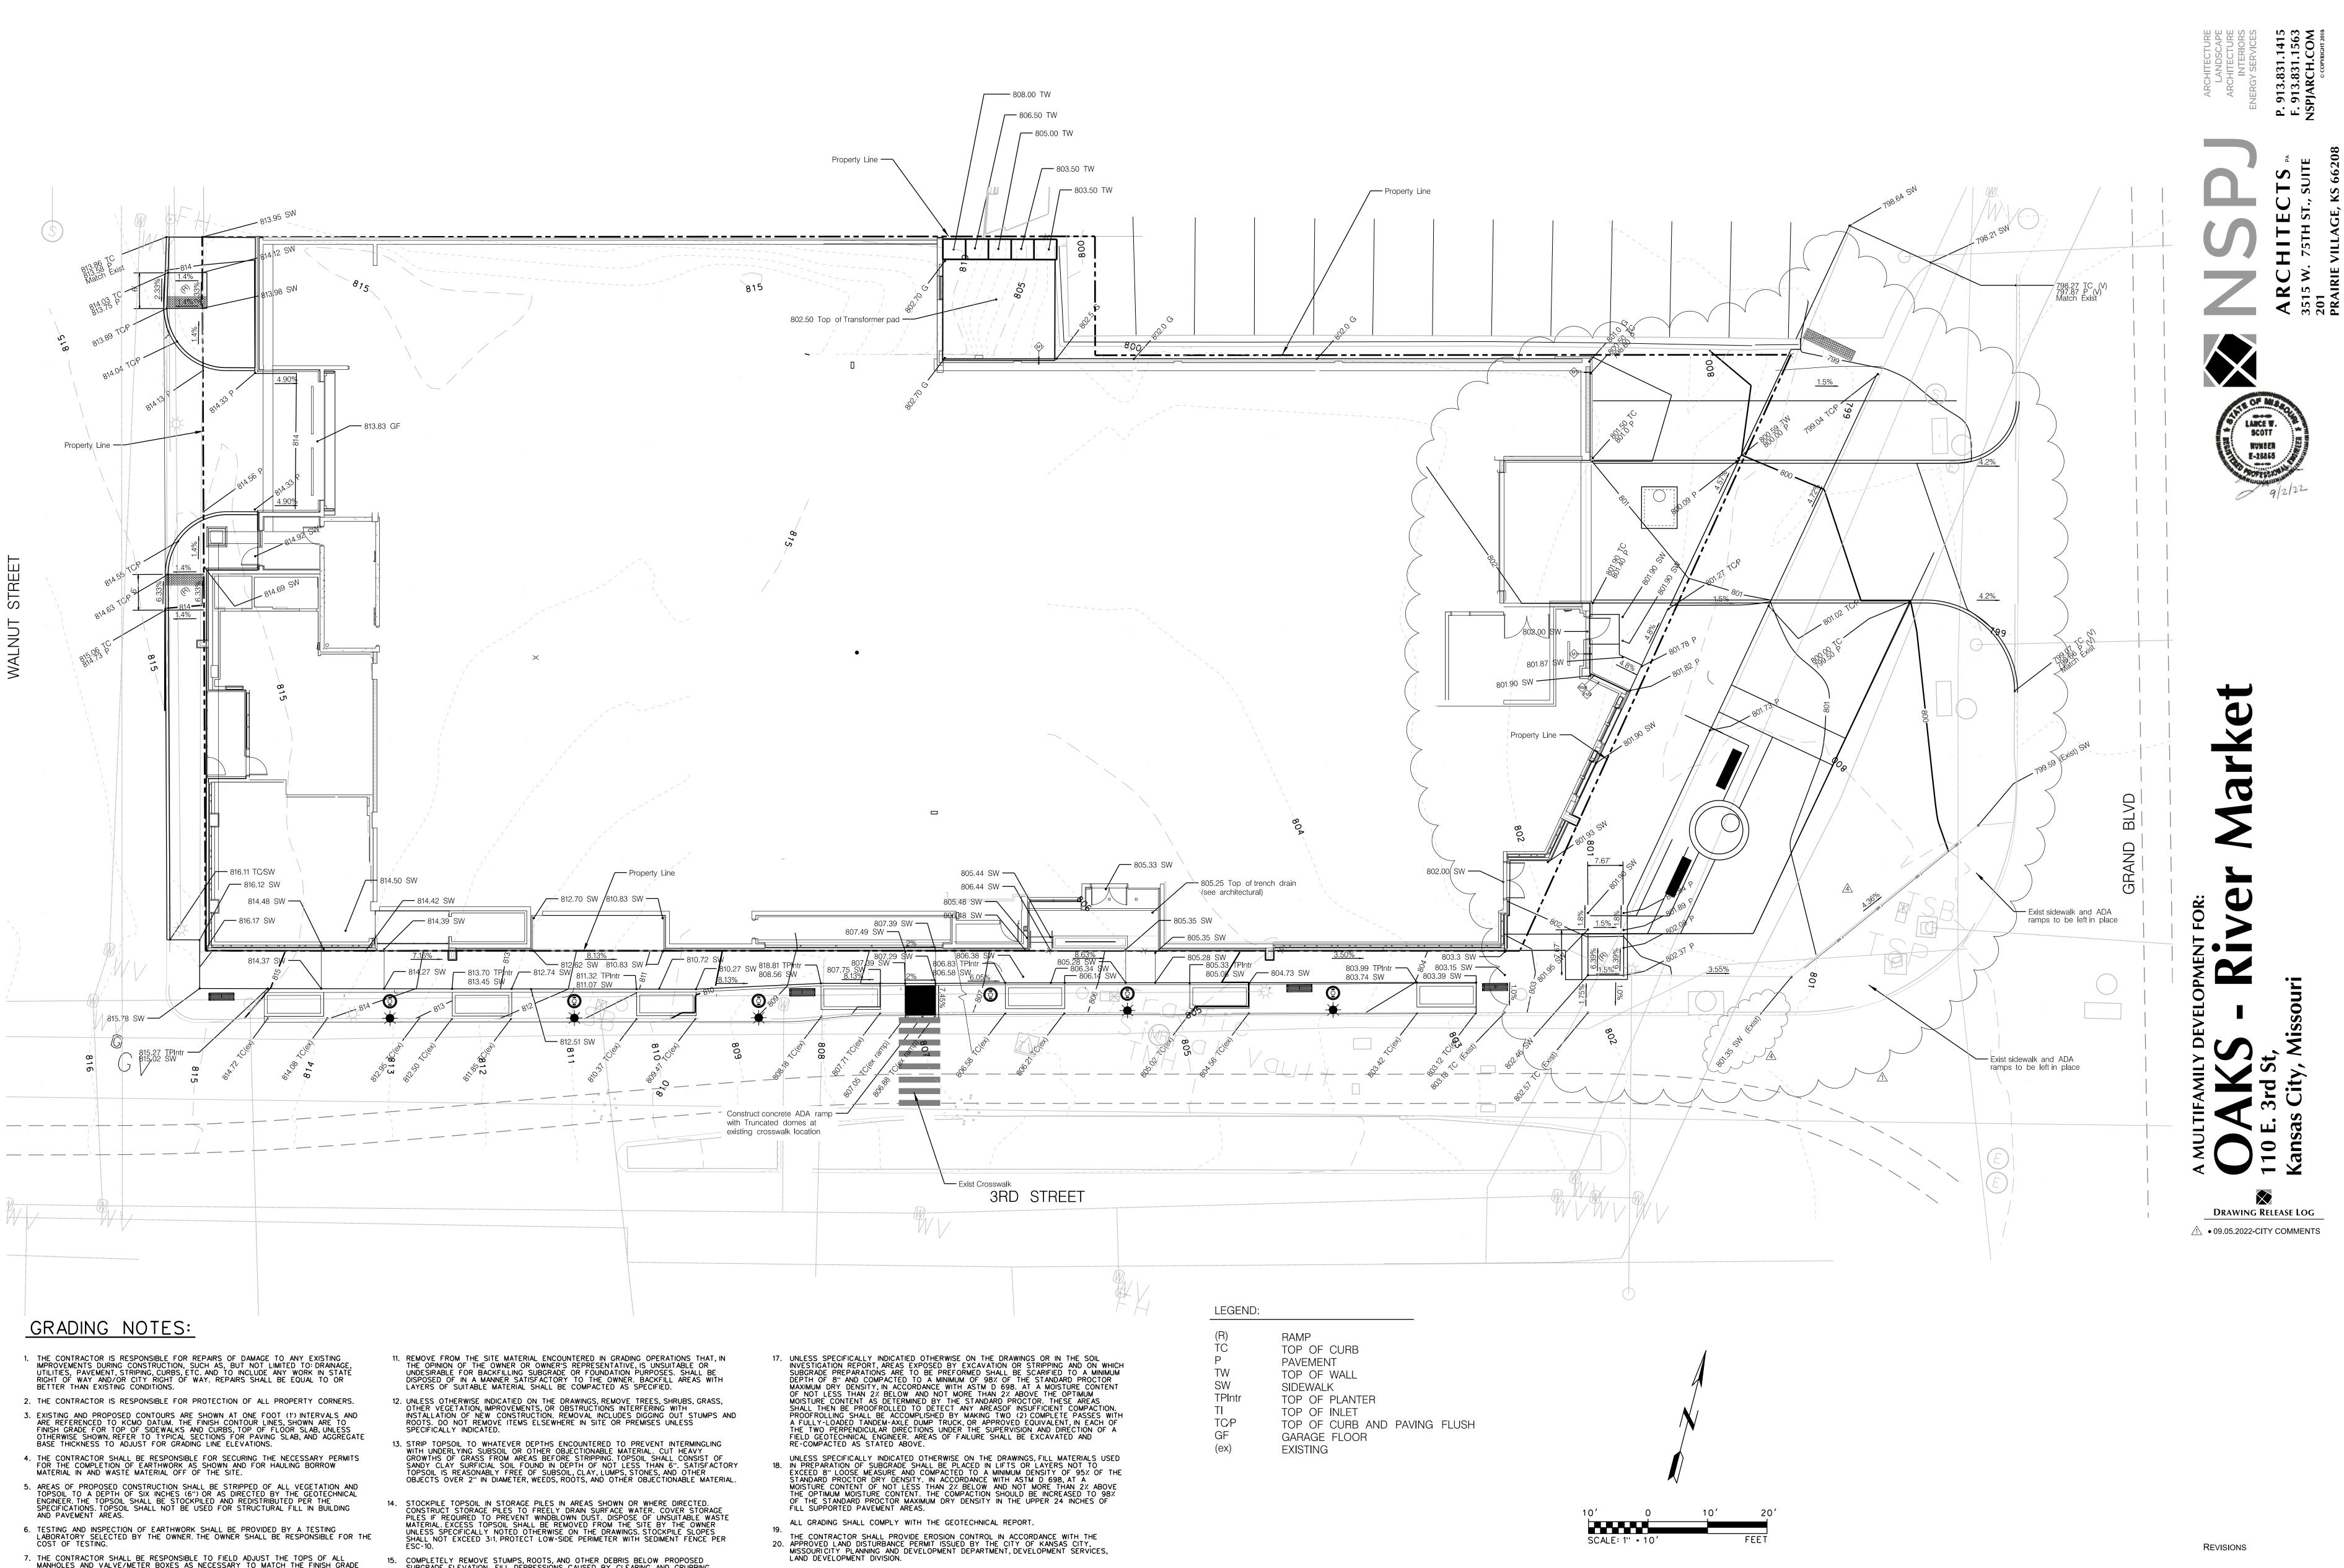


- 7. THE CONTRACTOR SHALL BE RESPONSIBLE TO FIELD ADJUST THE TOPS OF ALL MANHOLES AND VALVE/METER BOXES AS NECESSARY TO MATCH THE FINISH GRADE OF ADJACENT AREAS, NO SEPARATE OR ADDITIONAL COMPENSATION SHALL BE MADE TO THE OWNER FOR MAKING FINAL ADJUSTMENTS TO MANHOLES AND BOXES. SOIL FOR FILLING SHOULD BE GRADED AS IT ARRIVES. 8.
- GRADING SHALL NOT EXCEED A 3' HORIZONTAL TO A 1' VERTICAL SLOPE. 9.
- 9. THE CONTRACTOR SHALL NOT GRADE OUTSIDE THE PROPERTY LINE UNTIL APPROVED 10. FROM APPROPRIATE REGULATORY AGENCIES.
- COMPLETELY REMOVE STUMPS, ROOTS, AND OTHER DEBRIS BELOW PROPOSED SUBGRADE ELEVATION. FILL DEPRESSIONS CAUSED BY CLEARING AND GRUBBING OPERATIONS WITH SATISFACTORY SOIL MATERIAL. UNLESS FURTHER EXCAVATION OR EARTHWORK IS REQUIRED.
- 16. REMOVE EXISTING SOIL ABOVE AND BELOW GRADE IMPROVEMENTS AND ABANDON UNDERGROUND PIPING OR CONDUIT NECESSARY TO PERMIT CONSTRUCTION AND OTHER WORK.

**GRADING PLAN** 

DATE 07.18.2022 JOB NO. 571115 DRAWN BY: CEE / AAP / NSO SHEET NO. **C**3

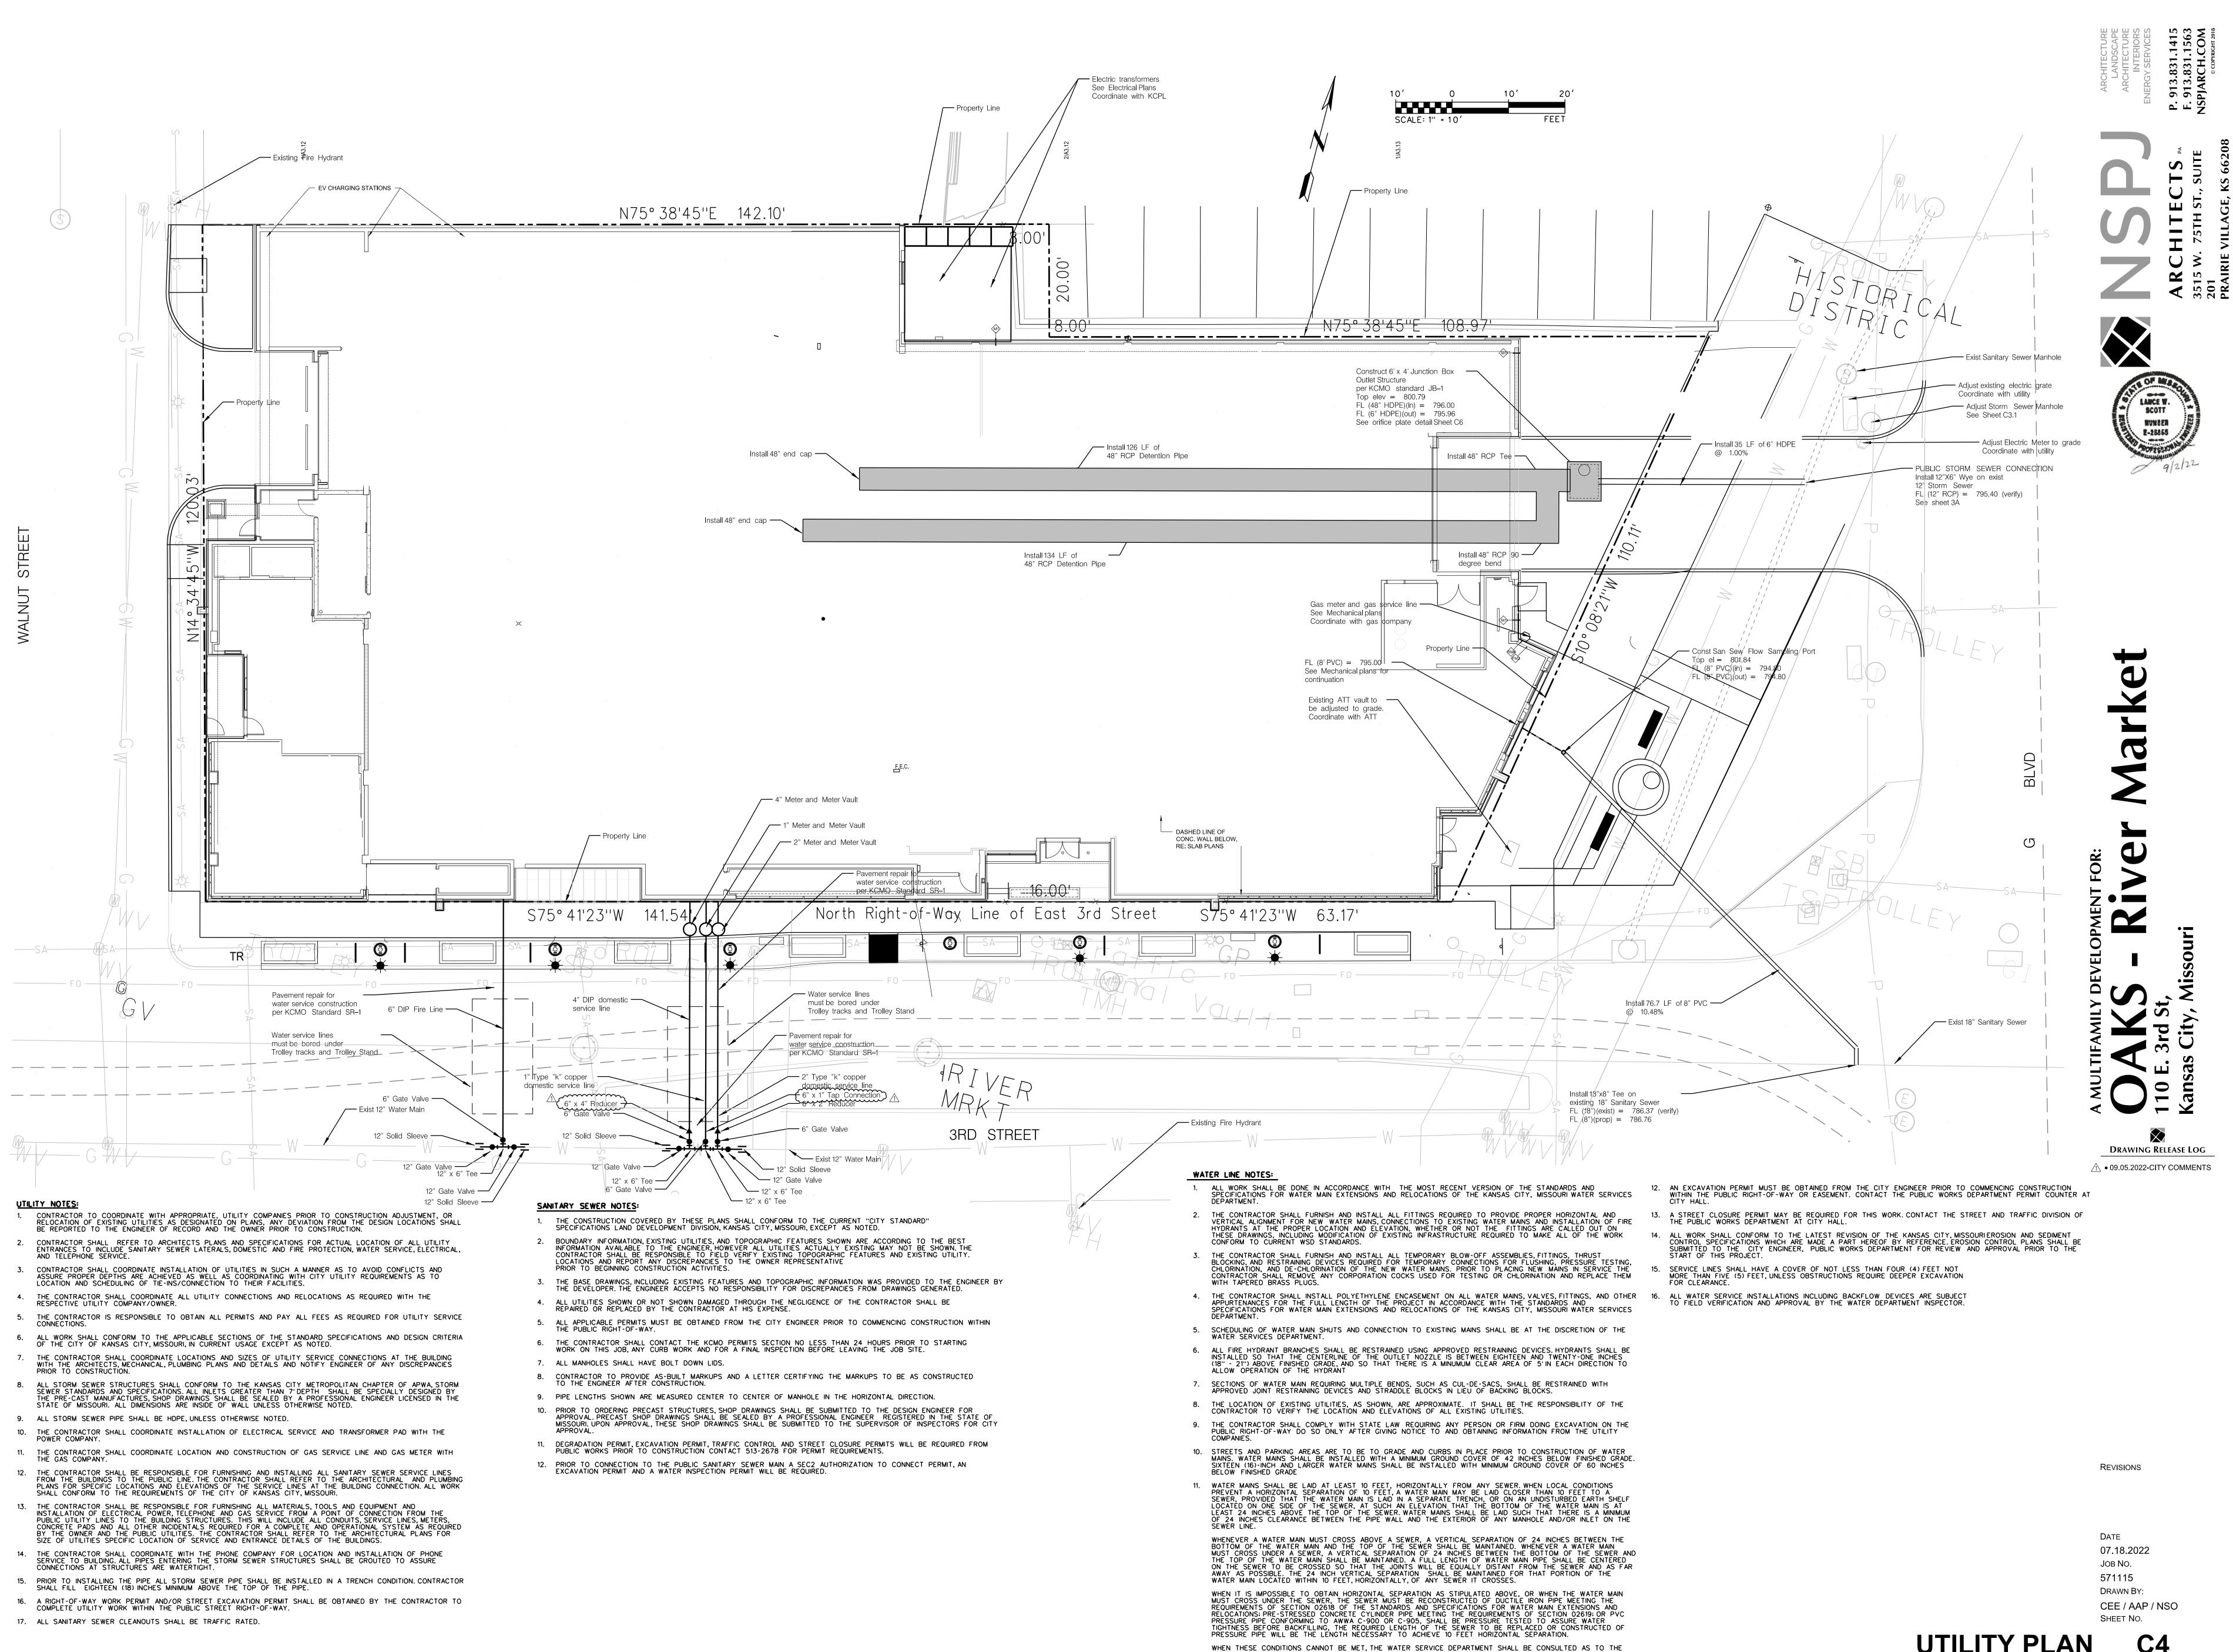



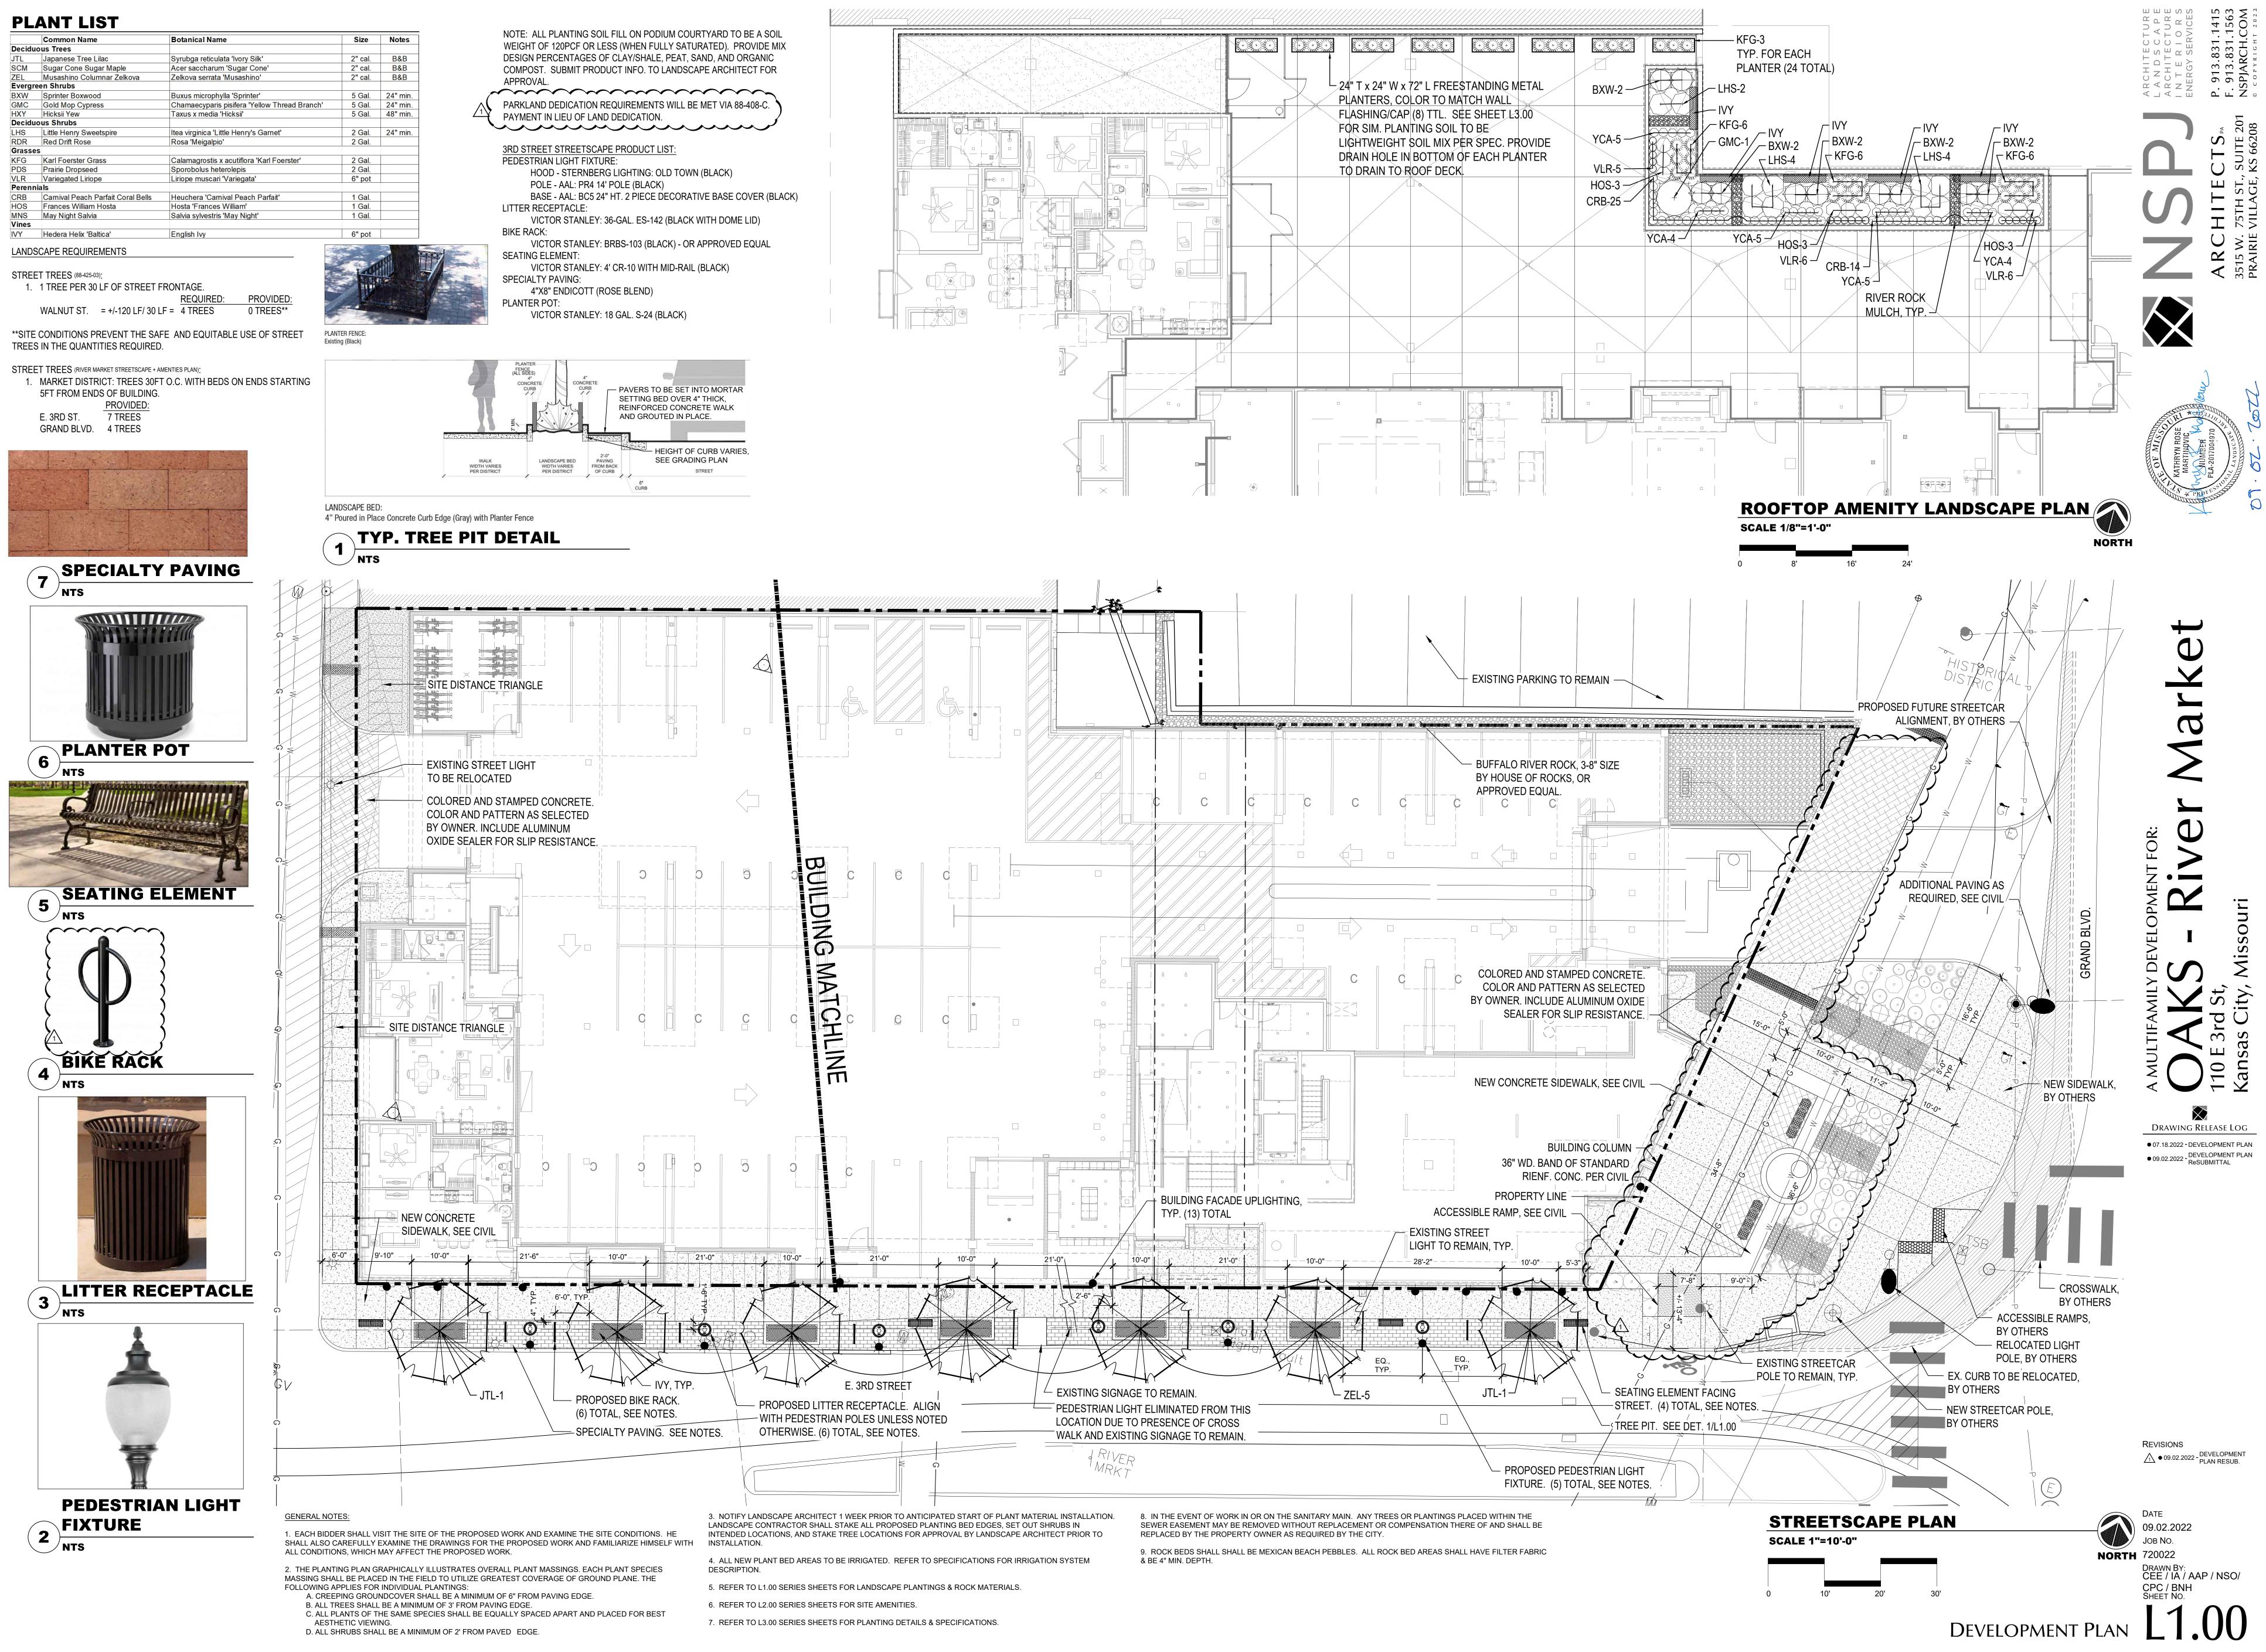



2 PATIO FOUNTAIN - CONCEPT IMAGE 



#### **PLANT LIST**

	Common Name	Botanical Name	Size	Notes
Decidu	ous Trees			
JTL	Japanese Tree Lilac	Syrubga reticulata 'Ivory Silk'	2" cal.	B&B
SCM	Sugar Cone Sugar Maple	Acer saccharum 'Sugar Cone'	2" cal.	B&B
ZEL 🔨	Musashino Columnar Zelkova	Zelkova serrata 'Musashino'	2" cal.	B&B
Evergre	een Shrubs			
BXW	Sprinter Boxwood	Buxus microphylla 'Sprinter'	5 Gal.	24" min
GMC	Gold Mop Cypress	Chamaecyparis pisifera 'Yellow Thread Branch'	5 Gal.	24" min
HXY	Hicksii Yew	Taxus x media 'Hicksii'	5 Gal.	48" min
Decidu	ous Shrubs			
LHS	Little Henry Sweetspire	Itea virginica 'Little Henry's Garnet'	2 Gal.	24" min
RDR	Red Drift Rose	Rosa 'Meigalpio'	2 Gal.	
Grasse	S	~ .		
KFG	Karl Foerster Grass	Calamagrostis x acutiflora 'Karl Foerster'	2 Gal.	
PDS	Prairie Dropseed	Sporobolus heterolepis	2 Gal.	
VLR	Variegated Liriope	Liriope muscari 'Variegata'	6" pot	
Perenn	ials			
CRB	Carnival Peach Parfait Coral Bells	Heuchera 'Carnival Peach Parfait'	1 Gal.	
HOS	Frances William Hosta	Hosta 'Frances William'	1 Gal.	
MNS	May Night Salvia	Salvia sylvestris 'May Night'	1 Gal.	
Vines				
IVY	Hedera Helix 'Baltica'	English Ivy	6" pot	

GENERAL NOTES:

1. EACH BIDDER SHALL VISIT THE SITE OF THE PROPOSED WORK AND EXAMINE THE SITE CONDITIONS. HE SHALL ALSO CAREFULLY EXAMINE THE DRAWINGS FOR THE PROPOSED WORK AND FAMILIARIZE HIMSELF WITH ALL CONDITIONS, WHICH MAY AFFECT THE PROPOSED WORK.

2. THE PLANTING PLAN GRAPHICALLY ILLUSTRATES OVERALL PLANT MASSINGS. EACH PLANT SPECIES MASSING SHALL BE PLACED IN THE FIELD TO UTILIZE GREATEST COVERAGE OF GROUND PLANE. THE FOLLOWING APPLIES FOR INDIVIDUAL PLANTINGS: A. CREEPING GROUNDCOVER SHALL BE A MINIMUM OF 6" FROM PAVING EDGE.

B. ALL TREES SHALL BE A MINIMUM OF 3' FROM PAVING EDGE. C. ALL PLANTS OF THE SAME SPECIES SHALL BE EQUALLY SPACED APART AND PLACED FOR BEST AESTHETIC VIEWING. D. ALL SHRUBS SHALL BE A MINIMUM OF 2' FROM PAVED EDGE.


NOTIFY LANDSCAPE ARCHITECT 1 WEEK PRIOR TO ANTICIPATED START OF PLANT MATERIAL INSTALLATION. LANDSCAPE CONTRACTOR SHALL STAKE ALL PROPOSED PLANTING BED EDGES, SET OUT SHRUBS IN INTENDED LOCATIONS, AND STAKE TREE LOCATIONS FOR APPROVAL BY LANDSCAPE ARCHITECT PRIOR TO INSTALLATION. 4. ALL NEW PLANT BED AREAS TO BE IRRIGATED. REFER TO SPECIFICATIONS FOR IRRIGATION SYSTEM

DESCRIPTION.

- 5. REFER TO L1.00 SERIES SHEETS FOR LANDSCAPE PLANTINGS & ROCK MATERIALS. 6. REFER TO L2.00 SERIES SHEETS FOR SITE AMENITIES.
- 7. REFER TO L3.00 SERIES SHEETS FOR PLANTING DETAILS & SPECIFICATIONS.


8. IN THE EVENT OF WORK IN OR ON THE SANITARY MAIN. ANY TREES OR PLANTINGS PLACED WITHIN THE SEWER EASEMENT MAY BE REMOVED WITHOUT REPLACEMENT OR COMPENSATION THERE OF AND SHALL BE REPLACED BY THE PROPERTY OWNER AS REQUIRED BY THE CITY.


9. ROCK BEDS SHALL SHALL BE MEXICAN BEACH PEBBLES. ALL ROCK BED AREAS SHALL HAVE FILTER FABRIC & BE 4" MIN. DEPTH.

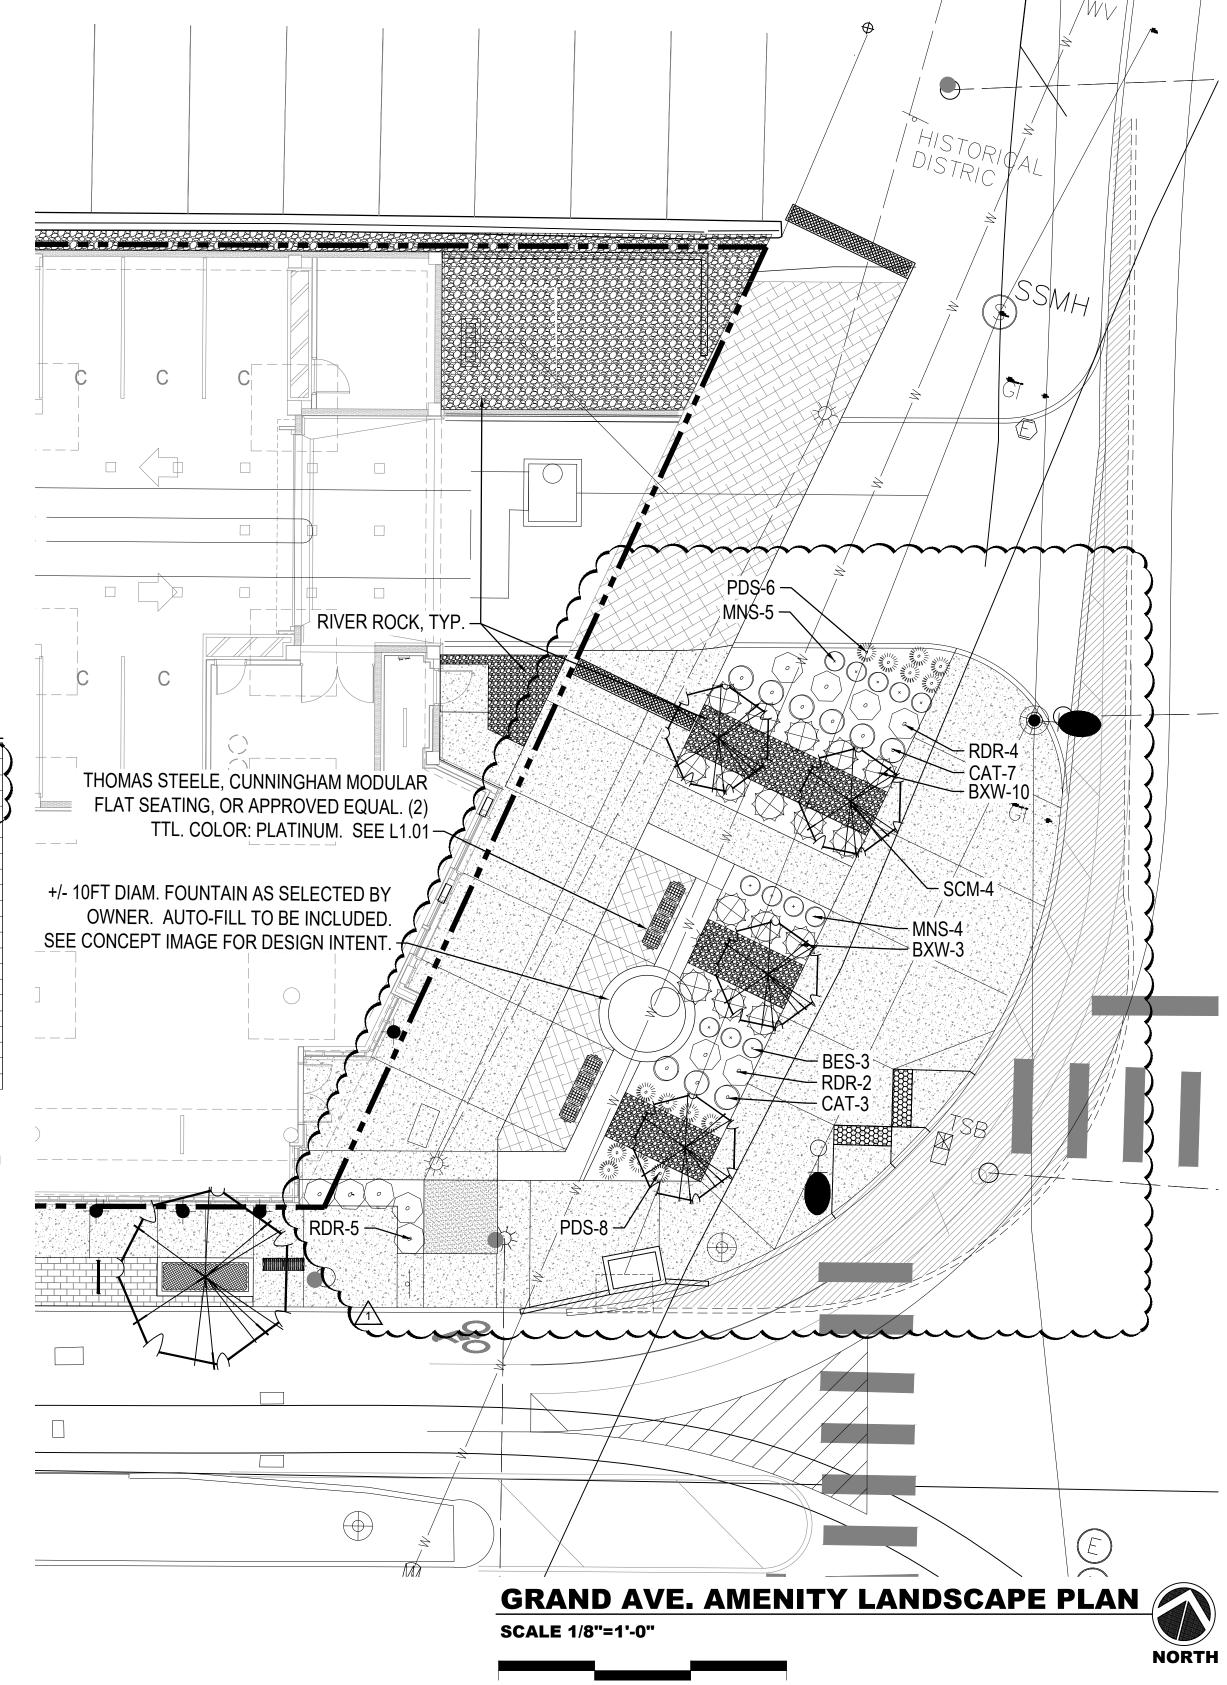


#### B&B 2" cal. 2" cal. B&B 2" cal. B&B 5 Gal. 24" min. 5 Gal. 24" min. 5 Gal. 24" min. 5 Gal. 48" min. 2 Gal. 24" min. 2 Gal. 2 Gal. 2 Gal. 6" pot 1 Gal. 1 Gal. 1 Gal.



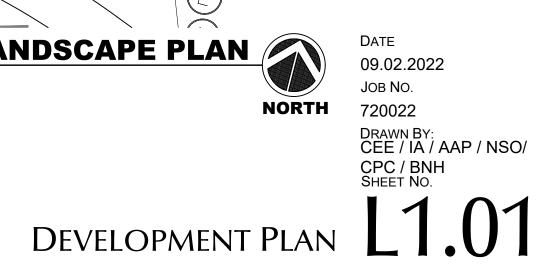


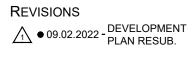

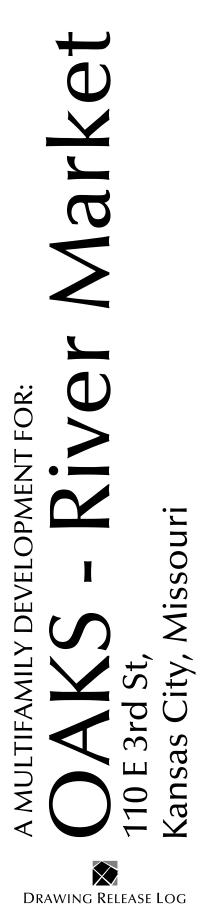

• 07.18.2022 - DEVELOPMENT PLAN ● 09.02.2022 - DEVELOPMENT PLAN ReSUBMITTAL



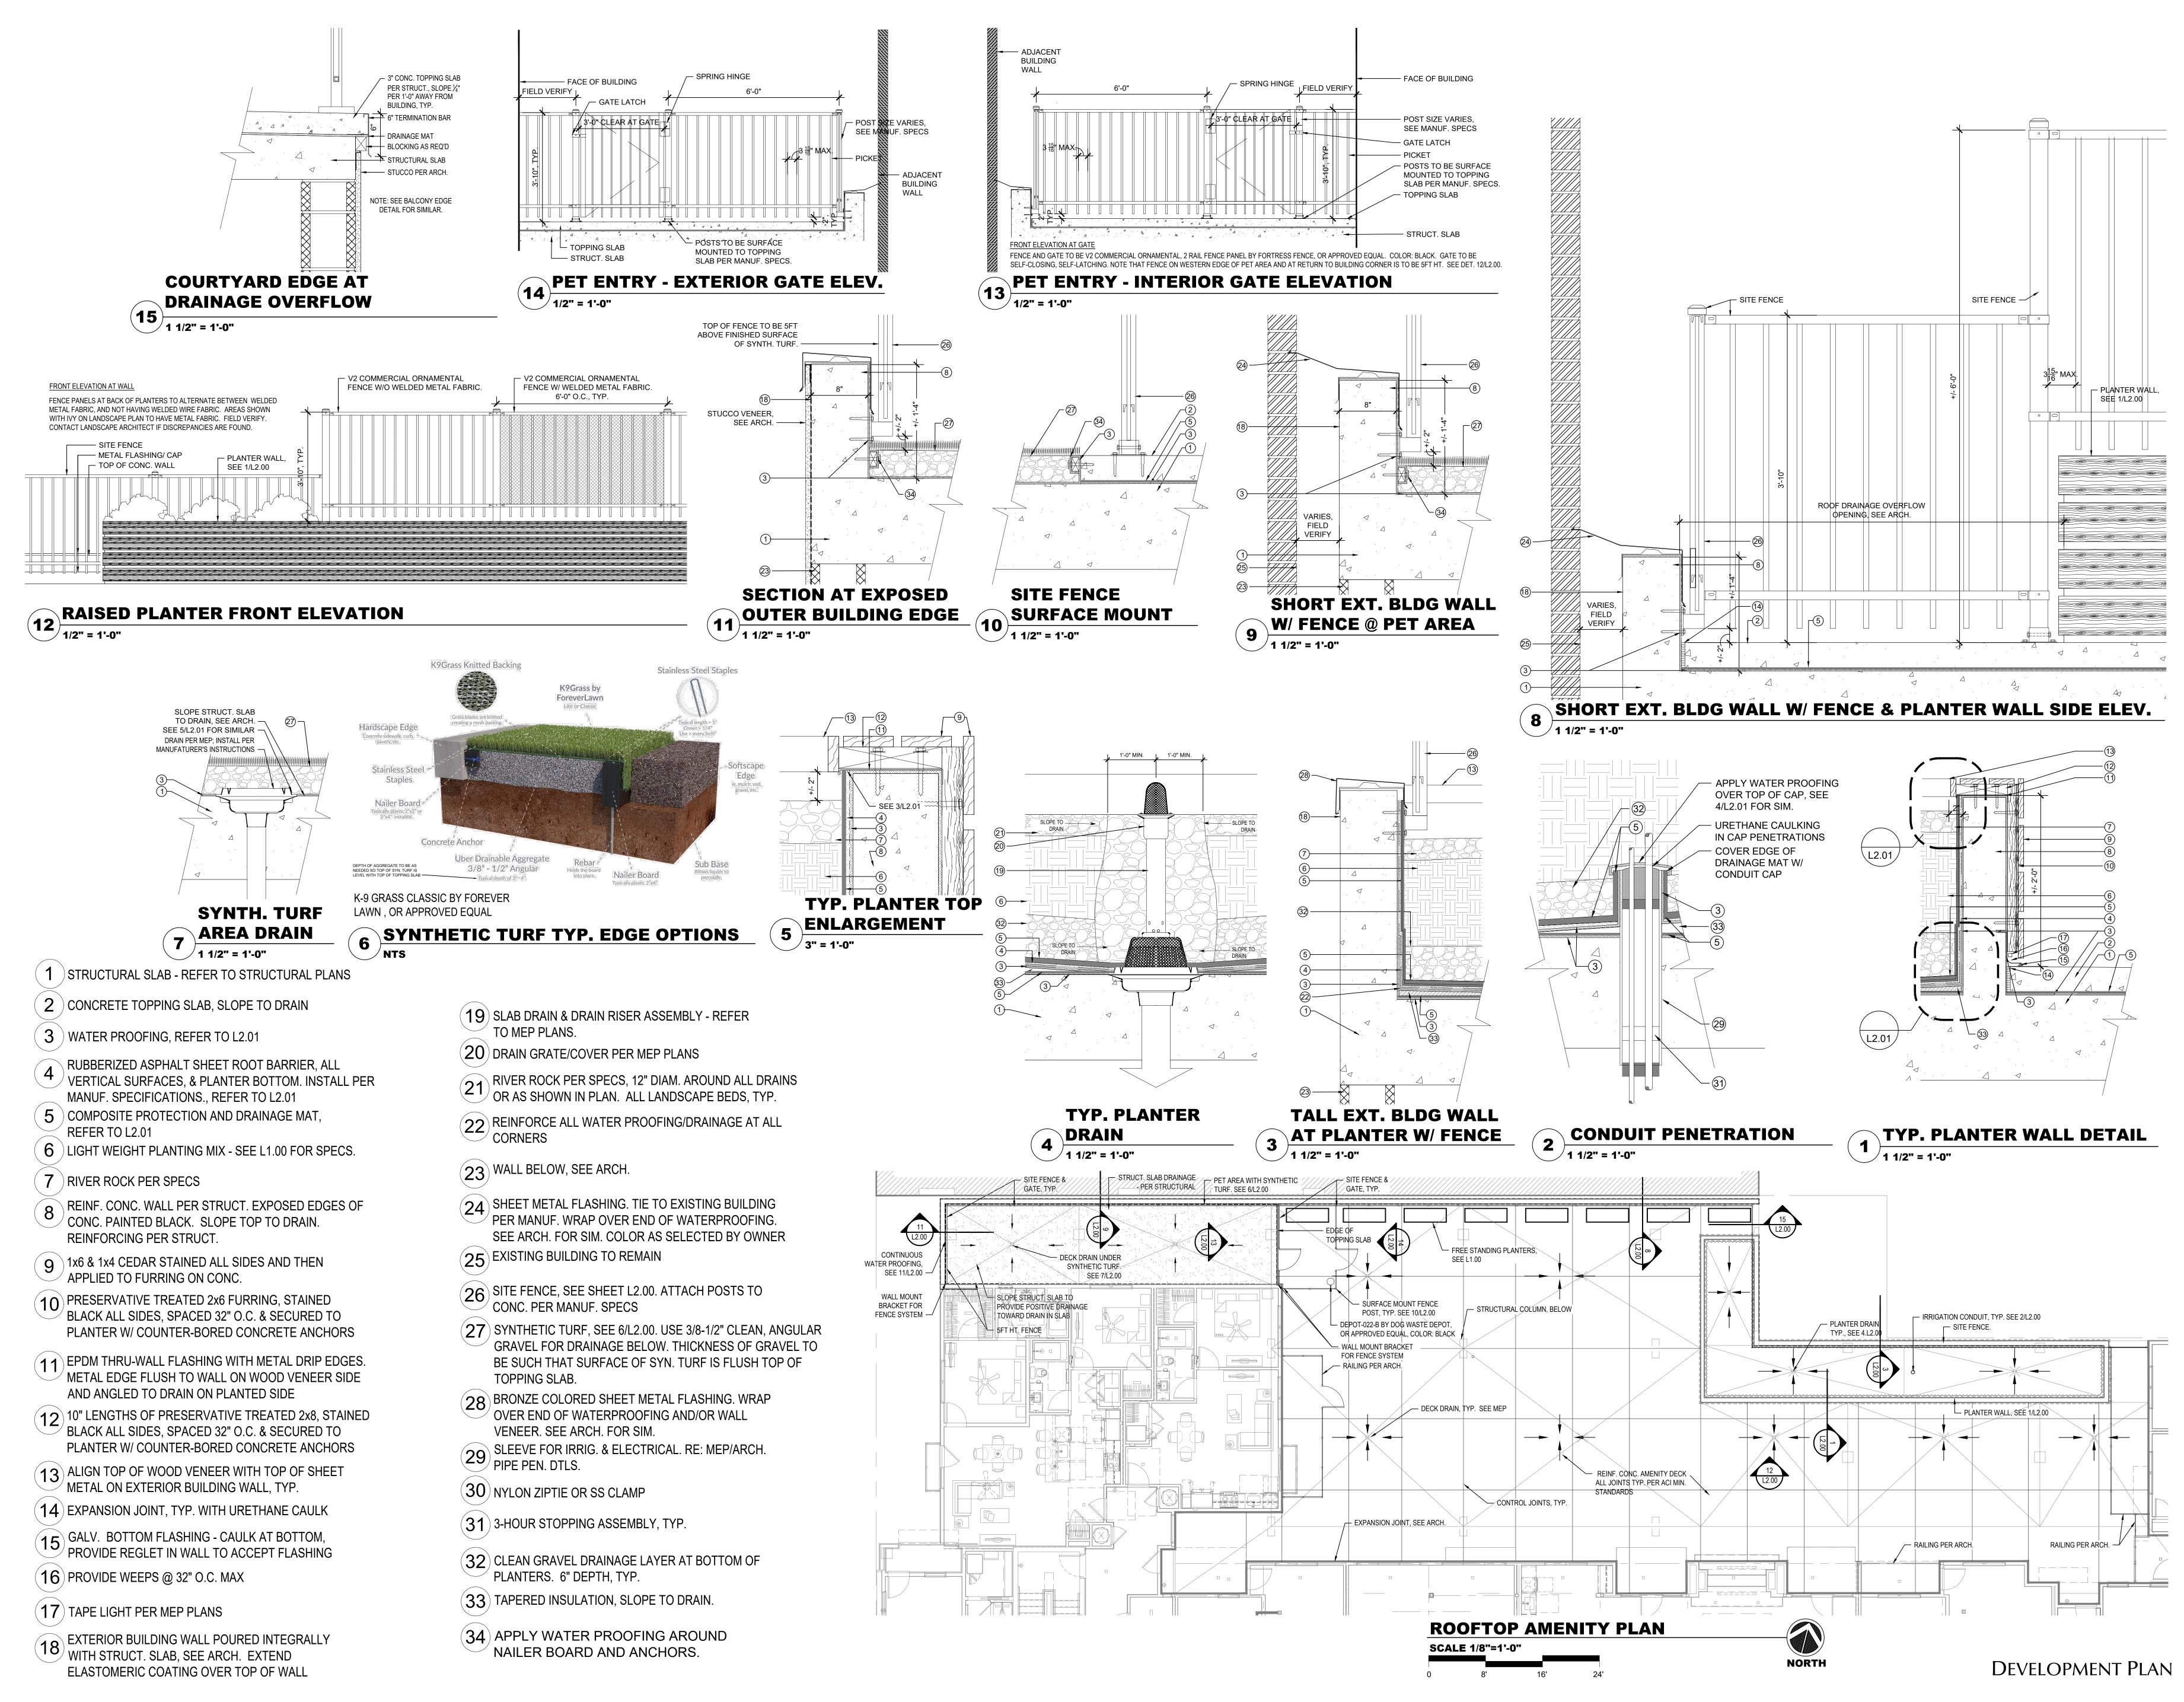






 07.18.2022 - DEVELOPMENT PLAN
 09.02.2022 - DEVELOPMENT PLAN ReSUBMITTAL


REVISIONS

Date 09.02.2022 Job No. 720022 Drawn By: CEE / IA / AAP / NSO/ CPC / BNH SHEET NO.



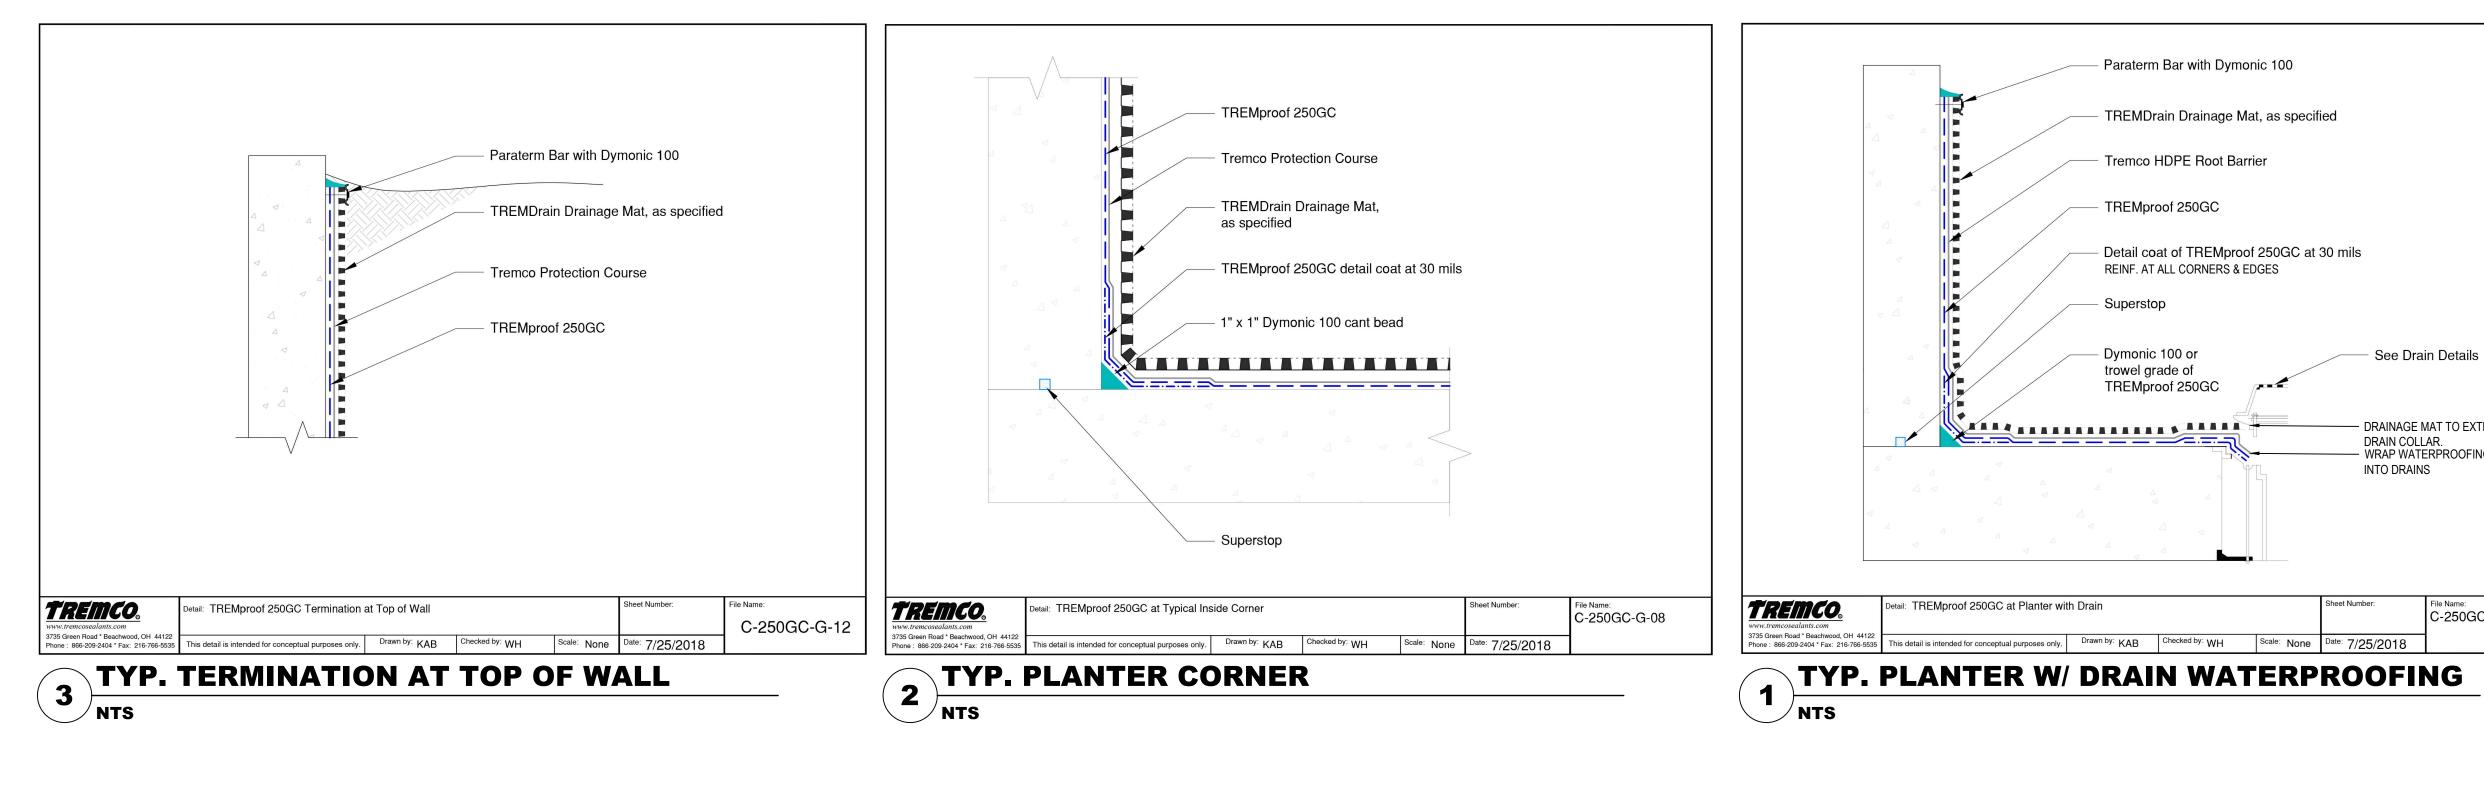



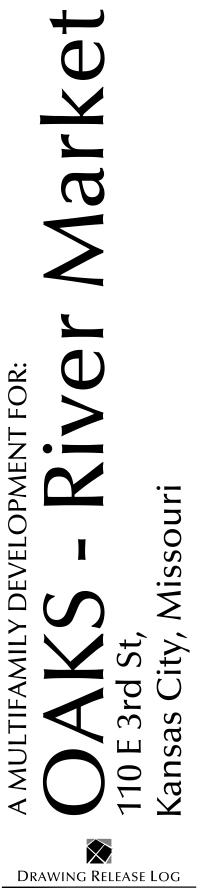

• 07.18.2022 - DEVELOPMENT PLAN ● 09.02.2022 - DEVELOPMENT PLAN ReSUBMITTAL

REVISIONS


DATE 09.02.2022 JOB NO. 720022 DRAWN BY: CEE / IA / BNH SHEET NO. L2.01


- See Drain Details


DRAINAGE MAT TO EXTEND IN TO DRAIN COLLAR.
 WRAP WATERPROOFING INTO DRAINS


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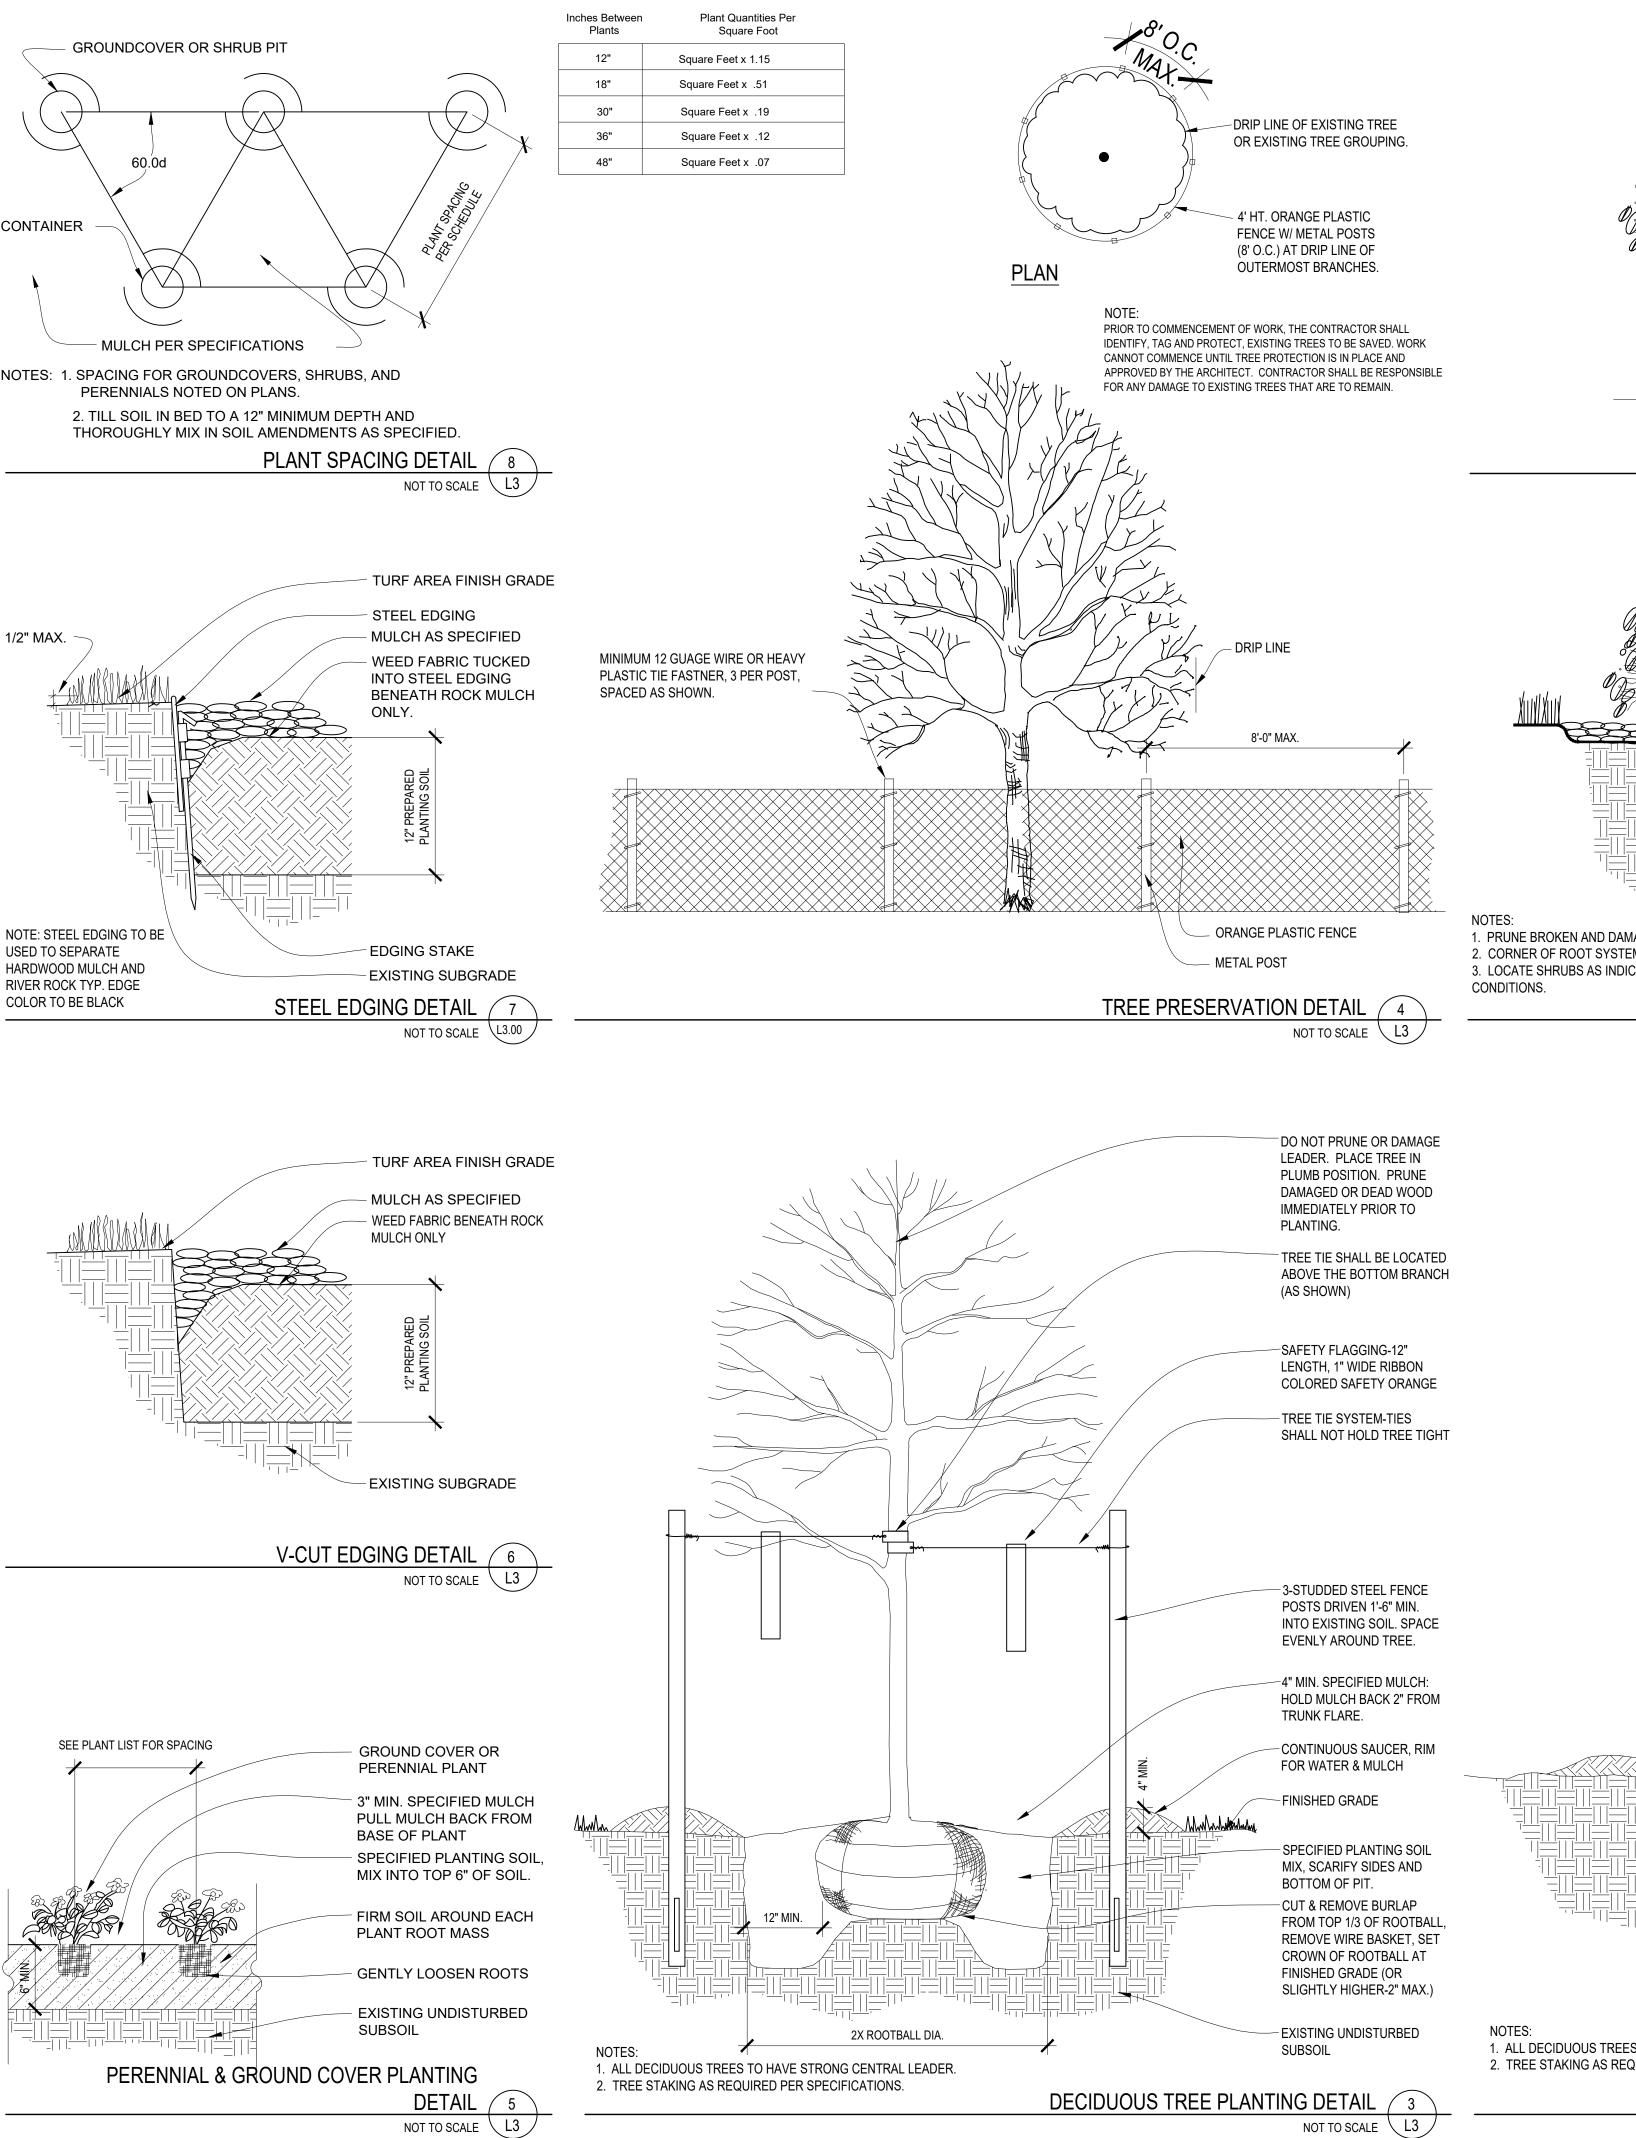
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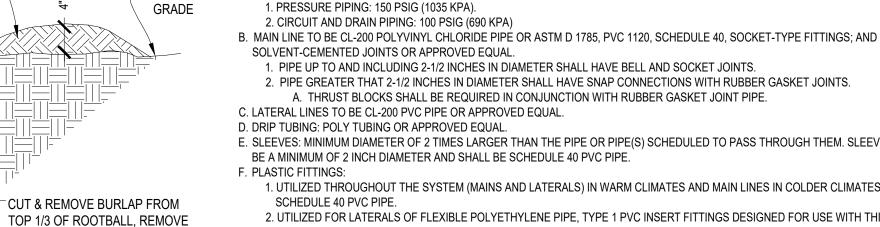




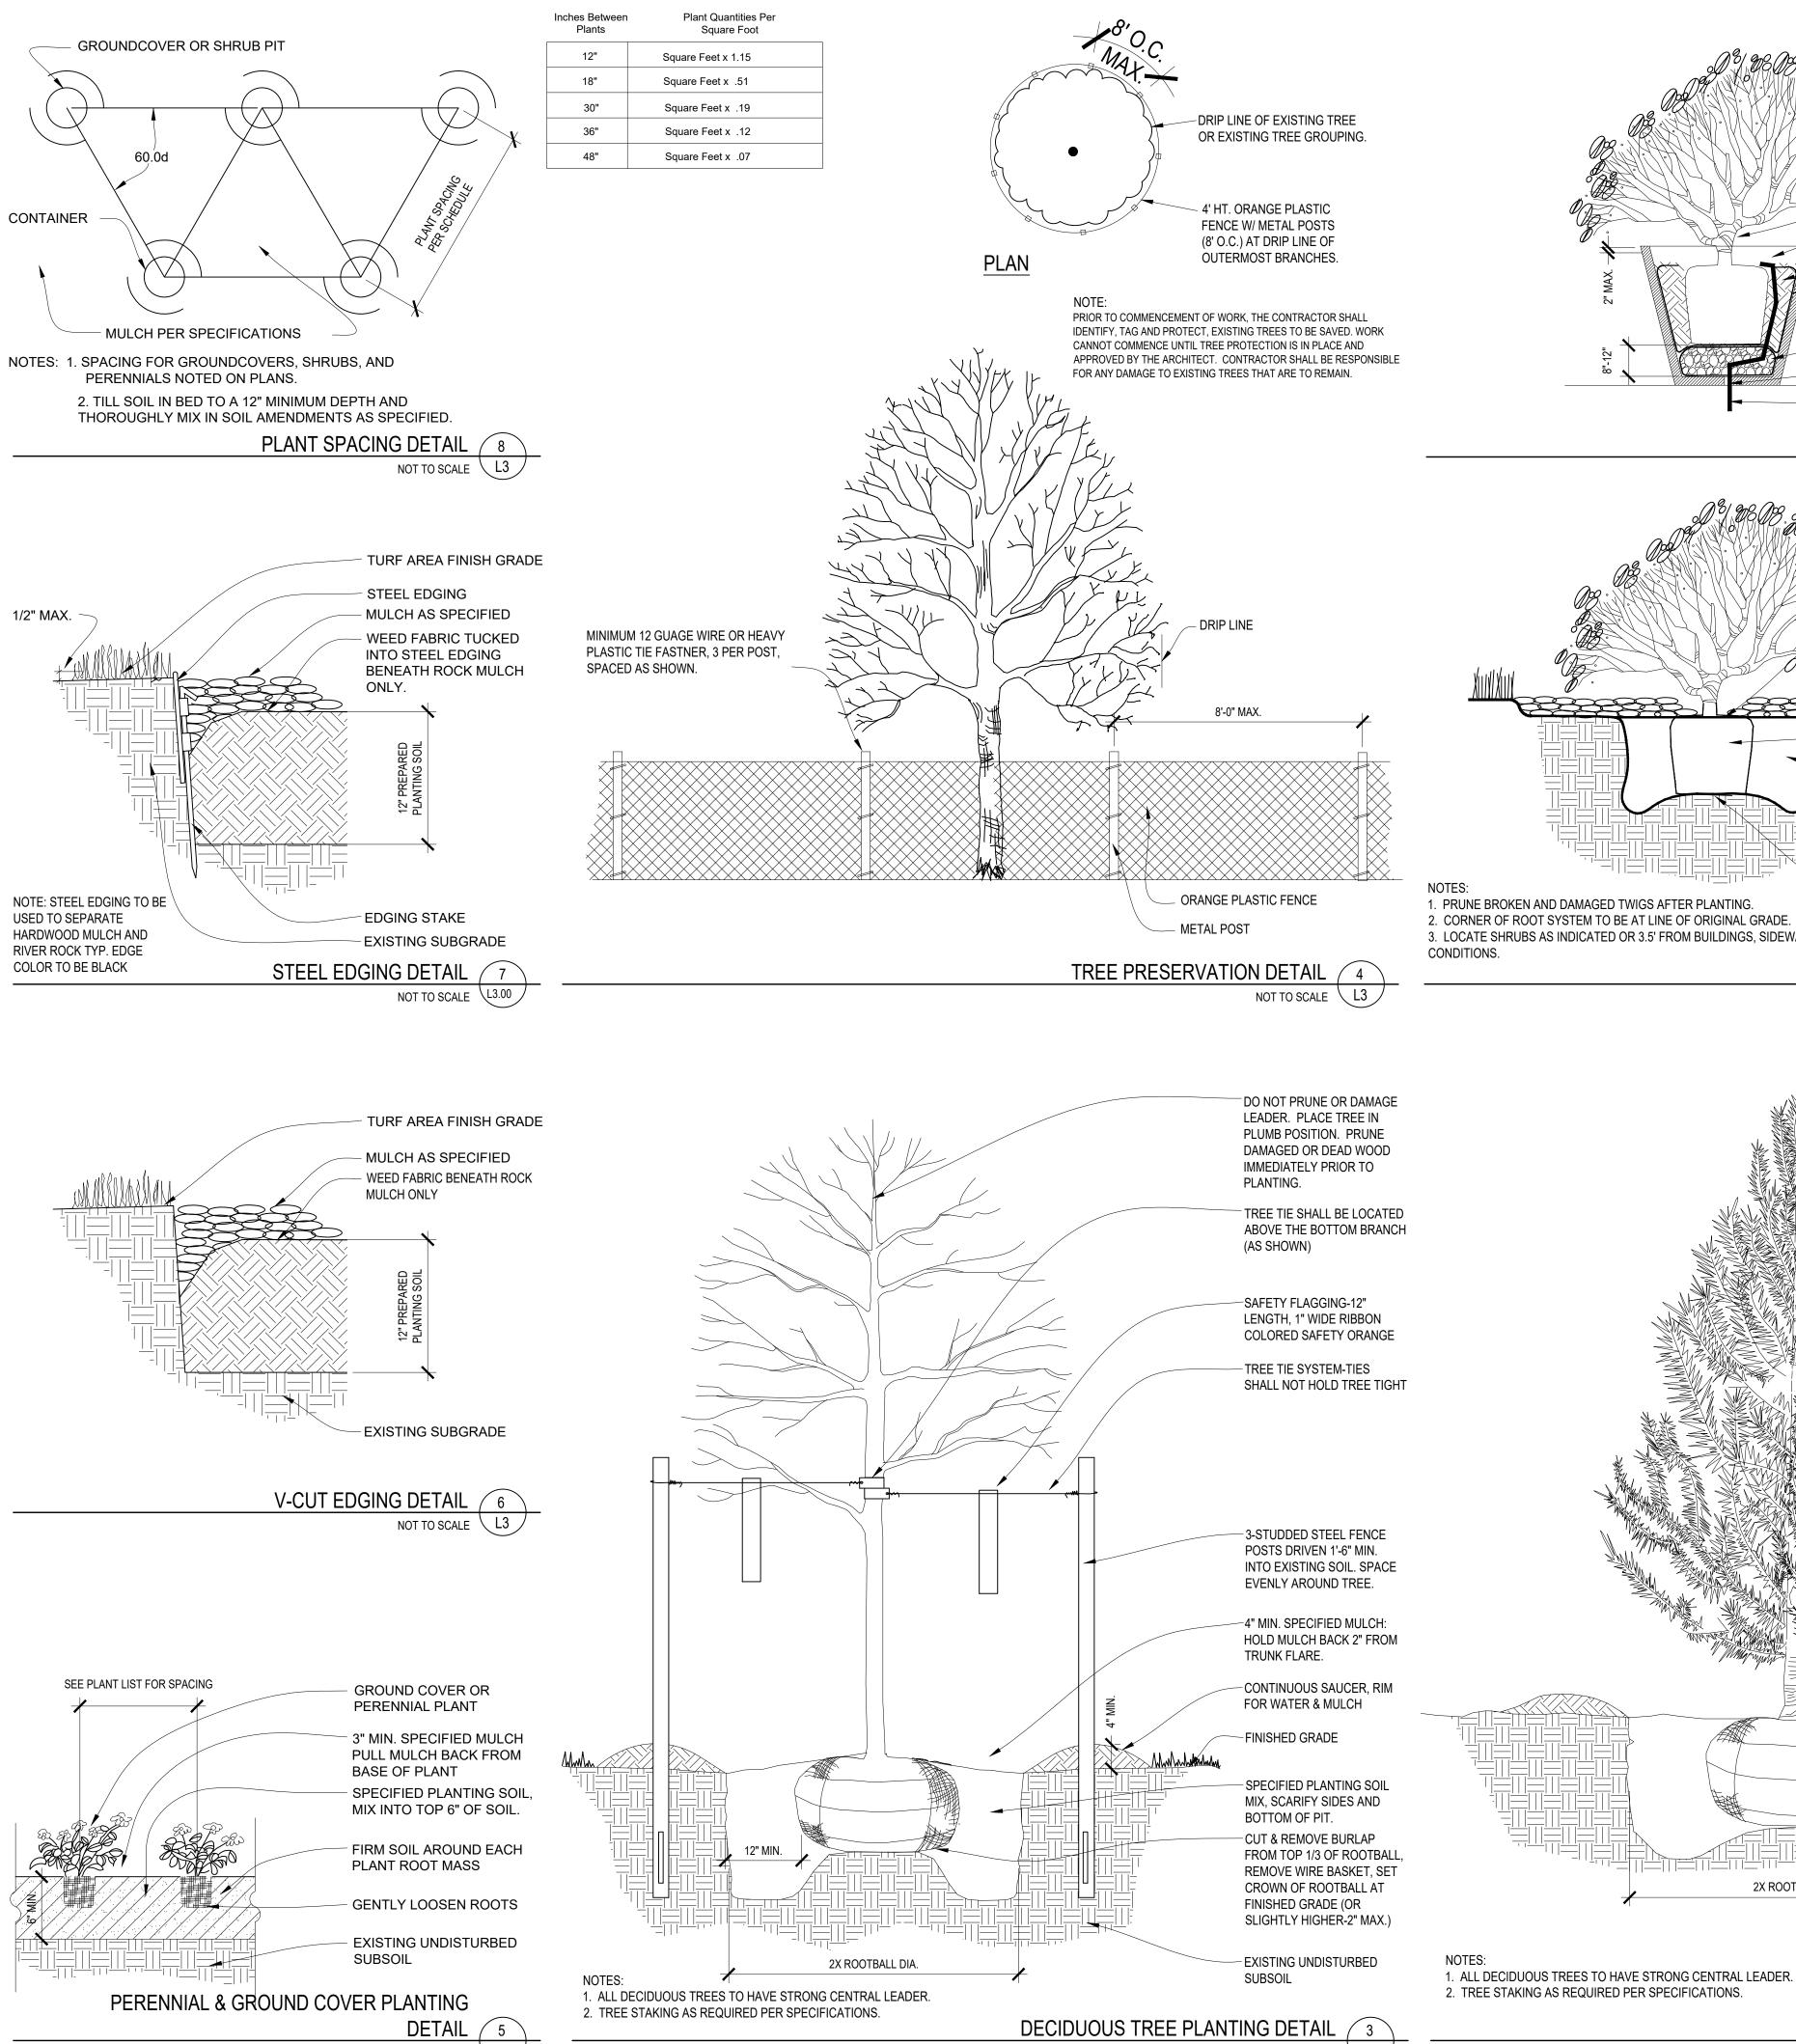

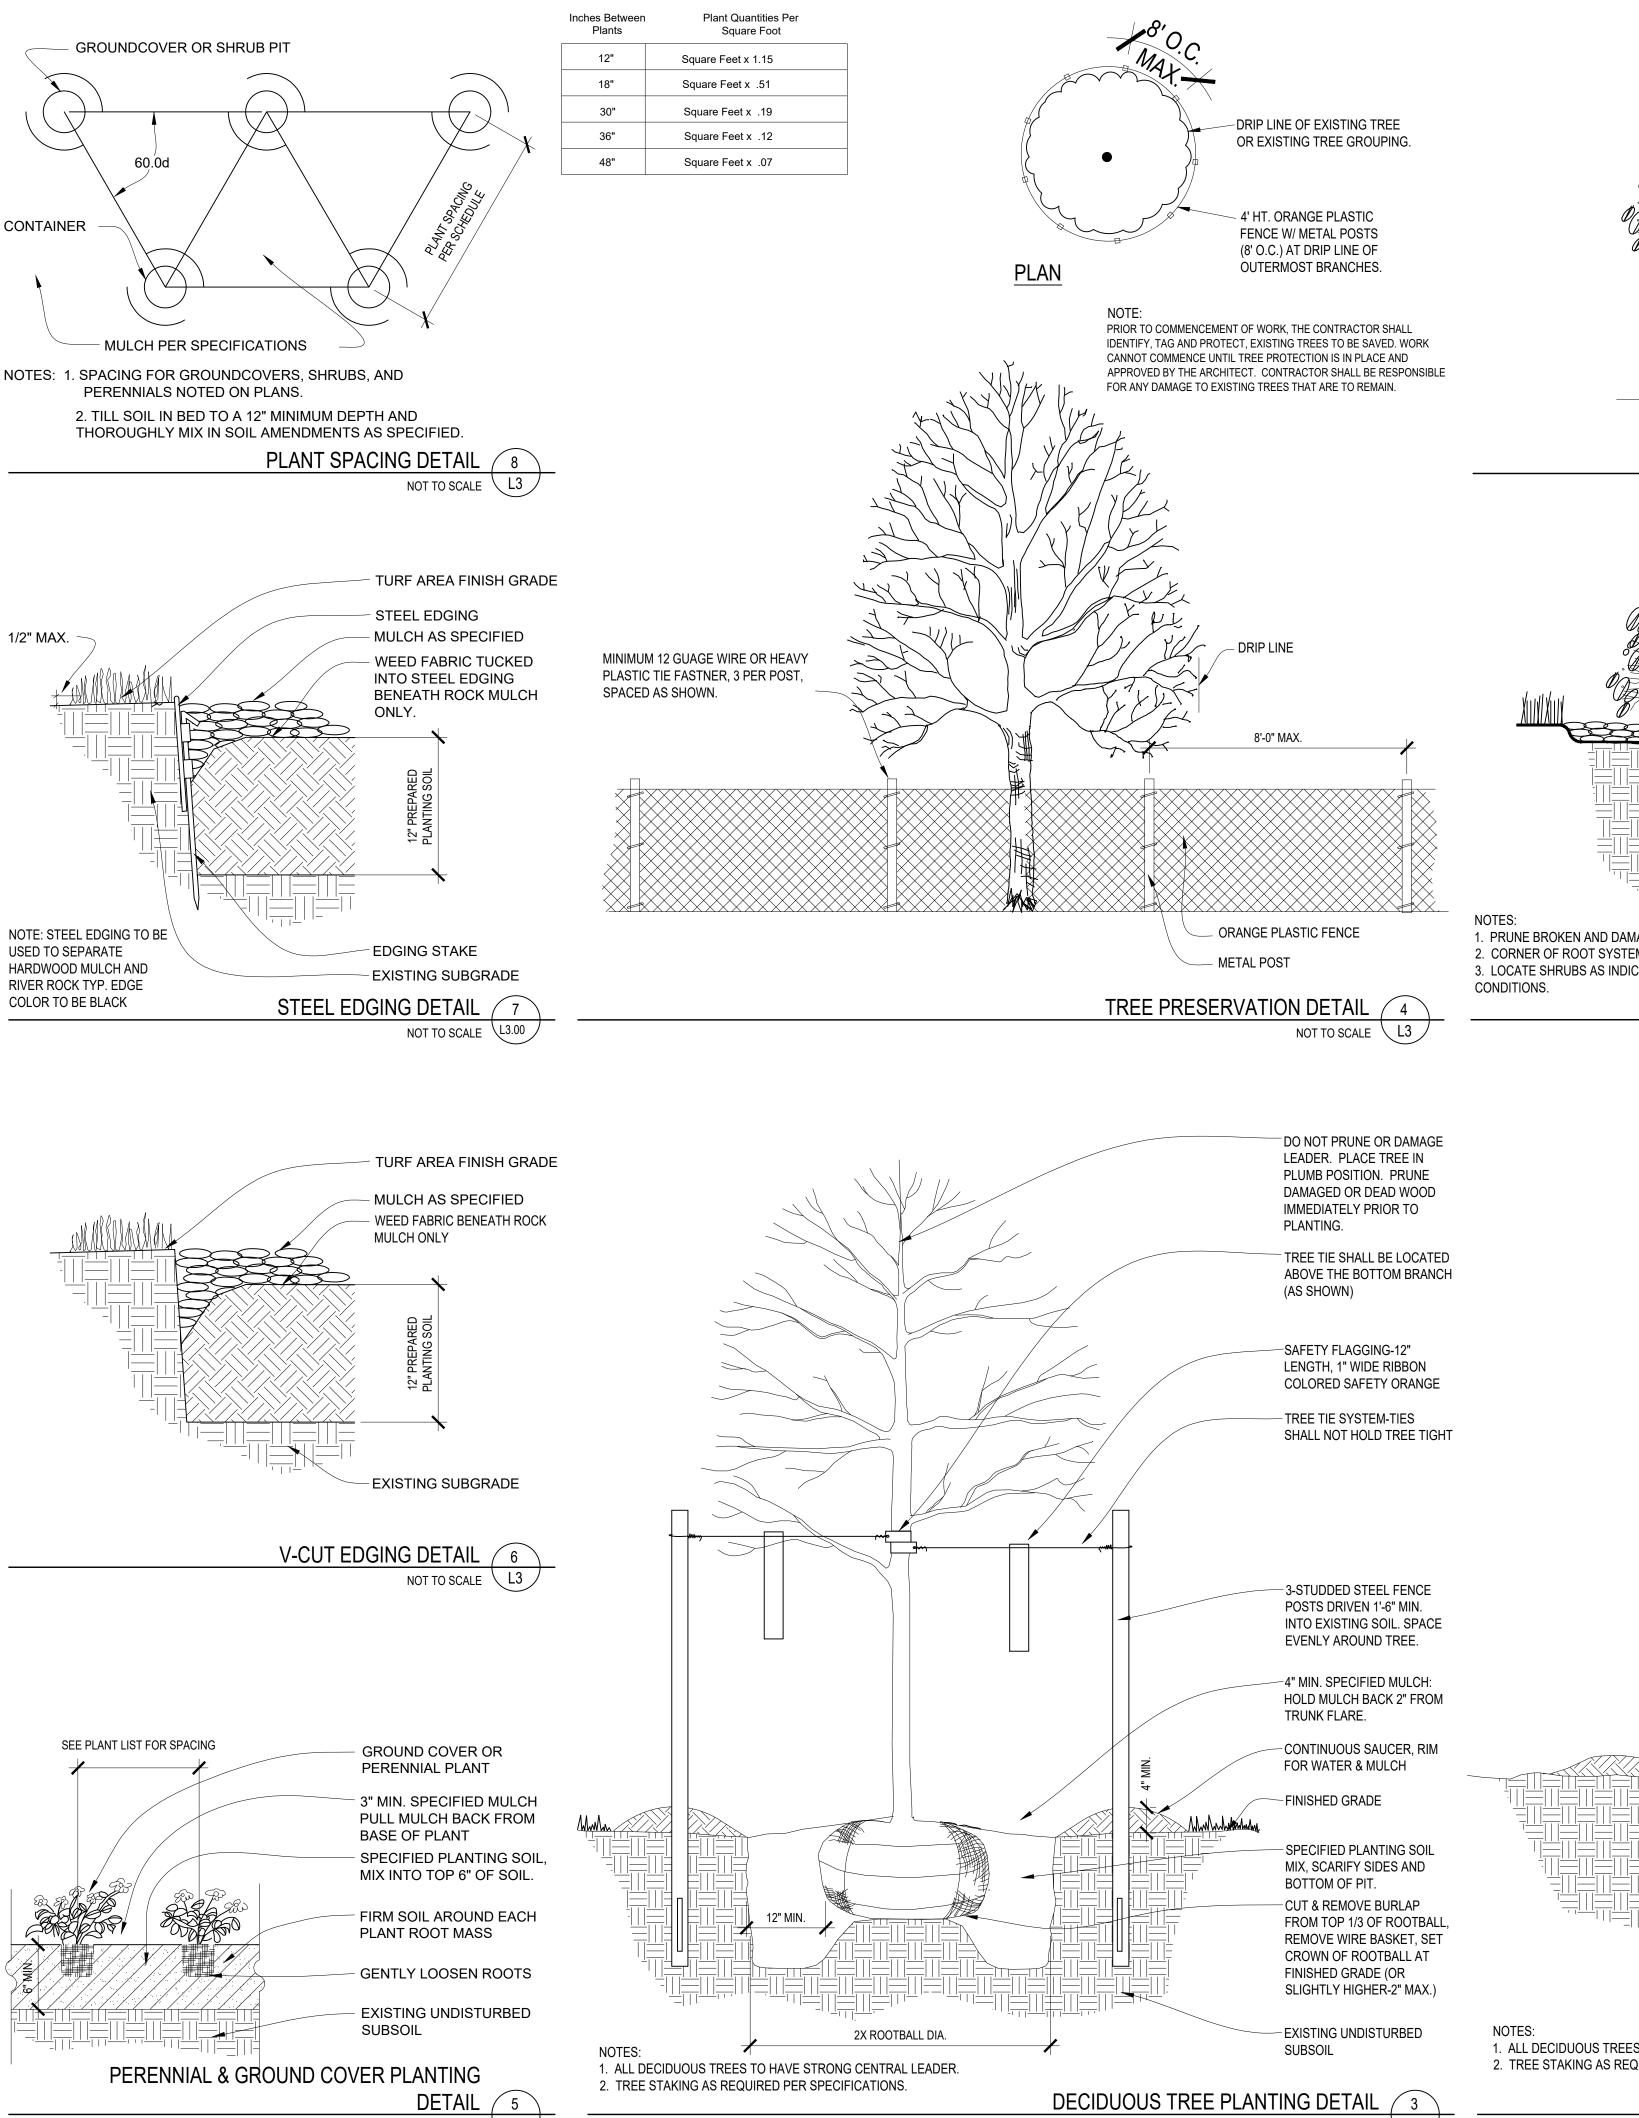

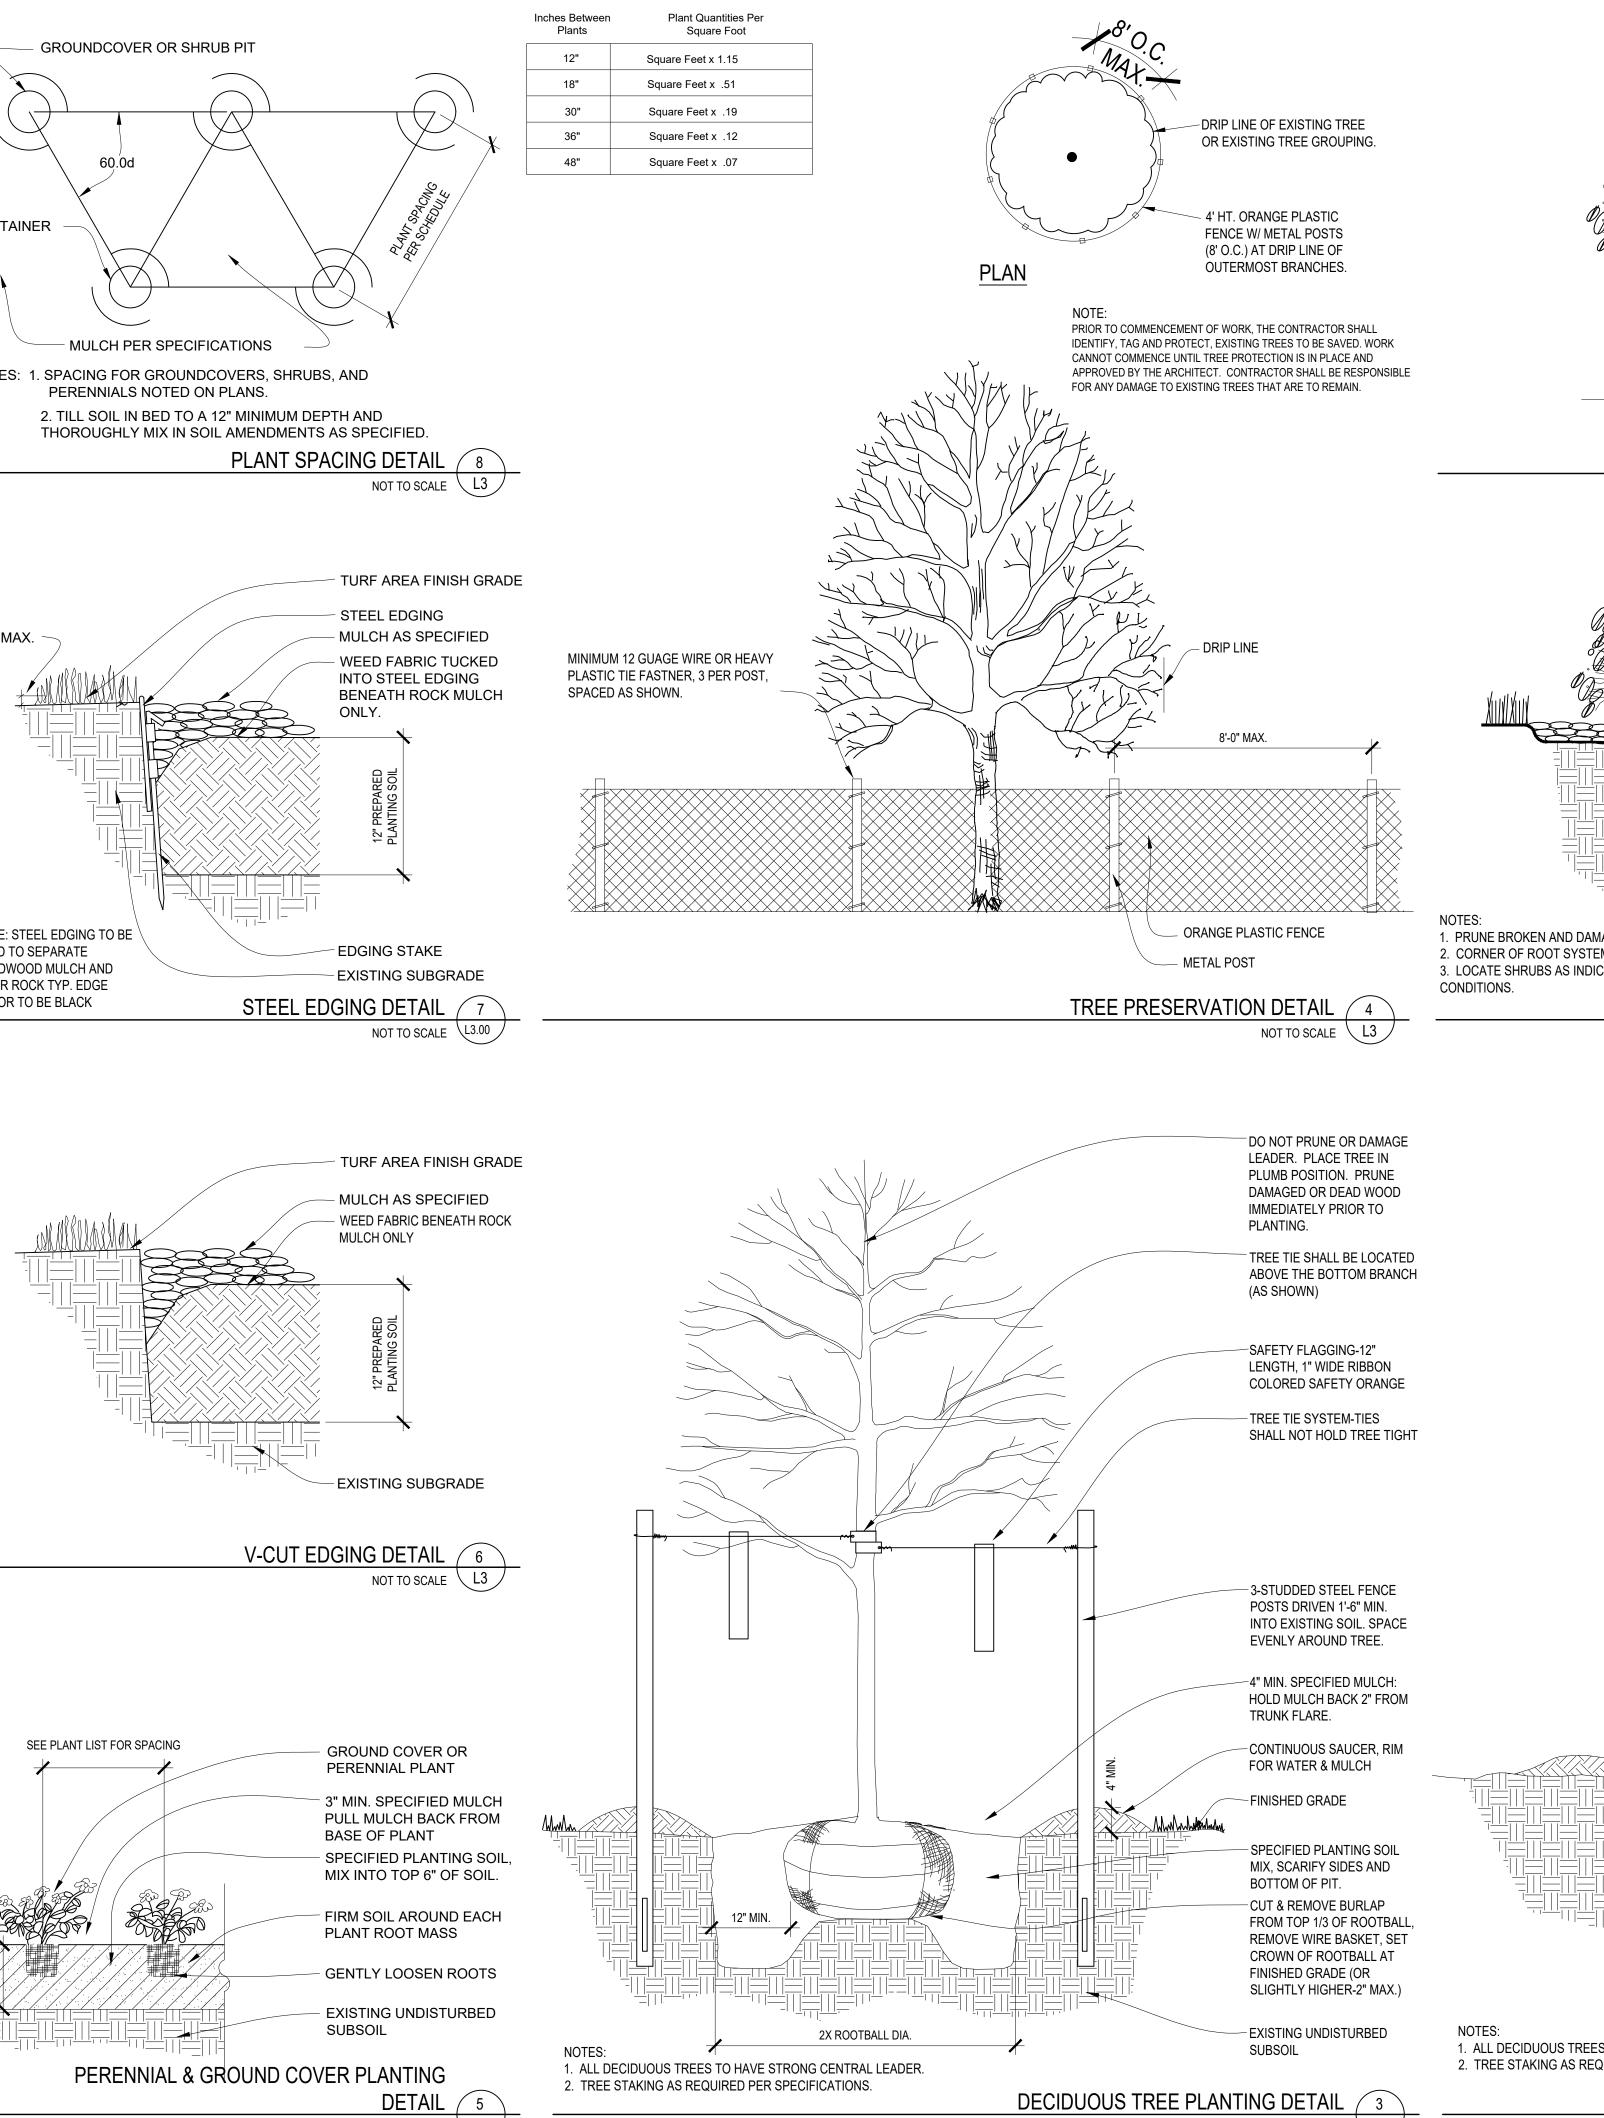

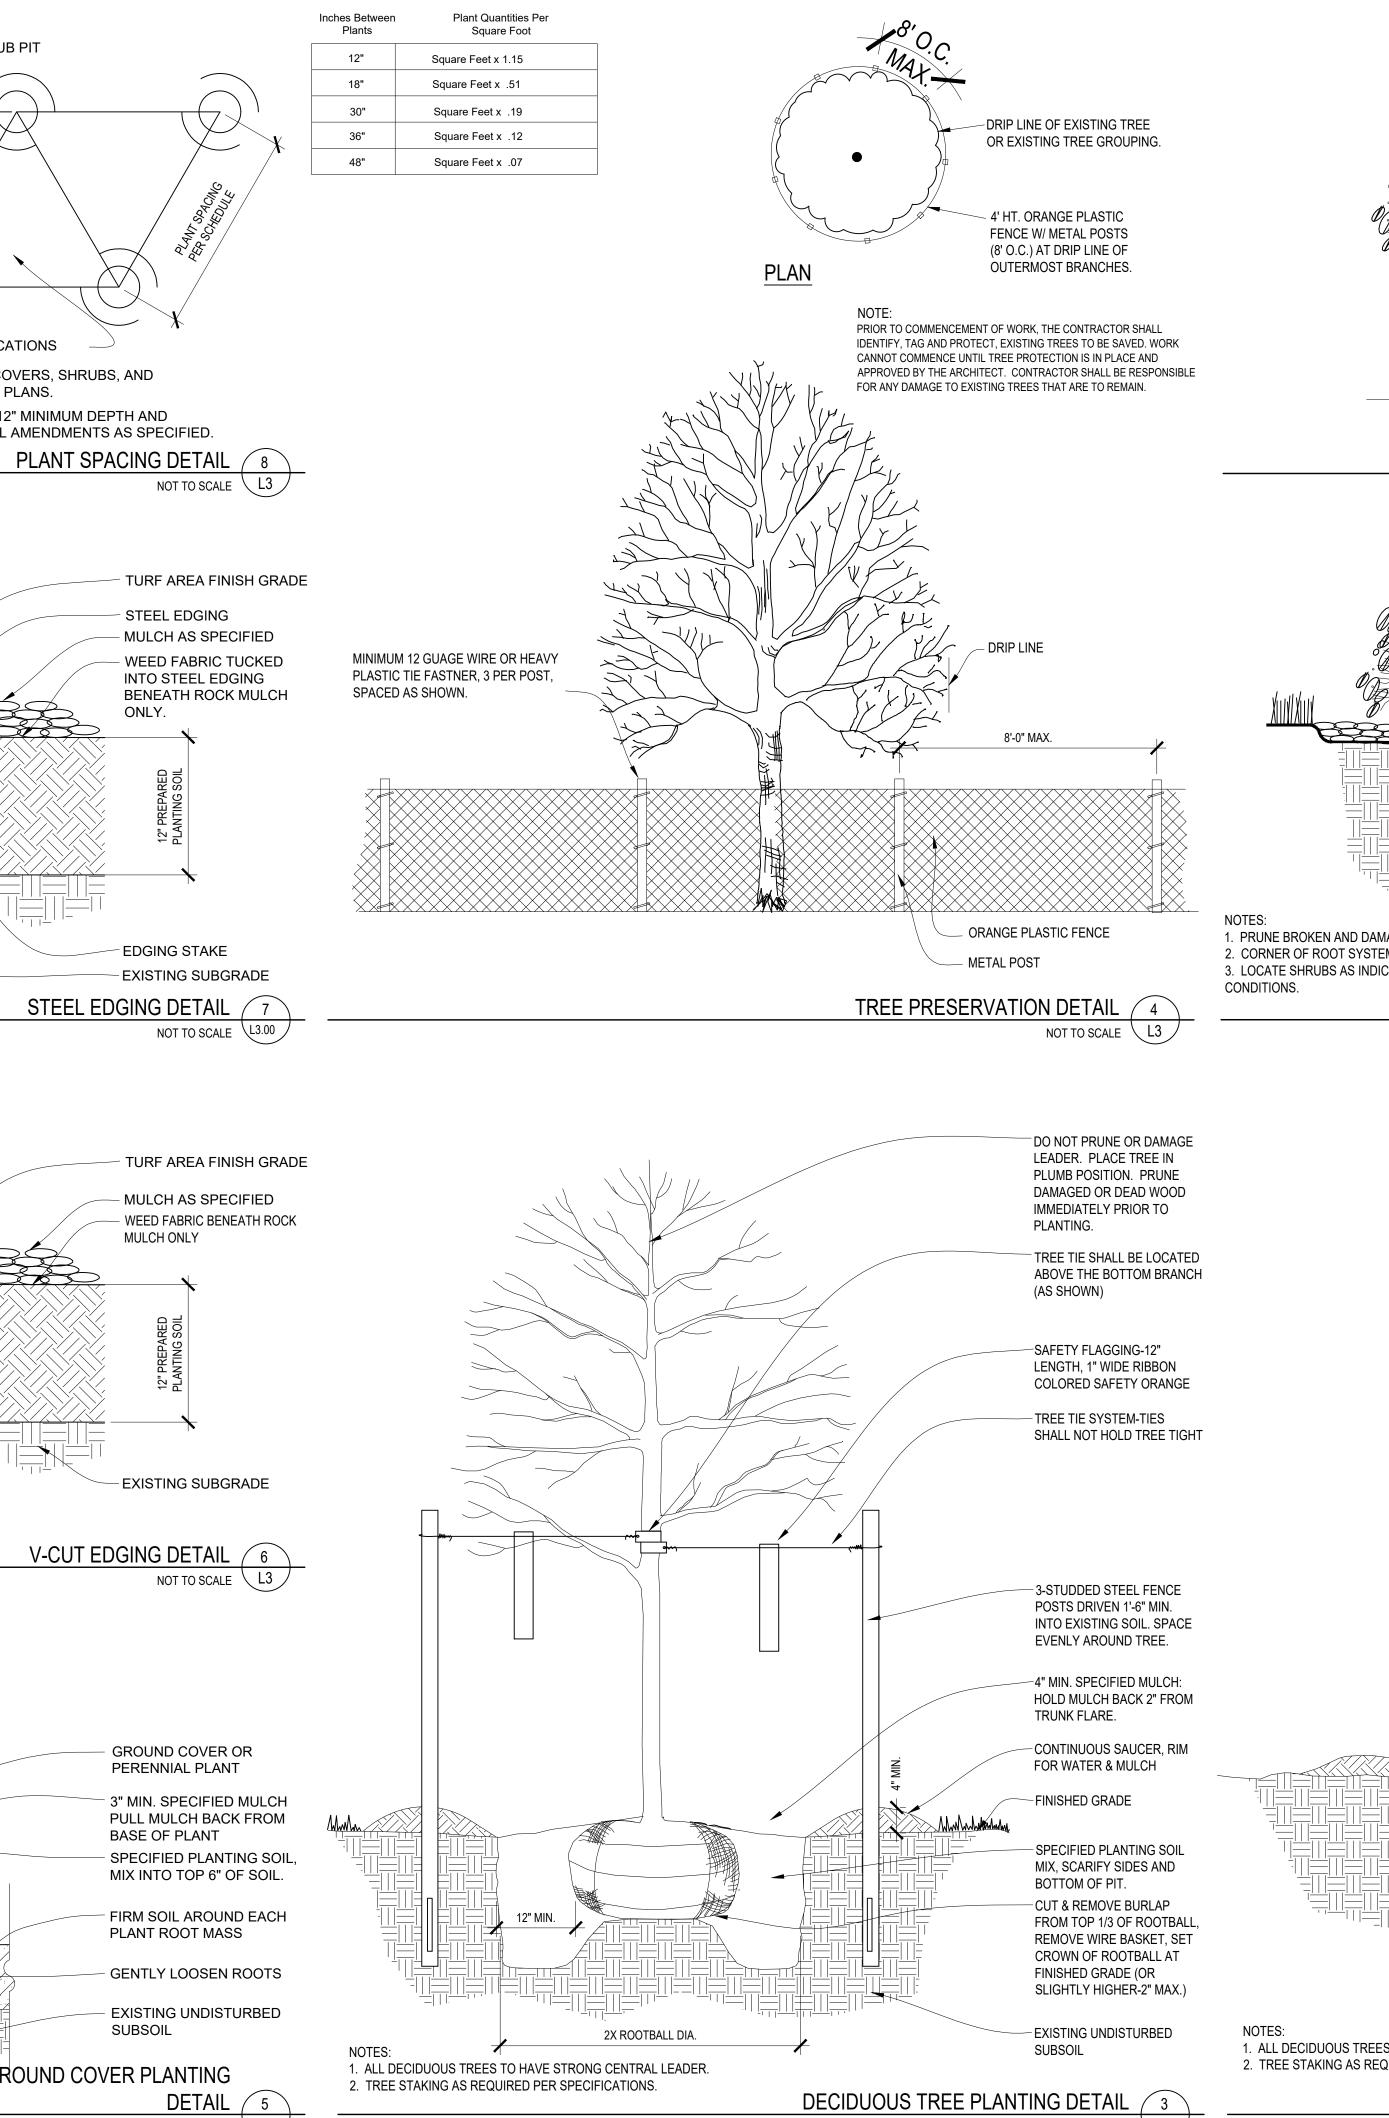

- E. SLEEVES: MINIMUM DIAMETER OF 2 TIMES LARGER THAN THE PIPE OR PIPE(S) SCHEDULED TO PASS THROUGH THEM. SLEEVES SHALL REVISIONS 1. UTILIZED THROUGHOUT THE SYSTEM (MAINS AND LATERALS) IN WARM CLIMATES AND MAIN LINES IN COLDER CLIMATES:
- 2. UTILIZED FOR LATERALS OF FLEXIBLE POLYETHYLENE PIPE, TYPE 1 PVC INSERT FITTINGS DESIGNED FOR USE WITH THIS TYPE OF PIPE CONFORMING TO ASTM D 2609.
- A. PIPE AND FITTINGS SHALL BE JOINED WITH STAINLESS STEEL LOCKING PINCH CLAMPS OR
- STAINLESS STEEL SCREW CLAMPS.
- G. MINIMUM COVER: 1. IN LAWN AND PLANTING AREAS:
  - A. MAINS MINIMUM 18 INCHES BELOW FINISH GRADE.
  - B. LATERALS AND CONTROL VALVES MINIMUM 12 INCHES BELOW FINISH GRADE.
- 2. ROADWAYS OR PARKING AREAS: MINIMUM 24 INCHES BELOW FINISH GRADE. H. CLEARANCES: MINIMUM OF 3-INCHES BETWEEN PARALLEL LINES IN THE SAME TRENCH OR VERTICAL CLEARANCE BETWEEN LINES CROSSING AT ANGLES.

- HOLE FOR DRAINAGE, SEAL TO CONDUIT OR LOCATE OVER DRAIN - DRIP IRRIGATION TYPICAL FREESTANDING PLANTER 2 NOT TO SCALE 13.00-PLANT ROOT BALL AT GRADE WHICH SHRUB WAS GROWN - 3" MIN. SPECIFIED MULCH PULL AWAY FROM BASE OF PLANT - SPECIFIED LANDSCAPE EDGE CONTAINER TO BE REMOVED. (NOTE: AFTER REMOVING POT MAKE 3 VERTICAL SLICES WITH KNIFE IF PLANT IS ROOTBOUND.) SPECIFIED PLANTING SOIL MIX, SCARIFY SIDES AND BOTTOM OF - EXISTING UNDISTURBED SUBSOIL -SET ROOTBALL ON UNDISTURBED SUBGRADE 2. CORNER OF ROOT SYSTEM TO BE AT LINE OF ORIGINAL GRADE. 3. LOCATE SHRUBS AS INDICATED OR 3.5' FROM BUILDINGS, SIDEWALKS, CURBS OR OTHER EDGE SHRUB PLANTING DETAIL NOT TO SCALE 13.00DO NOT PRUNE OR DAMAGE LEADER. PLACE TREE IN PLUMB POSITION. PRUNE DAMAGED OR DEAD WOOD IMMEDIATELY PRIOR TO PLANTING. SPECIFIED PLANTING SOIL MIX, SCARIFY SIDES AND BOTTOM OF PIT. -4" MIN. SPECIFIED MULCH: HOLD MULCH BACK 2" FROM TRUNK FLARE. CONTINUOUS SAUCER, RIM FOR WATER & MULCH -FINISHED

2X ROOTBALL DIA.

- ANNUALS OR PLANTS PER PLAN - MULCH PER SPECS - POTTED PLANTS PLANTING SOIL DOUBLE LINE POT WITH FILTER FABRIC - PLANTER PER SPECIFICATIONS - CLEAN GRAVEL WRAPPED IN FILTER

FABRIC

- PROPOSED WORK. THE PLANTING PLAN GRAPHICALLY ILLUSTRATES OVERALL PLANT MASSING. EACH PLANT SPECIES MASSING SHALL BE PLACED IN THE FIELD TO UTILIZE GREATEST COVERAGE OF GROUND PLANE. THE FOLLOWING APPLIES FOR INDIVIDUAL PLANTINGS: CREEPING GROUNDCOVER SHALL BE A MINIMUM OF 6" FROM PAVING EDGE. ALL TREES SHALL BE A MINIMUM OF 3' FROM PAVING EDGE.

LANDSCAPE ARCHITECT.

ACCEPTANCE.

GUARANTEE BEGINS.

NURSERYMEN STANDARDS.

PRUNED TO UNIFORMITY.

MIN. DEPTH.

50 POUNDS PER 2,000 SQUARE FEET.

IRRIGATION PERFORMANCE SPECIFICATIONS:

BEEN ACCEPTED AND APPROVED.

A. MINIMUM WORKING PRESSURE RATINGS:

PIPING SPECIFICATIONS:

CUT & REMOVE BURLAP FROM

WIRE BASKET, SET CROWN OF

ROOTBALL AT FINISHED GRADE

(OR SLIGHTLY HIGHER-2" MAX.)

NOT TO SCALE  $\setminus$  L3 /

- EXISTING UNDISTURBED SUBSOIL

EVERGREEN TREE PLANTING DETAIL

MULCH APPLICATION.

INSTALLATION:

AVOIDED.

PRODUCTS AND FREE OF ALL FOREIGN SUBSTANCES.

TYE" A TIE WITH TAPERED BEADS THAT SNAP LOCK BY A.M. LEONARD AND SONS.

18. ALL NEW PLANT BED AREAS TO BE IRRIGATED. REFER TO SPECIFICATIONS.

CLAY LUMPS, STONES, STUMPS, ROOTS OR SUBSTANCE 2" OR MORE IN DIAMETER.

BACKFILL V-CUT EDGE WITH SHREDDED HARDWOOD MULCH TO GRADE.

MATERIALS:

TO GIVE SUCH NOTIFICATION.

ACCOMPLISH SITE CONSTRUCTION OPERATIONS.

GENERAL NOTES: EACH BIDDER SHALL VISIT THE SITE OF THE PROPOSED WORK AND EXAMINE THE SITE CONDITIONS. HE SHALL ALSO CAREFULLY EXAMINE THE DRAWINGS FOR THE PROPOSED WORK AND FAMILIARIZE HIMSELF WITH ALL CONDITIONS, WHICH MAY AFFECT THE

ALL SHRUBS SHALL BE A MINIMUM OF 2' FROM PAVED EDGE.

SUMMARY ONLY. VERIFY ALL PLANT QUANTITIES PRIOR TO BIDDING.

O BE FULLY RESPONSIBLE FOR ANY AND ALL DAMAGES WHICH MIGHT BE (

EXACTLY LOCATE AND PRESERVE ANY AND ALL UNDERGROUND UTILITIES.


LOCATIONS FOR APPROVAL BY LANDSCAPE ARCHITECT PRIOR TO INSTALLATION.

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DRAWING RELEASE LOG 07.18.2022 - DEVELOPMENT PLAN ● 09.02.2022 - DEVELOPMENT PLAN ReSUBMITTAL

- ALL PLANTS OF THE SAME SPECIES SHALL BE EQUALLY SPACED APART AND PLACED FOR BEST AESTHETIC VIEWING.
- NOTIFY LANDSCAPE ARCHITECT 1 WEEK PRIOR TO ANTICIPATED START OF PLANT MATERIAL INSTALLATION. LANDSCAPE CONTRACTOR SHALL STAKE ALL PROPOSED PLANTING BED EDGES, SET OUT SHRUBS IN INTENDED LOCATIONS, AND STAKE TREE
- 4. LANDSCAPE ARCHITECT RESERVES THE RIGHT TO REJECT ANY AND ALL PLANT MATERIALS PROPOSED FOR USE ON THE PROJECT. CONTRACTOR WILL BE RESPONSIBLE FOR PLANTING ALL PLANT MATERIAL INDICATED ON THE PLANS. PLANT SCHEDULE IS FOR
- CONTRACTOR WILL BE RESPONSIBLE FOR REMOVAL OF EXISTING TREES & PLANT MATERIAL AS INDICATED ON PLAN AND AS DIRECTED BY LANDSCAPE ARCHITECT. RELOCATE PERENNIALS & SHRUBS TO LOCATION INDICATED ON PLAN AND AS DIRECTED BY
- REPORT ANY DISCREPANCIES FOUND WITH REGARD TO EXISTING CONDITIONS OR PROPOSED DESIGN IMMEDIATELY TO THE LANDSCAPE ARCHITECT. DO NOT WILLFULLY PROCEED WITH CONSTRUCTION AS DESIGNED WHERE IT IS FOUND THAT KNOWN DISCREPANCIES EXIST. THE CONTRACTOR SHALL ASSUME FULL RESPONSIBILITY FOR ALL NECESSARY REVISIONS DUE TO FAILURE
- THE CONTRACTOR SHALL BE RESPONSIBLE FOR ANY COORDINATION WITH OTHER RELATED SITE WORK BEING PERFORMED TO
- 9. THE CONTRACTOR SHALL DETERMINE THE EXACT LOCATION OF ALL EXISTING UTILITIES BEFORE COMMENCING WORK, AND AGREES ONED BY THE CONTRACTOR'S FAILURE TO
- 10. PLANT MATERIAL SHALL BE MAINTAINED AND GUARANTEED FOR A PERIOD OF ONE YEAR AFTER OWNER'S ACCEPTANCE OF FINISHED JOB. ALL DEAD OR DAMAGED PLANT MATERIAL SHALL BE REPLACED AT LANDSCAPE CONTRACTOR'S EXPENSE PRIOR TO
- 11. THE PROJECT MAY BE AWARDED COMPLETION IN PHASES BUT IT IS THE RESPONSIBILITY OF THE CONTRACTOR TO NOTIFY THE OWNER & LANDSCAPE ARCHITECT WHEN A PHASE IS COMPLETE & A FINAL WALK THROUGH CAN TAKE PLACE. CONTRACTOR SHALL IDENTIFY ON THE PLANS THE LIMITS OF COMPLETED WORK AND/OR PHASES PRIOR TO THE WALK THROUGH. 12. LANDSCAPE CONTRACTOR SHALL MAINTAIN ALL PLANT MATERIAL UNTIL FINAL ACCEPTANCE, AT WHICH POINT THE ONE YEAR
- 13. PLANT MATERIAL SHALL BE HEALTHY, VIGOROUS, AND FREE OF DISEASE AND INSECTS AS PER AMERICAN ASSOCIATION OF
- 14. PLANT MATERIAL SHALL NOT BE PRUNED PRIOR TO INSTALLATION. AFTER PLANTS HAVE BEEN INSTALLED, EACH PLANT SHALL BE
- 15. SHREDDED BARK MULCH SHALL BE FINELY CHIPPED AND SHREDDED DARK BROWN HARDWOOD CHIPS CONSISTING OF PURE WOOD
- 16. CONTRACTOR SHALL USE AN APPROVED TREE TIE SYSTEM THAT IS EASILY ADJUSTABLE, STRONG IN ALL WEATHER, AND EASILY ATTACHED AND REMOVED. HOSE AND WIRE ARE NOT ACCEPTABLE FOR STAKED TREES. PROVIDE THE FOLLOWING OR APPROVED EQUAL: "CINCH TIES" BY J. LICHTENTHALER, "ADJ-A-TYPE" BY HEAVYWEIGHT ONLY, A PLASTIC CHAIN TWIST TIE, OR "PLASTIC BINDER
- SOD SHALL BE CERTIFIED TURFGRASS SOD COMPLYING WITH ASPA SPECIFICATIONS FOR MACHINE-CUT THICKNESS, SIZE, STRENGTH, MOISTURE CONTENT, AND MOWED HEIGHT, AND FREE OF WEEDS AND UNDESIRABLE NATIVE GRASSES. SOD SHALL BE A BLEND OF NOT LESS THAN 3 IMPROVED KENTUCKY BLUEGRASS (POSPARATENSIS) VARIETIES, A NATIVE MIXTURE OF HOUNDOG, REBEL, OR FALCON, FINE LEAFED TALL FESCUE (FESTUCA ARUNDINACEA), AND RYE (LOLIUM JULTIFLORUM AND PERENE DOMESTIC). IT SHALL BE A MIX OF 20% KENTUCKY BLUEGRASS, 70% FINELEAFED TALL FESCUE, AND 10% RYE. SOD SHALL BE WELL ROOTED, 2 YEAR OLD STOCK, HARVESTED IN ROLLS, FERTILIZED 2-3 WEEKS PRIOR TO CUTTING. ALL SOD SHALL BE MACHINE CUT AND VIGOROUSLY GROWING (NOT DORMANT). MAXIMUM TIME FROM STRIPPING TO PLANTING SHALL BE 24 HOURS.
- 19. ROCK BEDS SHALL BE MEXICAN BEACH PEBBLES, OR APPROVED EQUAL. ALL ROCK BED AREAS SHALL HAVE FILTER FABRIC & BE 4"
- 20. ALL PLANTING BEDS SHALL BE AMENDED WITH 1 CUBIC YARD OF COTTON BOL COMPOST PER 1,000 SQUARE FEET. TILL COTTON BOL INTO SOIL TO A 6" DEPTH. A 10-10-10 FERTILIZER SHALL BE SPREAD OVER ALL PLANTING AREAS PRIOR TO PLANTING, AT A RATE OF
- 21. AFTER PLANTS HAVE BEEN INSTALLED, ALL PLANTING BEDS SHALL BE TREATED WITH DACTHAL PRE-EMERGENT HERBICIDE PRIOR TO
- 22. PLANT PIT BACKFILL FOR TREES AND SHRUBS SHALL BE 25% COTTON BOLL COMPOST, AND 25% TOPSOIL, AND 50% EXISTING SOIL. TOPSOIL SHALL BE NATURAL FERTILE, FRIABLE SOIL POSSESSING CHARACTERISTICS OF REPRESENTATIVE PRODUCTIVE SOILS IN THE AREA. SOIL SHALL NOT BE EXCESSIVELY ACID, ALKALINE OR TOXIC THAT MAY BE HARMFUL TO PLANT GROWTH. ALSO, FREE OF
- 23. PLANTED BED EDGES SHALL BE IN STRAIGHT LINES OR GENTLE FLOWING CURVES. SUDDEN CURVES OR SHARP ANGLES SHOULD BE
- 24. V-CUT EDGE SHALL BE DUG TO 6" DEPTH WITH ANGLED EDGE ON LANDSCAPE BED SIDE, AND VERTICAL EDGE ON TURF SIDE.
- 25. MULCH ALL PLANTING BED AREAS TO A MINIMUM DEPTH OF 3". MULCH INDIVIDUAL TREES TO A MINIMUM DEPTH OF 4".
- PROVIDE 100% COVERAGE COMPLETE WORKING IRRIGATION SYSTEM FOR THE NEW SOD & PLANTING BEDS AREAS. INCLUDE ELECTRICAL CONNECTION AND IRRIGATION SLEEVES AS NECESSARY. DRIP IRRIGATE ALL PLANTING BEDS. PRIOR TO INSTALLATION, PROVIDE PLAN SHOWING ALL IRRIGATION MATERIALS INCLUDING ALL EQUIPMENT SIZES AND DETAILS TO LANDSCAPE ARCHITECT FOR APPROVAL. COMPLY WITH REQUIREMENTS OF AUTHORITY WITH JURISDICTION FOR IRRIGATION SYSTEMS & BACKFLOW PREVENTOR. CONTRACTOR SHALL SUBMIT AS-BUILT DRAWINGS TO LANDSCAPE ARCHITECT & OWNER AFTER FINAL INSTALLATION AND PRIOR TO FINAL ACCEPTANCE. INCLUDING ALL HEAD & EQUIPMENT LOCATIONS & MAINTENANCE DATA FOR ALL EQUIPMENT PROVIDED. CONTRACTOR SHALL PROVIDE AN ON-SITE WALK THROUGH OF THE SYSTEM AND FULLY DESCRIBE ITS OPERATION WITH OWNER. CONTRACTOR SHALL ACHIEVE FINAL ACCEPTANCE WHEN SYSTEM IS FULLY OPERATIONAL, AND APPROVED BY OWNER, AND AS-BUILT DRAWINGS AND PROJECT MANUALS HAVE

DATE 09.02.2022 JOB NO. 720022 CEE / IA / AAP / NSO/ CPC / BNH SHEET NO.



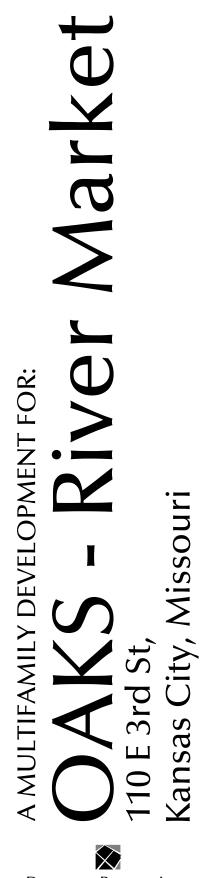

**RESIDENTIAL UNITS RESIDENTIAL COMMON AREA** COMMERCIAL PARKING GARAGE



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DRAWING RELEASE LOG

• 07.18.2022 - DEVELOPMENT PLAN

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**RESIDENTIAL UNITS RESIDENTIAL COMMON AREA** COMMERCIAL PARKING GARAGE DOG RUN



-(**F**)

E

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 $\bigcirc$ (C.9)


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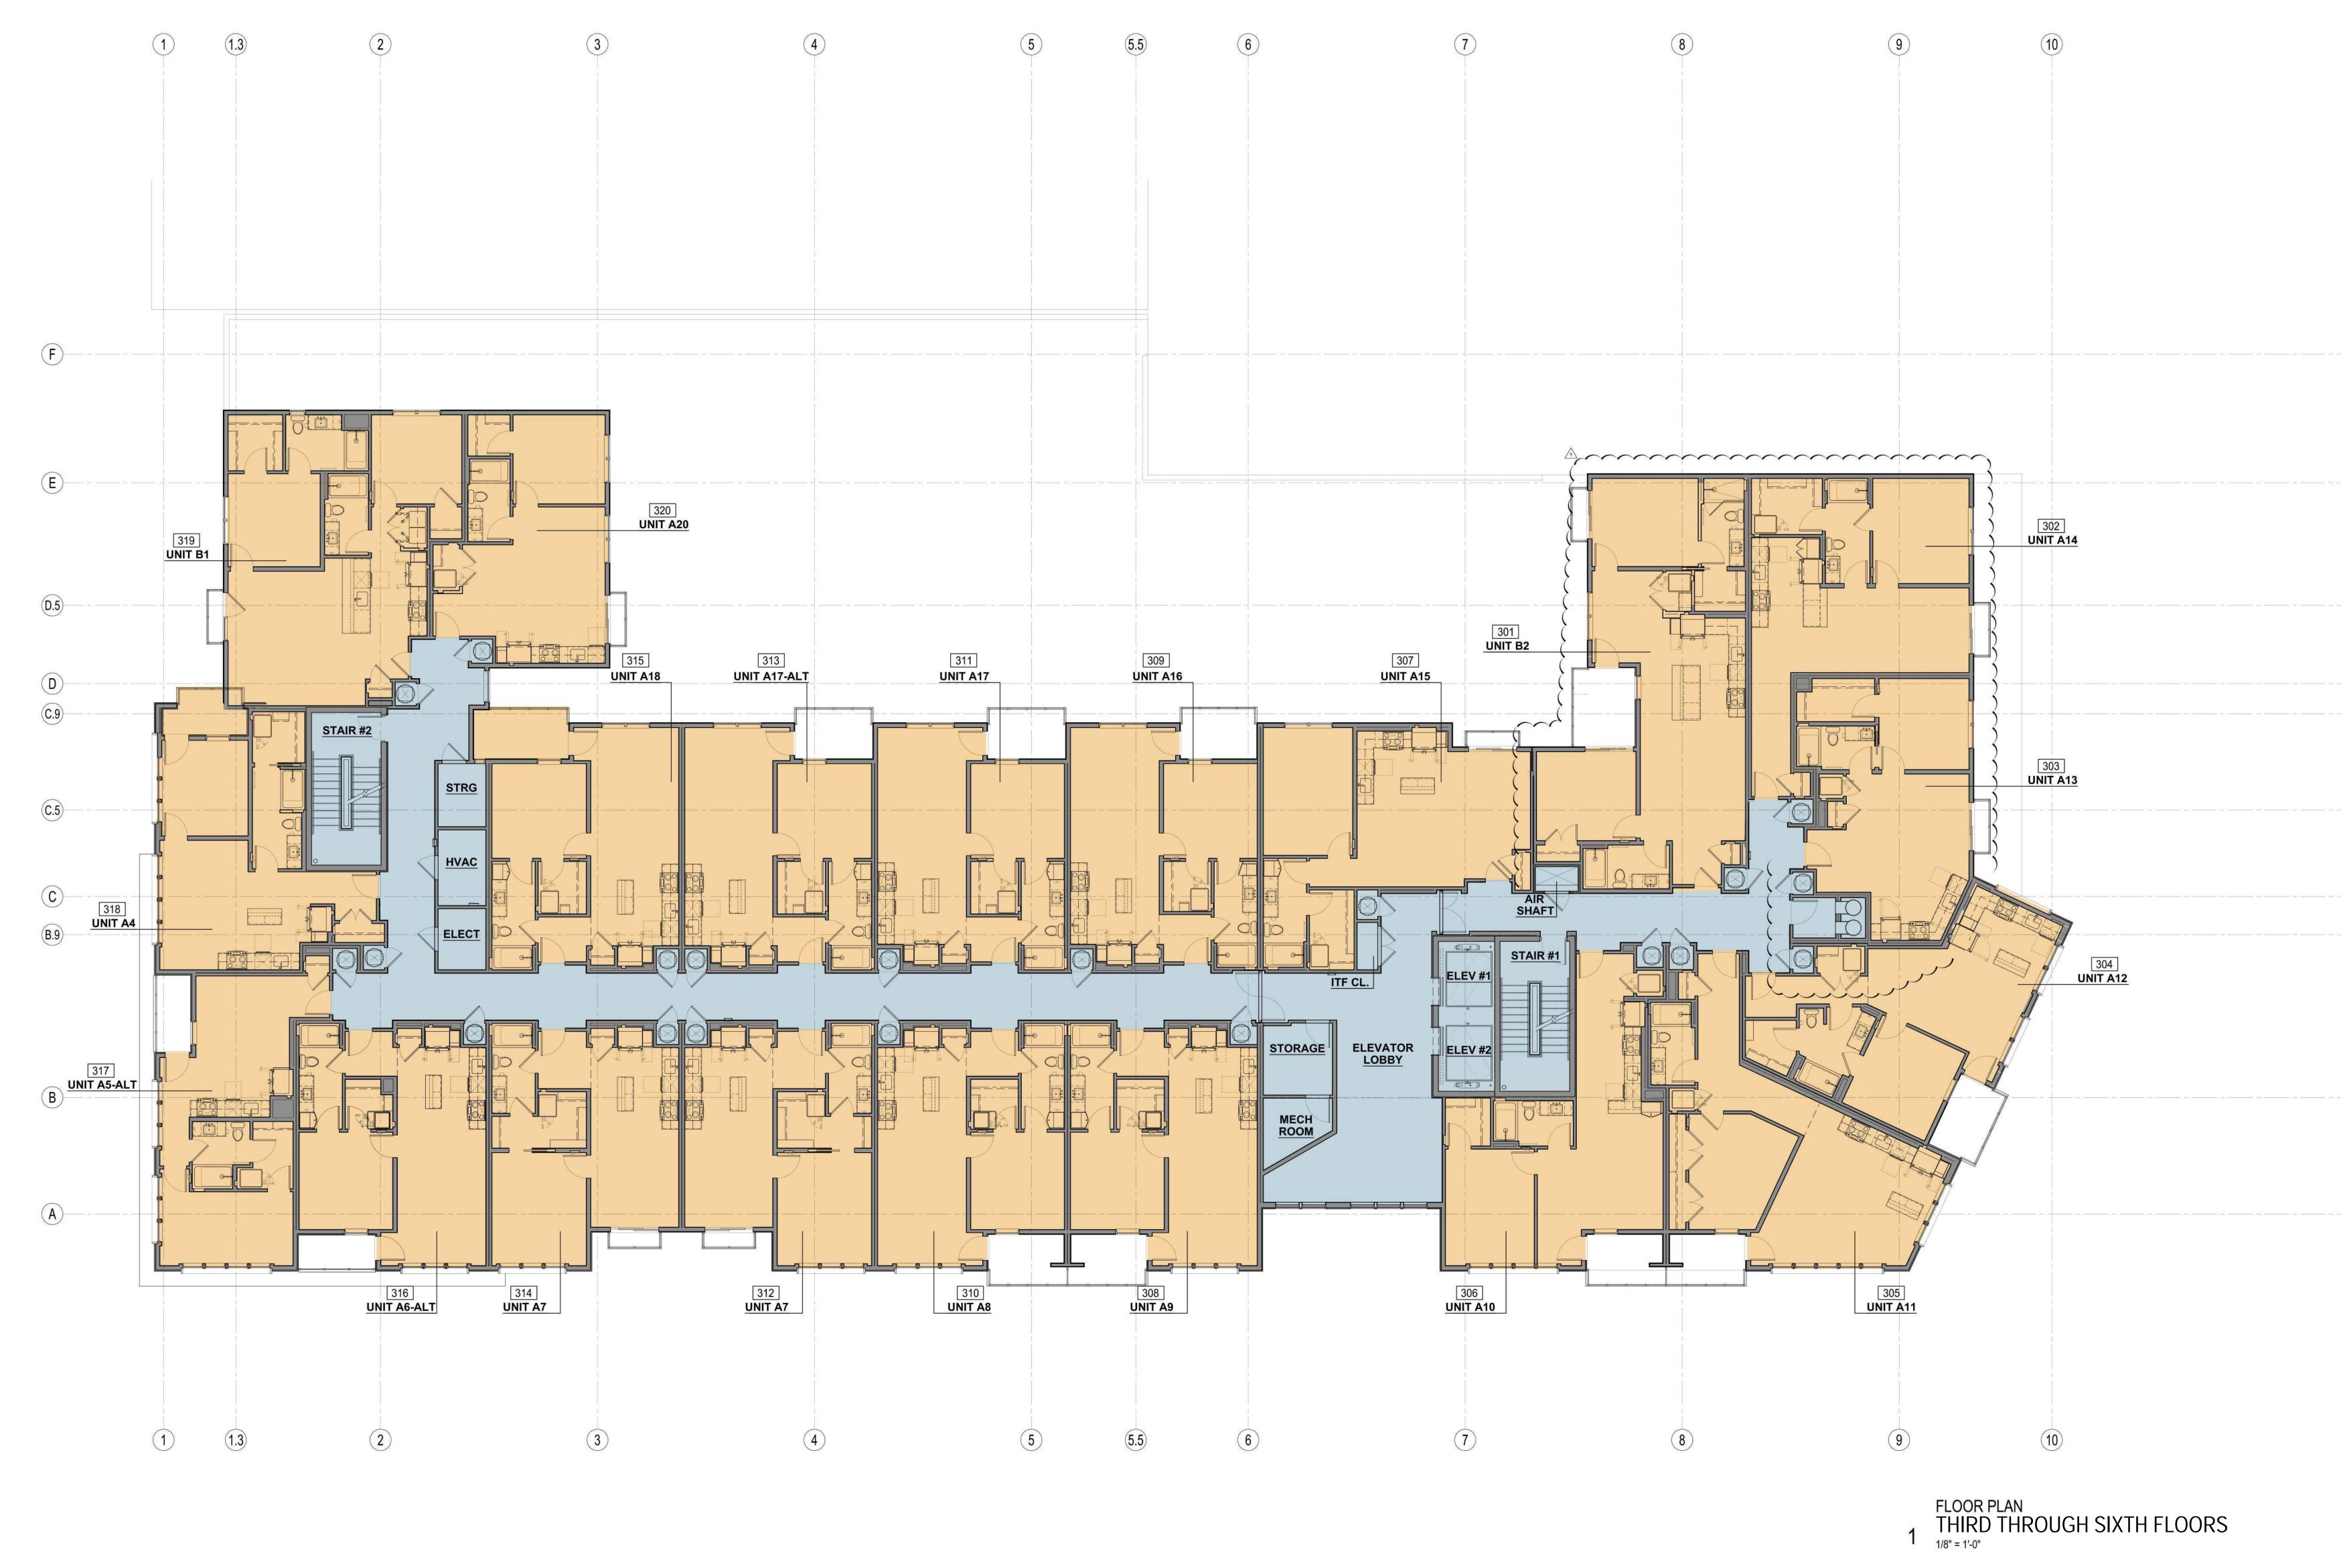
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**RESIDENTIAL UNITS** COMMERCIAL PARKING GARAGE

- **RESIDENTIAL COMMON AREA**



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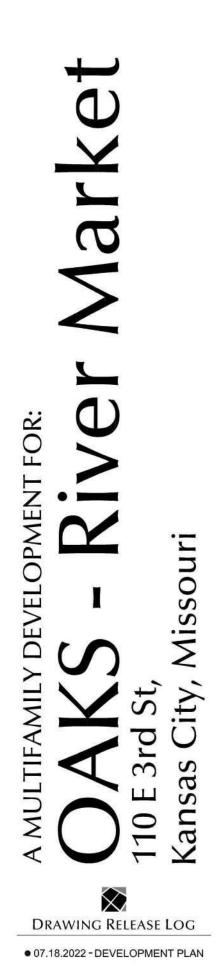
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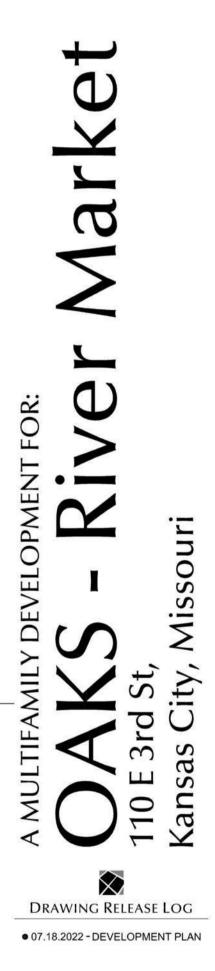
JOB NO. JOB NO. 720022 DRAWN BY: CEE / IA / AAP / NSO/ CPC SHEET NO. DEVELOPMENT PLAN A2.03

		1 1.3	2	3
*	STUCCO WRAPPED - CORNICE, UPLIT T.O. CORNICE + 886'-11 ¾"			CEMENTIT
	ROOF + 883'-11 <sup>3</sup> / <sub>4</sub> "			
	SIXTH FLOOR PLATELINE + 881'-11 <sup>3</sup> / <sub>4</sub> " WINDOWS PER SPEC	FILT		
10-5%	CEMENTITIOUS STUCCO STUCCO WRAPPED WINDOW SURROUND			
	SIXTH FLOOR T.O. SUBFLR + 871'-6"			
1-632-	FIFTH FLOOR PLATELINE + 869'-11 1/4" SMOOTH PANEL SIDING			
10-534	W/ BATTENS CEMENTITIOUS STUCCO ROTATED THIN BRICK			
	VENEER CAP			
9-134"	FOURTH FLOOR PLATELINE + 857'-10 3/4" STUCCO WRAPPED - WINDOW SURROUND			
	FOURTH FLOOR T.O. SUBFLR + 848'-9"			
WIT BLDC	THIRD FLOOR PLATELINE + 847'-2 1/4"			
74-11%": OVERALL 9-1%" 1-6}	THIN BRICK VENEER			
	THIRD FLOOR T.O. SUBFLR + 838'-0 ½"			
	SECOND FLOOR PLATELINE + 836'-5 3/4" SECOND FLOOR T.O. SLAB + 827'-4"			
	FIRST FLOOR T.O. SLAB + 813'-10"			
-0-0 	AVERAGE GRADE PLANE : ±809'-0"			
	LOWER LEVEL T.O. SLAB + 803'-1"			
	STOREFRONT, RE: SCHEDULE			PREFINISHED ALUMINUM RAILING FULL VIEW TERRACE DOORS, RE: PLANS ART WALL, FINISH TBD
	STUCCO WRAPPED - CANOPY PROJECTION CAST STONE BASE - THIN STONE VENEER -			STUCCO WRAPPED CANOPY PROJECTION CEMENTITIOUS STUCCO
	PREFINISHED ALUMINUM - RAILINGS w/ GATE		<u>_</u>	

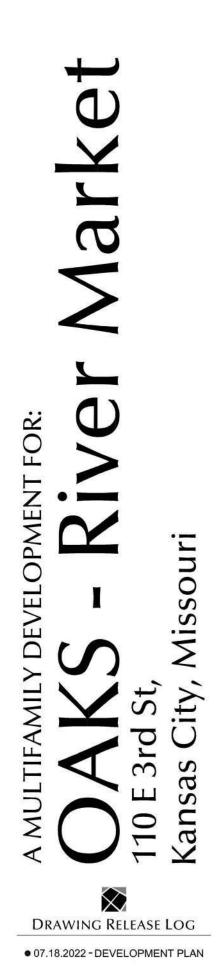



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DATE 07.18.2022 JOB NO. 720022 DRAWN BY: CEE / IA / AAP / NSO/ CPC SHEET NO.


△ ● 09.05.2022 - DEVELOPMENT PLAN RESUBMITTAL

REVISIONS

DEVELOPMENT PLAN A3.01




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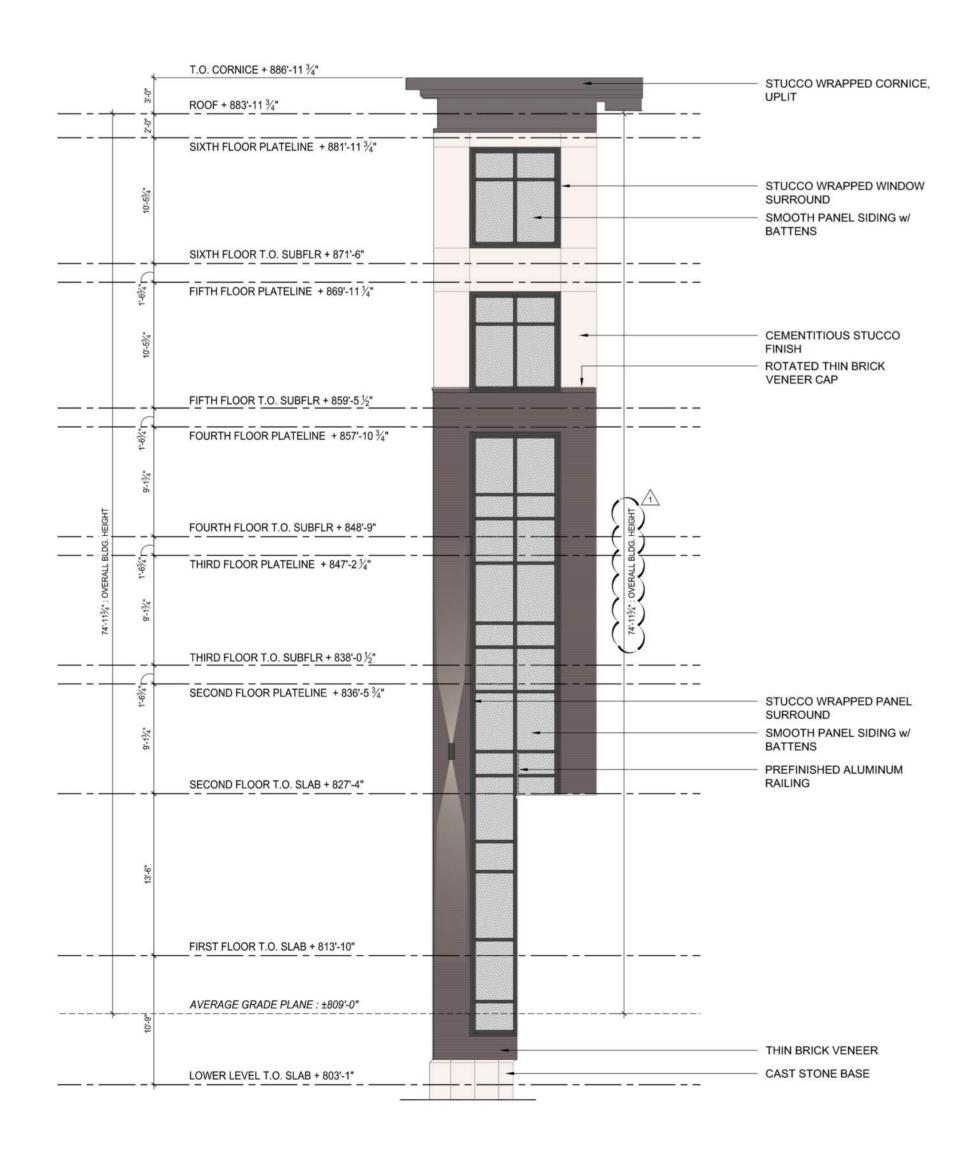
BUILDING ELEVATION

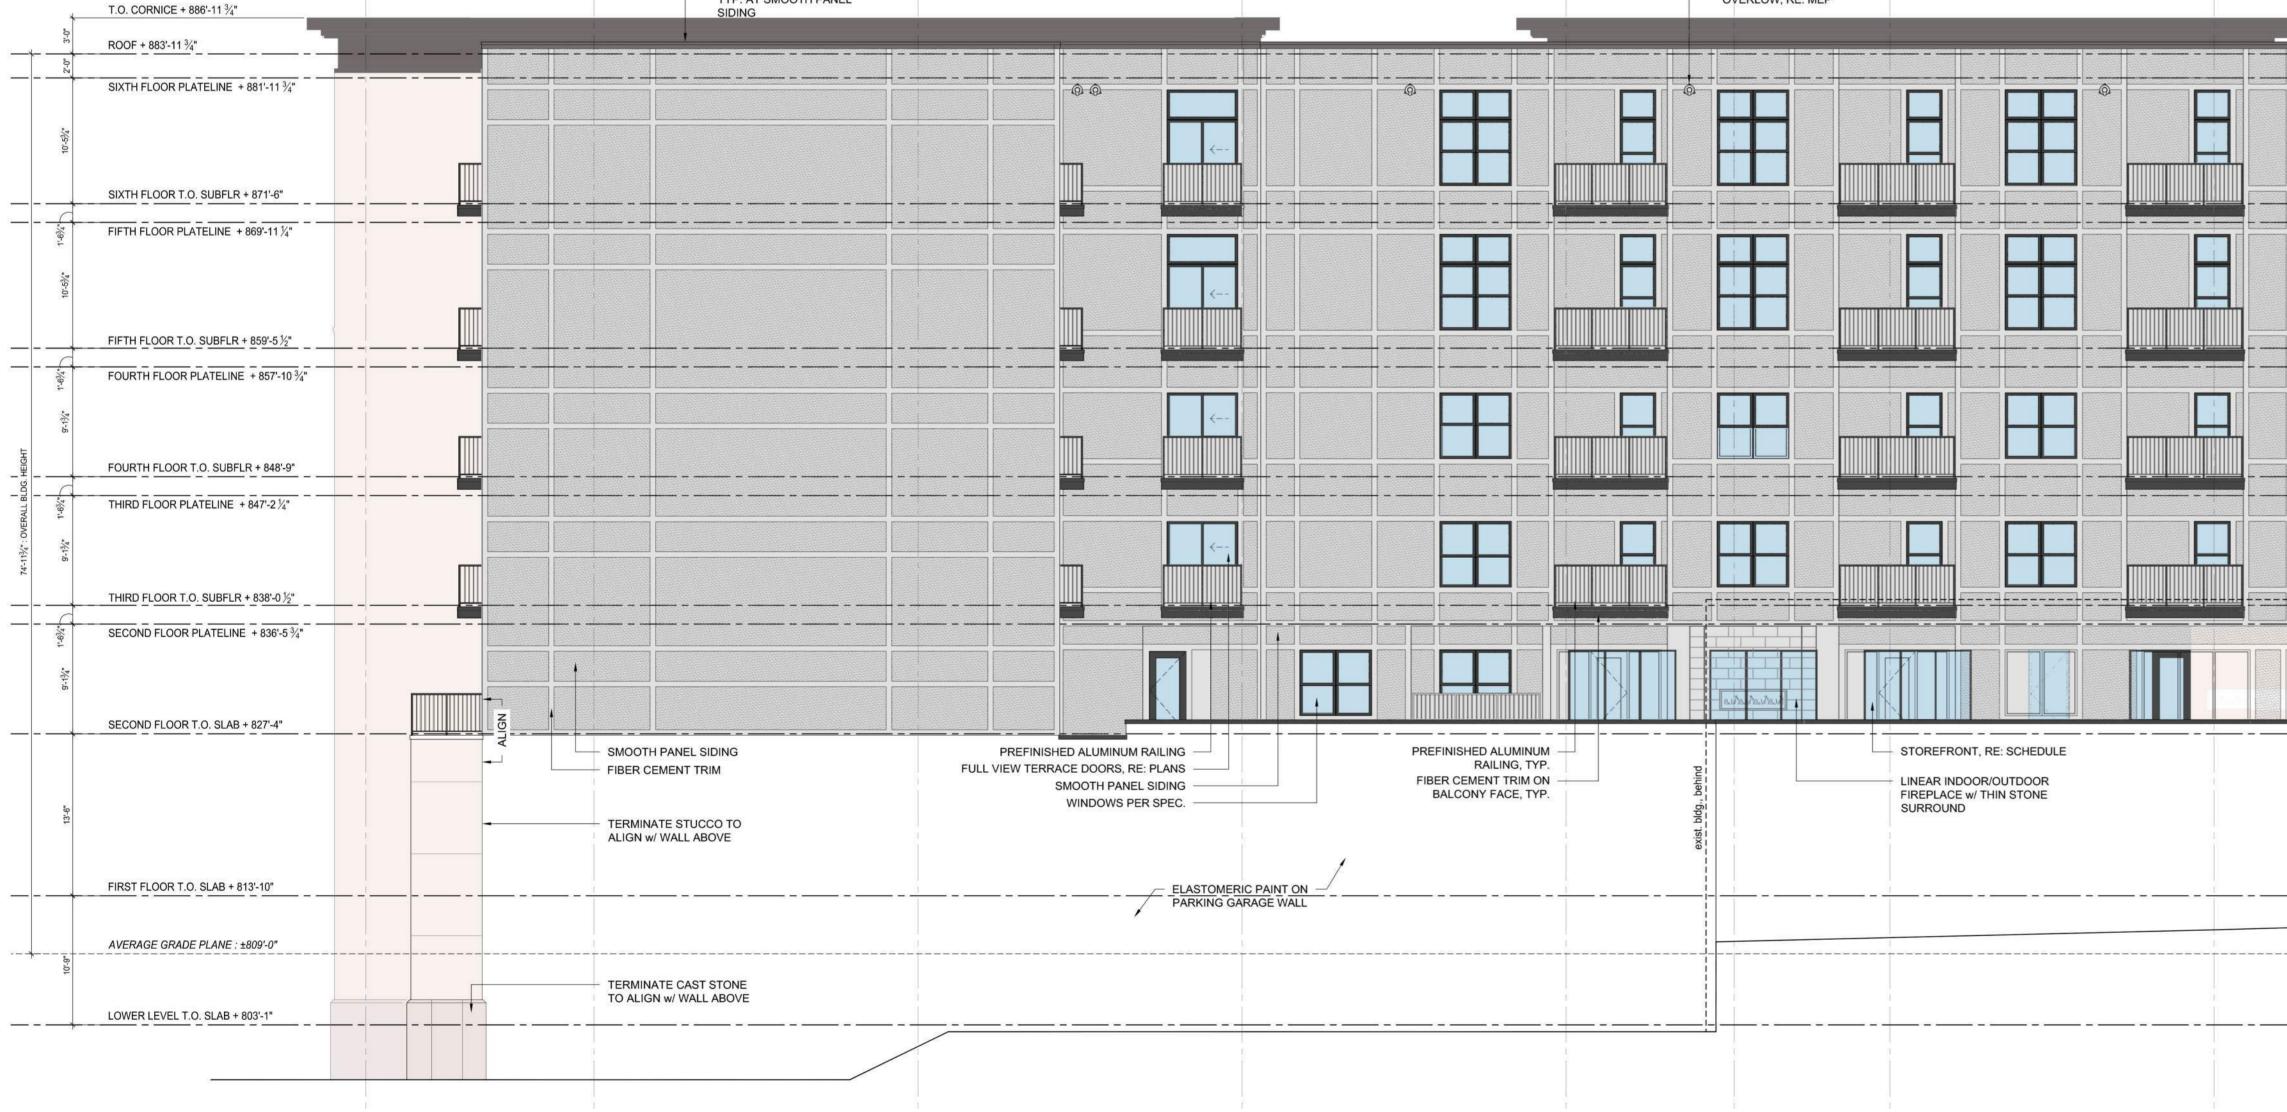

DATE 07.18.2022 JOB NO. 720022 DRAWN BY: CEE / IA / AAP / NSO/ CPC SHEET NO. DEVELOPMENT PLAN A3.02

△ ● 09.05.2022 - DEVELOPMENT PLAN RESUBMITTAL

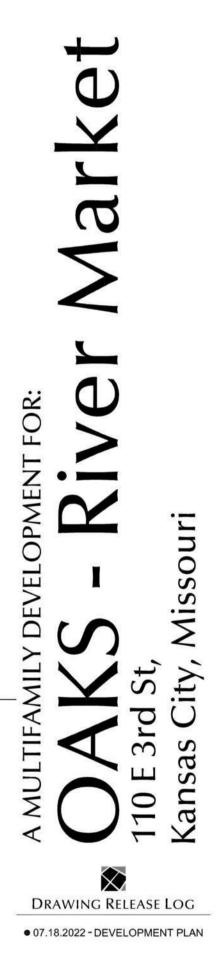REVISIONS





# 2 ELEVATION NORTHEAST ELEVATION 1/8" = 1'-0"





#### BUILDING ELEVATION GENERAL NOTES

- A. RETURN ALL SIDING AND CLADE INSIDE CORNERS.
- B. REFER TO WINDOW SCHEDULE MATERIAL AND COLOR
- C. SEE HATCH LEGEND BELOW FO
- D. WALL MOSAIC TILE AT SHORT TO BE FINAL SELECTION BY OW
- ADJACENT MATERIALS. SUBMIT ARCHITECT FOR FINAL SELECT
- F. ALL SIDING PANEL FASTENERS SANDED SMOOTH PRIOR TO HA
- G. REFER TO WALL SECTIONS AND LOCATIONS OF HEMMED EDGE SHEET METAL FLASHINGS
- H. STOREFRONT AT LEASING OFFI
- I. ALL TRIM TO BE FIBER CEMENT NOTED OTHERWISE. SIZE OF T

	T <sup>I</sup> URE A P E T URE O R S VICES	913.831.1415 913.831.1563 рЈАКСН.СОМ
DDING MATERIALS TO		<ul> <li>P. 913.831.141</li> <li>F. 913.831.156</li> <li>NSPJARCH.COM</li> <li>COPYRIGHT 203</li> </ul>
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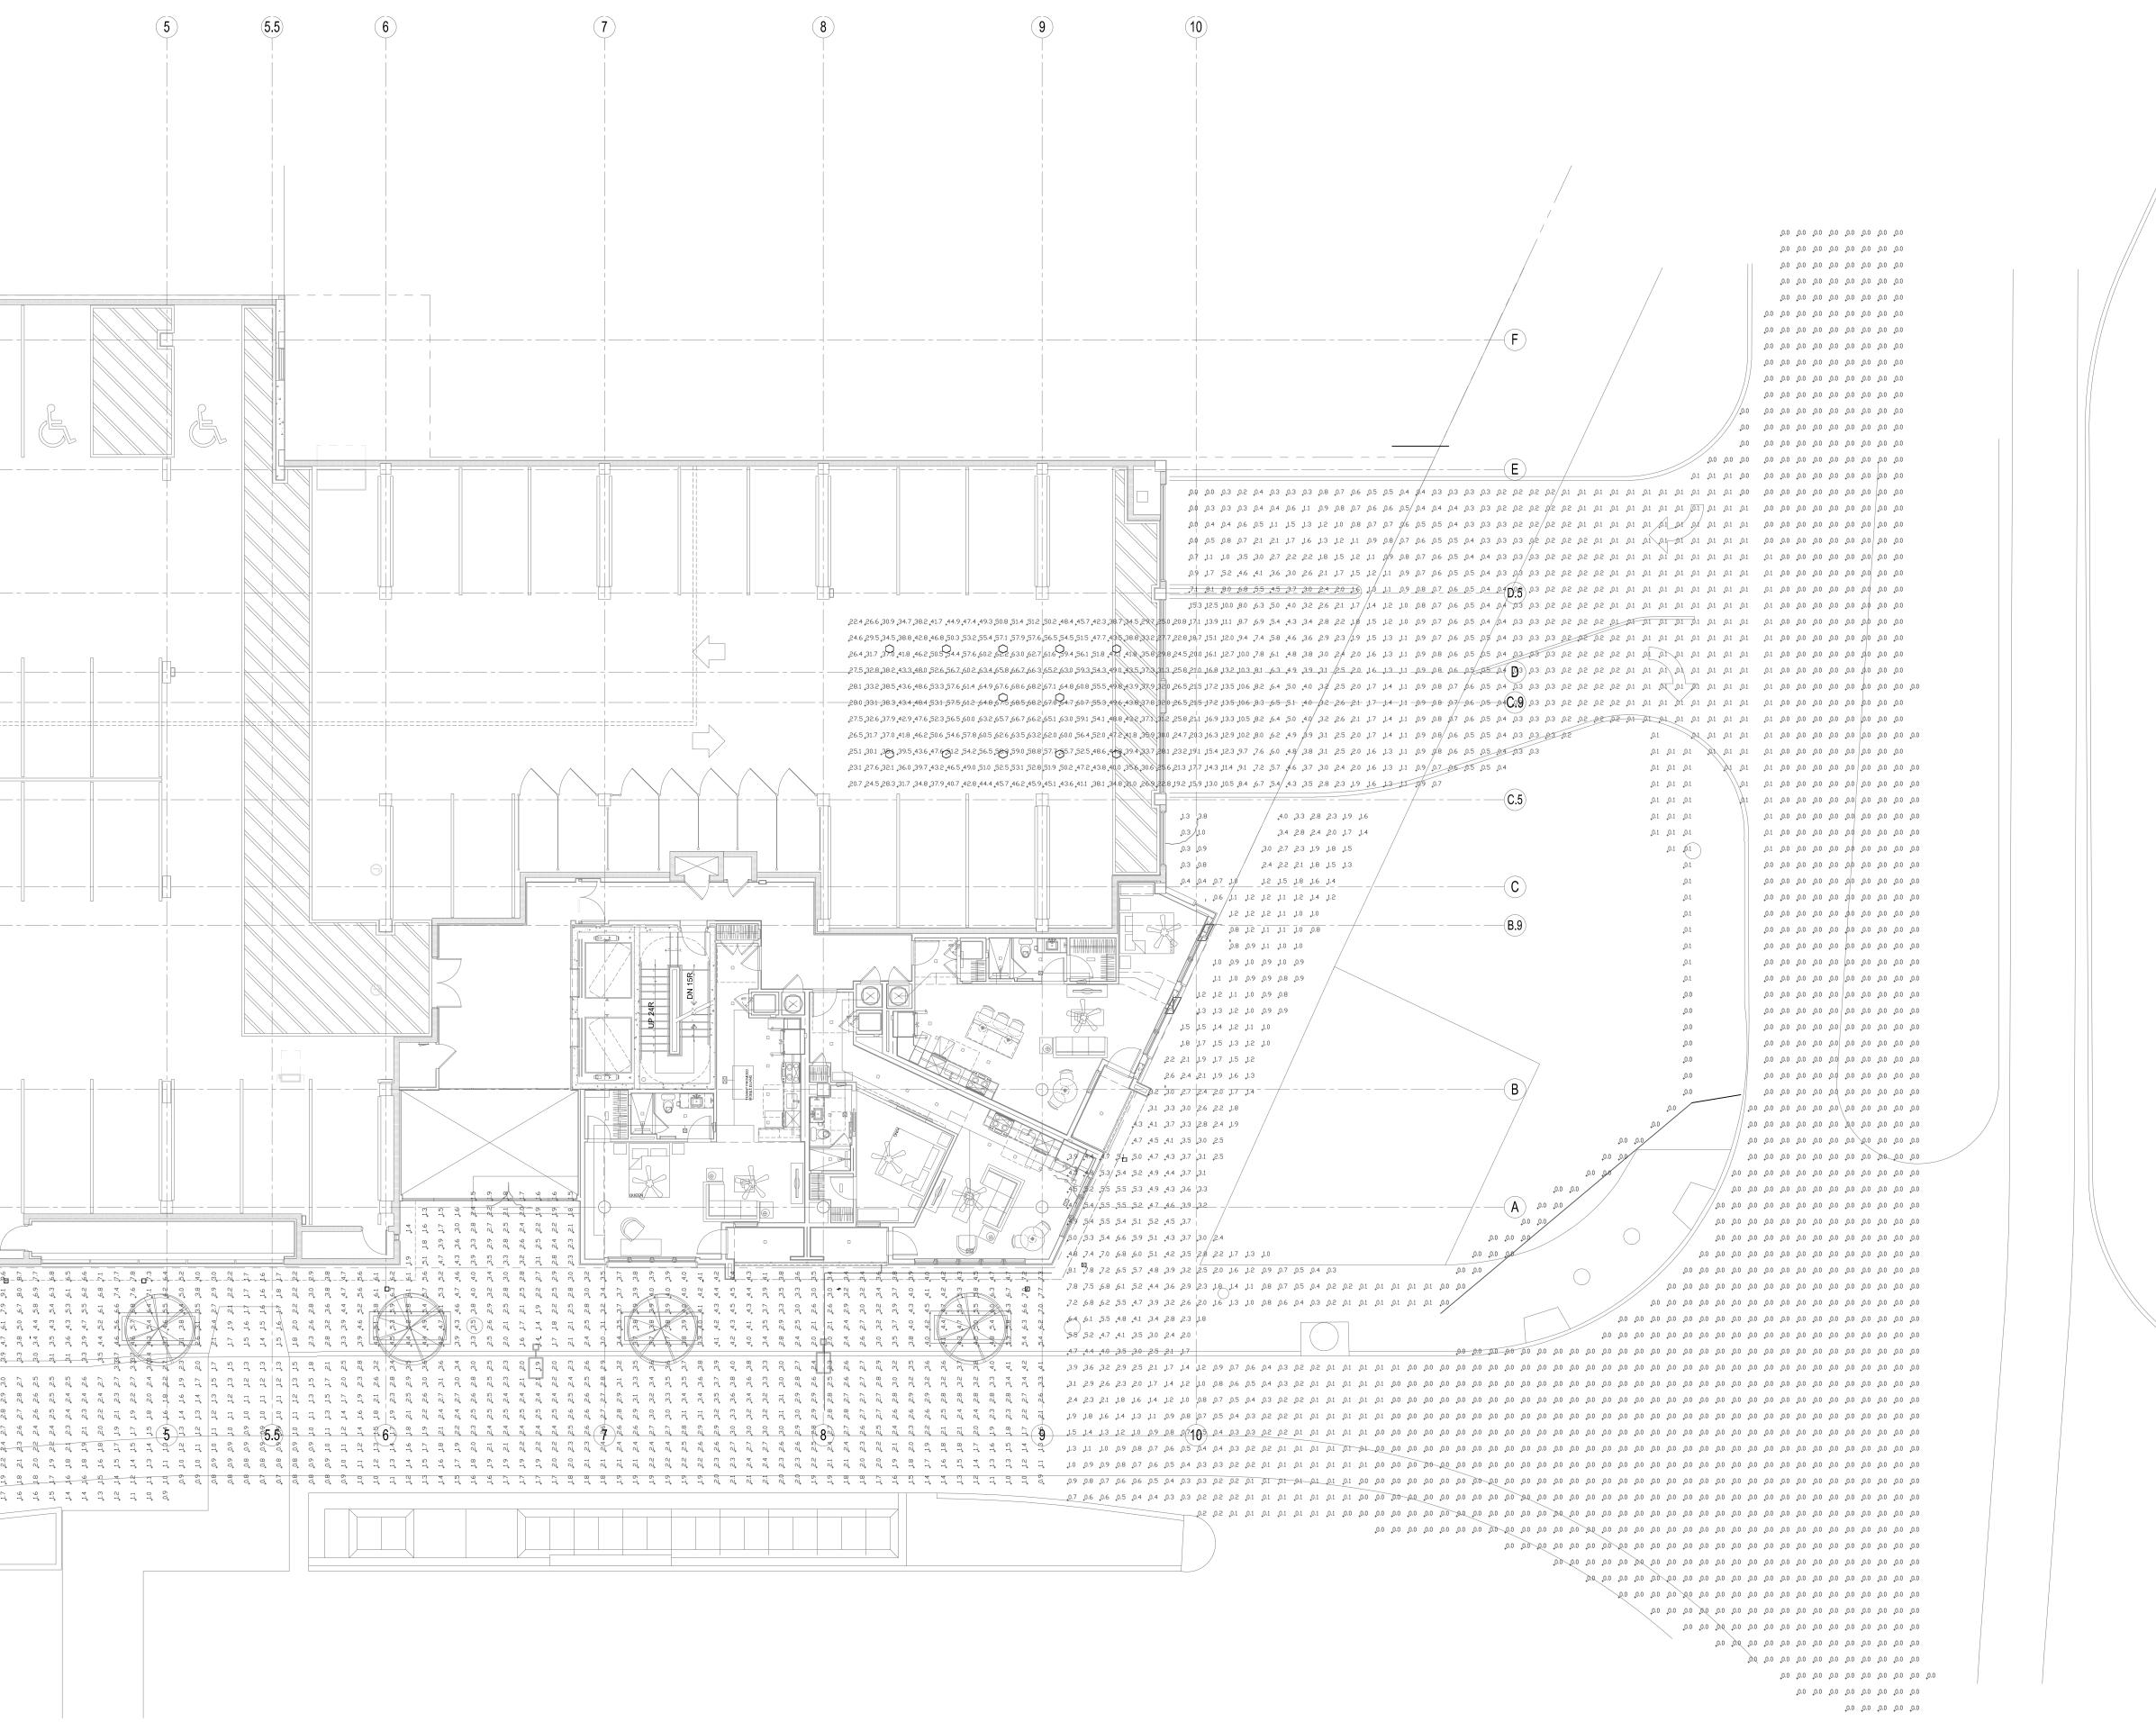


▲ 09.05.2022 - DEVELOPMENT PLAN RESUBMITTAL DATE 07.18.2022 JOB NO. 720022

DRAWN BY: CEE / IA / AAP / NSO/ CPC SHEET NO. DEVELOPMENT PLAN A3.03

REVISIONS

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SITE PHOTOMETRIC PLAN FF1.01) SCALE: 3/32" = 1'-0"





• 06.01.2018 - 80% PROGRESS SET

• 12.23.2019 - PERMIT SET • 01.06.2020 - QCR COMMENT RESPONSE

• 02.24.2020 - ADDENDUM 1

• 07.14.2020 - CITY COMMENTS

• 11.24.2020 - CITY COMMENTS





Date 12.23.2019 JOB NO. 571115 DRAWN BY engineering consultants 9225 Indian Creek Pkwy, Suite 1075 | Overland Park, KS 66210 T: 913.322.1400 : www.rtmassociates.com VOL.1 SHEET NO. FFF1