
DEVELOPMENT PLAN FOR NE 88TH STREET & NORTH OAK TRAFFICWAY APARTMENTS

SECTION 11, TOWNSHIP 51, RANGE 33 IN KANSAS CITY, CLAY COUNTY, MISSOURI

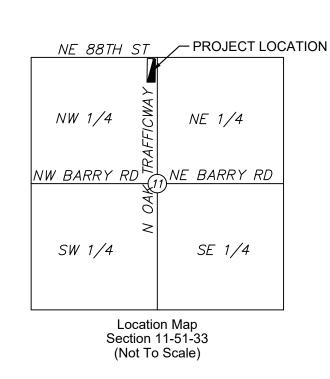


PROJECT TEAM

DEVELOPER
PC HOMES, LLC
7607 NW JOHN ANDERS RD
KANSAS CITY, MO 64152TEL: 816-753-9200
CONTACT: BRIAN MERTZ
EMAIL: BMERTZ1@KC.RR.COM

DESIGN PROFESSIONAL (CIVIL ENGINEER)
KIMLEY-HORN AND ASSOCIATES, INC.
805 PENNSYLVANIA AVENUE, SUITE 150
KANSAS CITY, MO 64105
TEL: (816) 652-0350
PRIMARY CONTACT: MATT KIST, P.E.
EMAIL: MATT.KIST@KIMLEY-HORN.COM
SECONDARY CONTACT: PERLA DIOSDADO, P.E.
EMAIL: PERLA.DIOSDADO@KIMLEY-HORN.COM

SURVEYOR
AYLETT SURVEY & ENGINEERING CO.
201 NW 72ND STREET,
GLADSTONE, MO 64118
TEL: 816-436-0732

ARCHITECT
TIM BALDRIDGE
3515 W. 75TH ST. SUITE 201,
PRAIRIE VILLAGE, KS 66208
TEL: 913-831-1563
EMAIL: TBALDRIDGE@NSPJARCH.COM

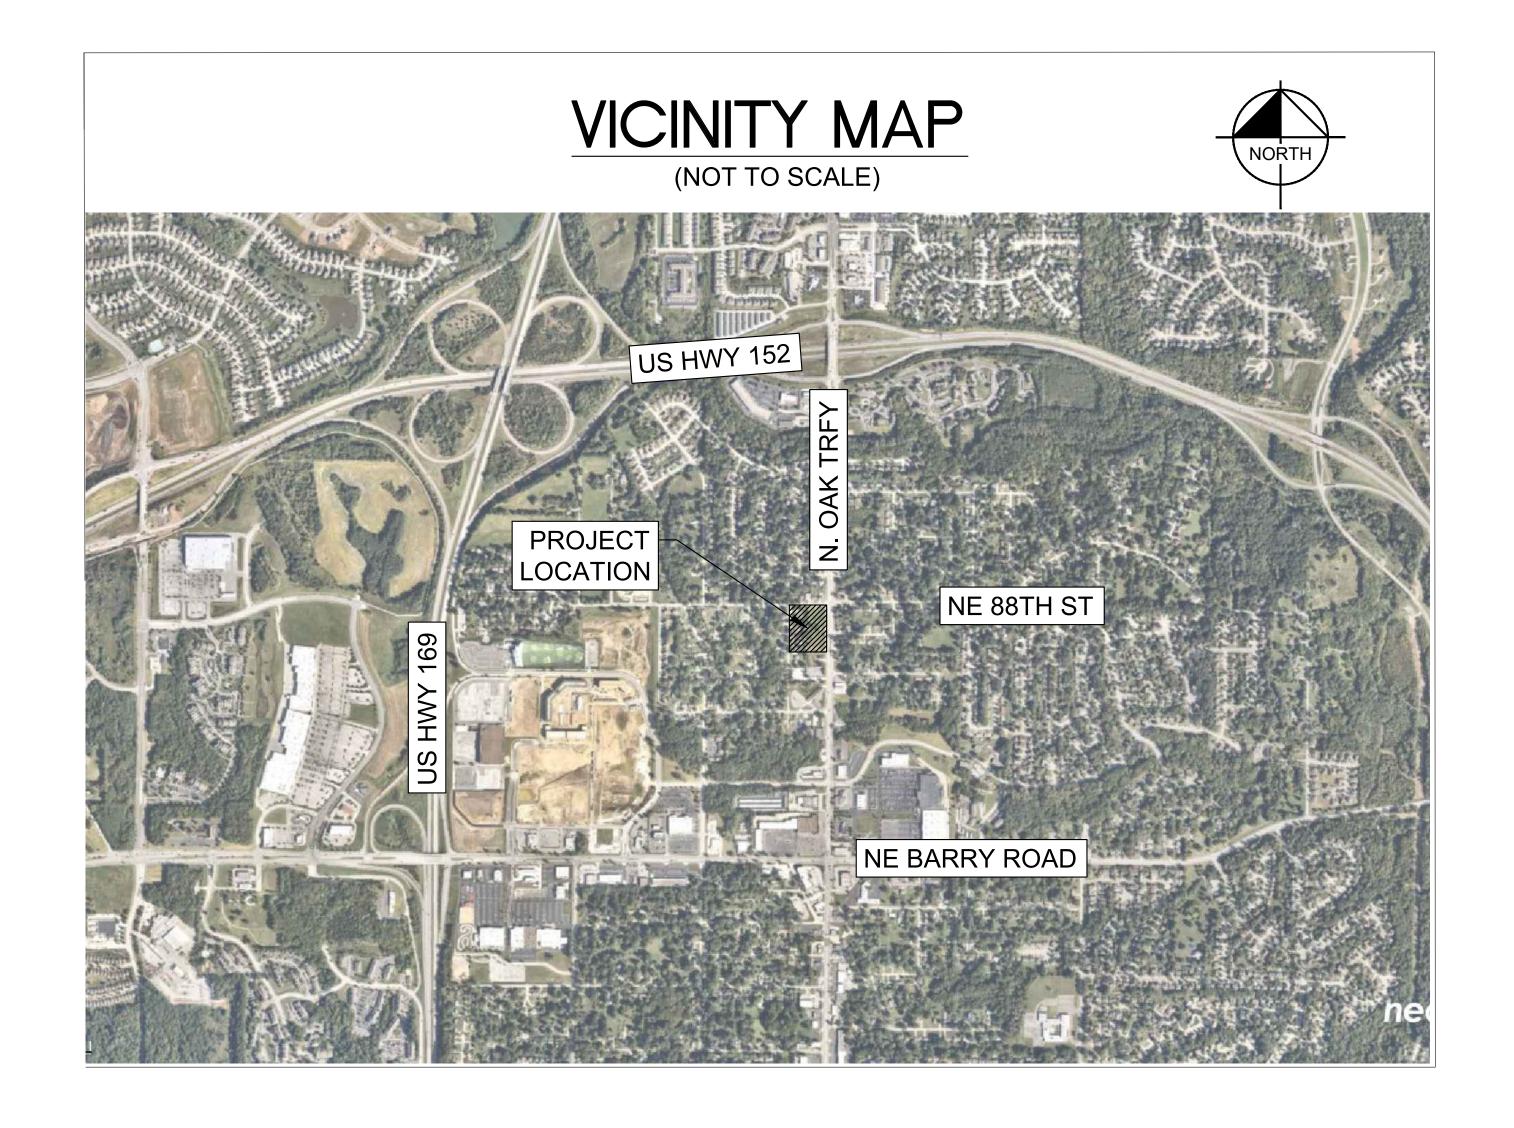

Sheet List Table						
Sheet Number	Sheet Title					
C1	COVER SHEET					
C2	EXISTING CONDITIONS					
C3	SITE PLAN					
C4	GRADING AND UTILITY PLAN					
L1	LANDSCAPE PLAN					
L2	STREET TREE PLANTING PLAN					
L3	LANDSCAPE NOTES AND DETAILS					
A1	BUILDING ELEVATIONS-1					
A2	BUILDING ELEVATIONS-2					
A3	BUILDING ELEVATIONS-3					

EXISTING LEGAL DESCRIPTION

THE NORTH 95 FEET OF THE EAST ONE HALF OF LOT 2, GASHLAND HEIGHTS RESURVEY, EXCEPT THE EAST 20 FEET THEREOF, A SUBDIVISION IN KANSAS CITY, CLAY COUNTY, MISSOURI; AND ALSO THE EAST HALF OF LOT 1, GASHLAND HEIGHTS RESURVEY, A SUBDIVISION IN KANSAS CITY, CLAY COUNTY, MISSOURI, EXCEPT THAT PART DEEDED TO THE CITY OF KANSAS CITY IN DEED RECORDED OCTOBER 7, 1996 AS DOCUMENT NO. N17010 IN BOOK 2609 AT PAGE 520; AND ALSO THE EAST 190 FEET OF THE SOUTH ONE HALF OF LOT 2, GASHLAND HEIGHTS RESURVEY, A SUBDIVISION OF LAND IN KANSAS CITY, CLAY COUNTY, MISSOURI, AND ALL OF THE EAST ONE HALF OF LOT 2, EXCEPT THE NORTH 95 FEET THEREOF, GASHLAND HEIGHTS RESURVEY, A SUBDIVISION IN KANSAS CITY, CLAY COUNTY, MISSOURI, ALSO EXCEPT THE FOLLOWING TRACT DEEDED TO KANSAS CITY, DESCRIBED AS FOLLOWS: THE EAST 20.00 FEET OF THE SOUTH 105 FEET OF LOT 2, GASHLAND HEIGHTS RESURVEY, A SUBDIVISION IN KANSAS CITY, CLAY COUNTY, MISSOURI; AND ALSO THE EAST HALF OF THE NORTH HALF OF TRACT 3, GASHLAND HEIGHTS RESURVEY, A SUBDIVISION IN KANSAS CITY, CLAY COUNTY, MISSOURI; AND ALSO THE EAST HALF OF THE NORTH HALF OF TRACT 3, GASHLAND HEIGHTS RESURVEY, A SUBDIVISION IN KANSAS CITY, CLAY COUNTY, MISSOURI, EXCEPT THAT EAST 20 FEET THEREOF.

CONSTRUCTION CONSTRUCTION


OVER SHEE

NE 88TH STREET & RTH OAK TRAFFICWAY APARTMENTS

ORIGINAL ISSUE: 02.14.2022 KHA PROJECT NO. 268131000

SHEET NUMBER

C1

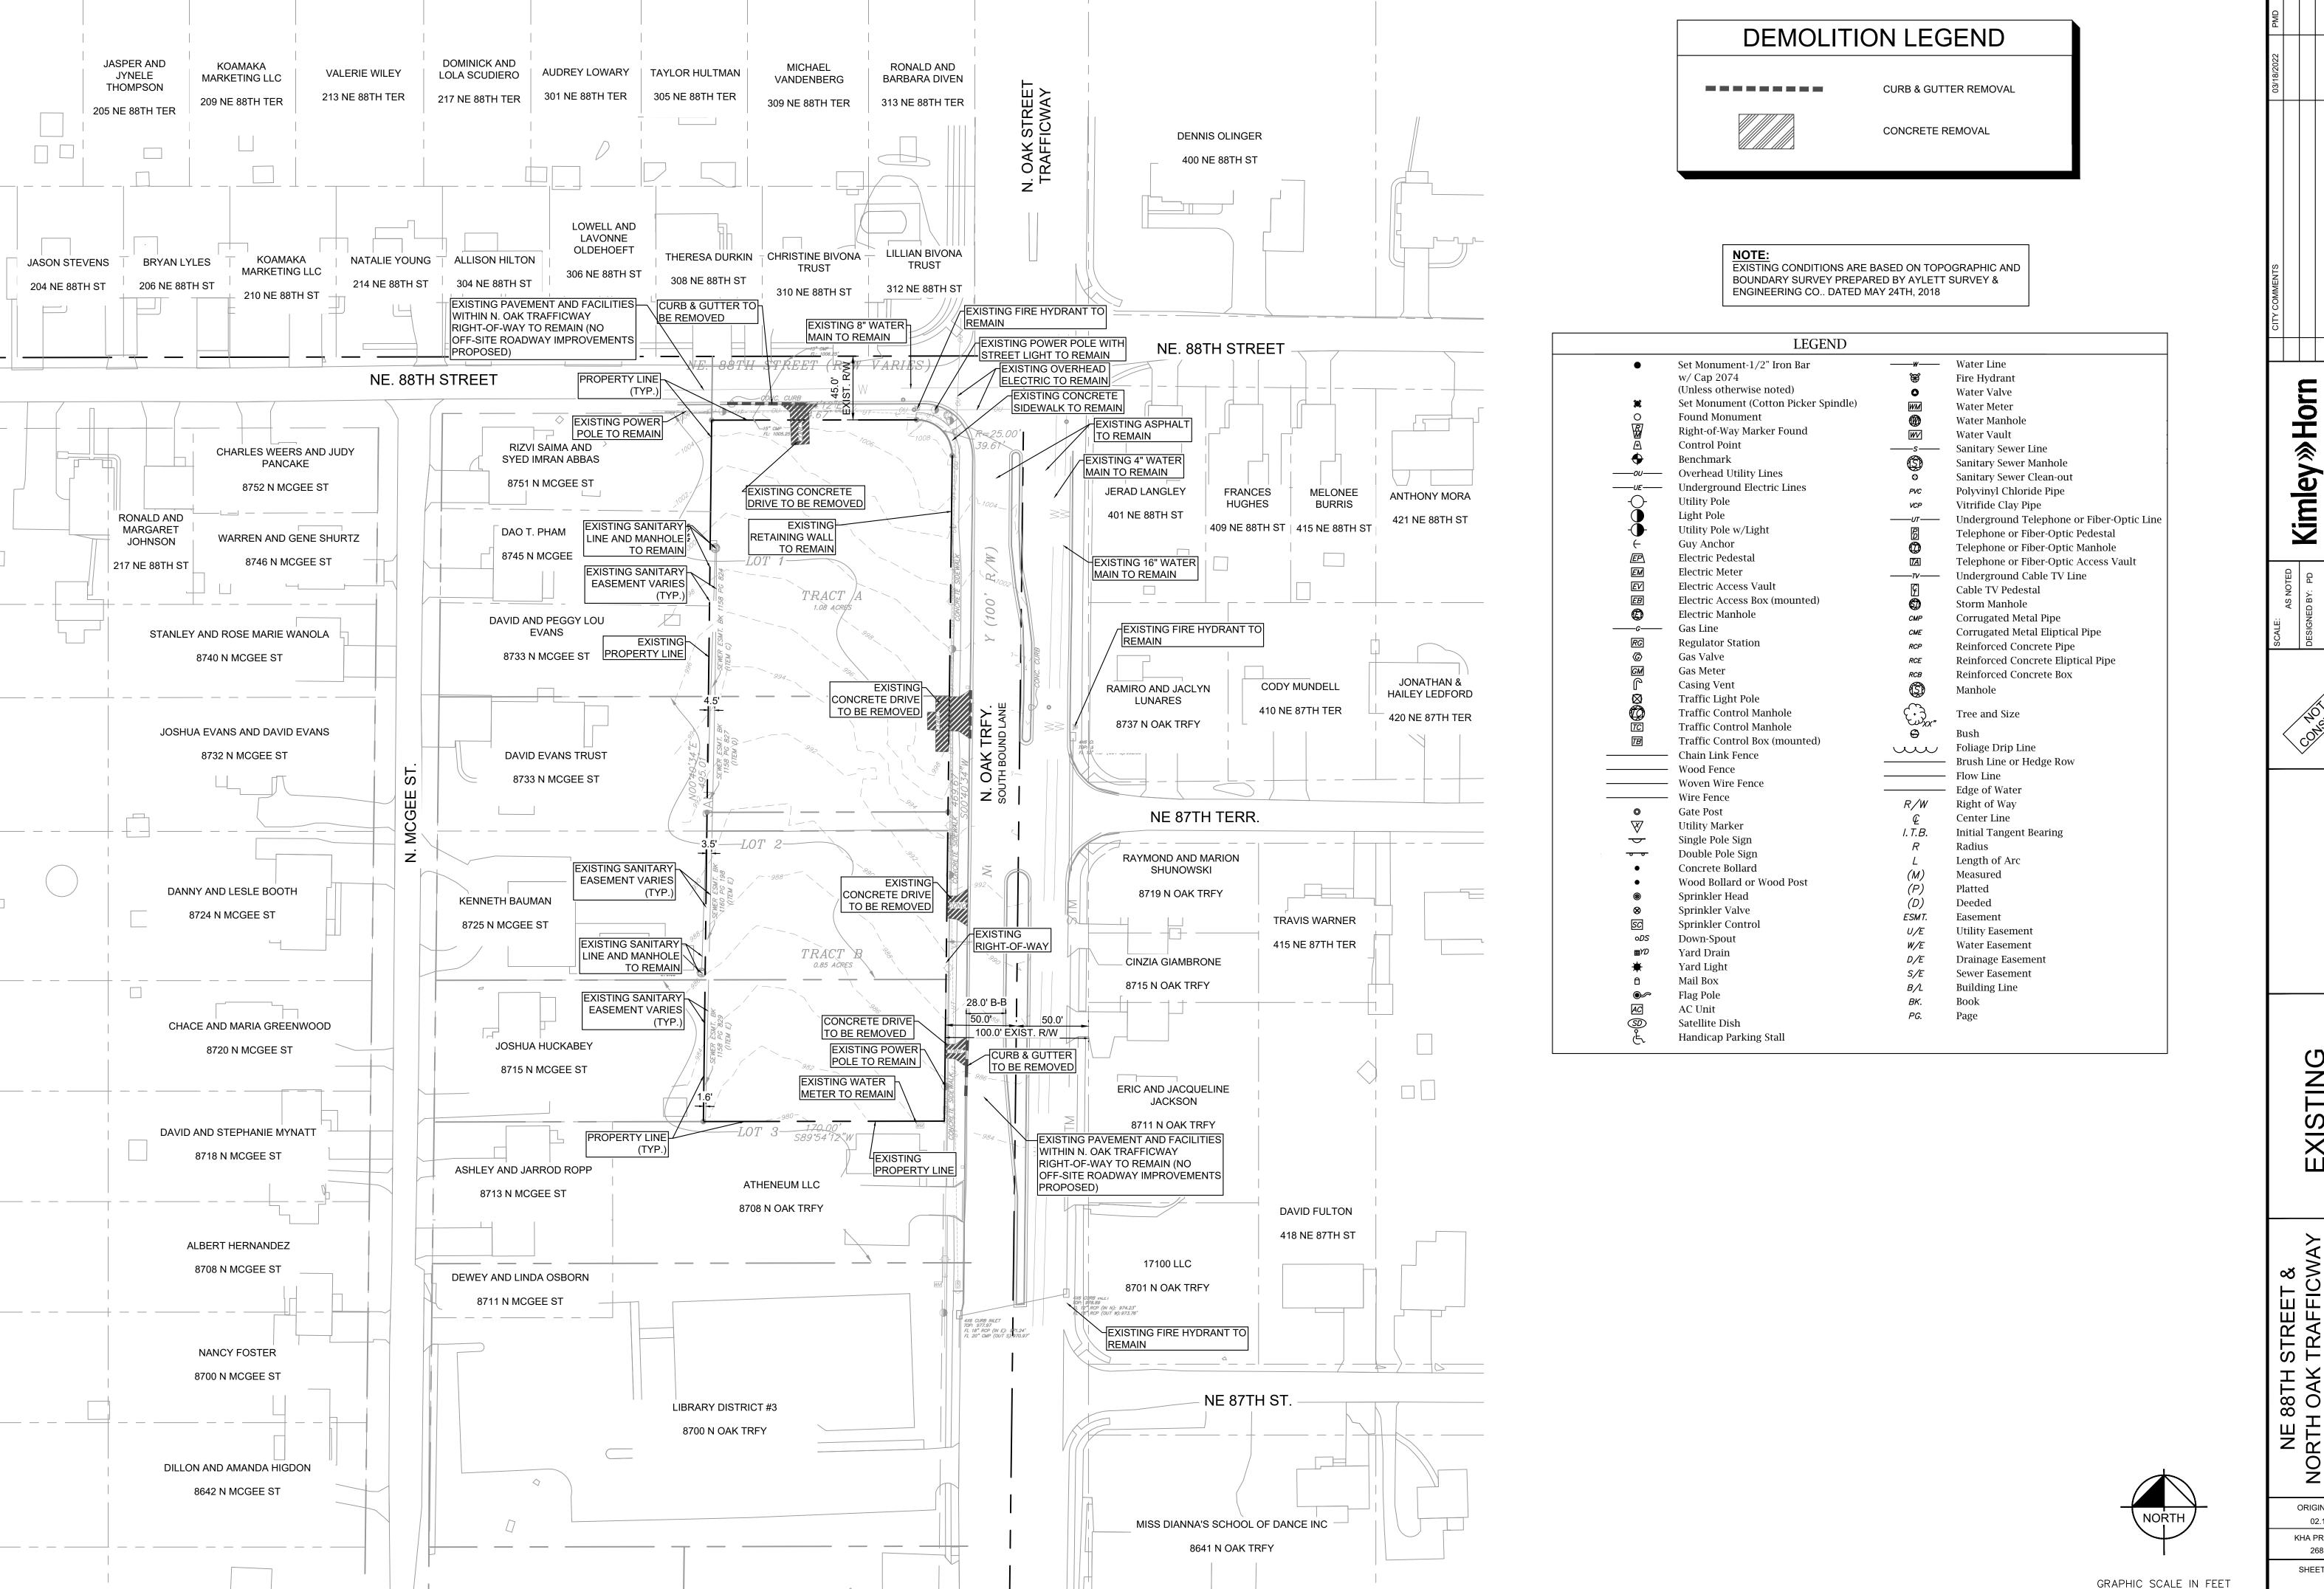


ORIGINAL ISSUE: 02.14.2022 KHA PROJECT NO. 268131000


EXISTING CONDITIONS

≫Horn

Kimley

SHEET NUMBER

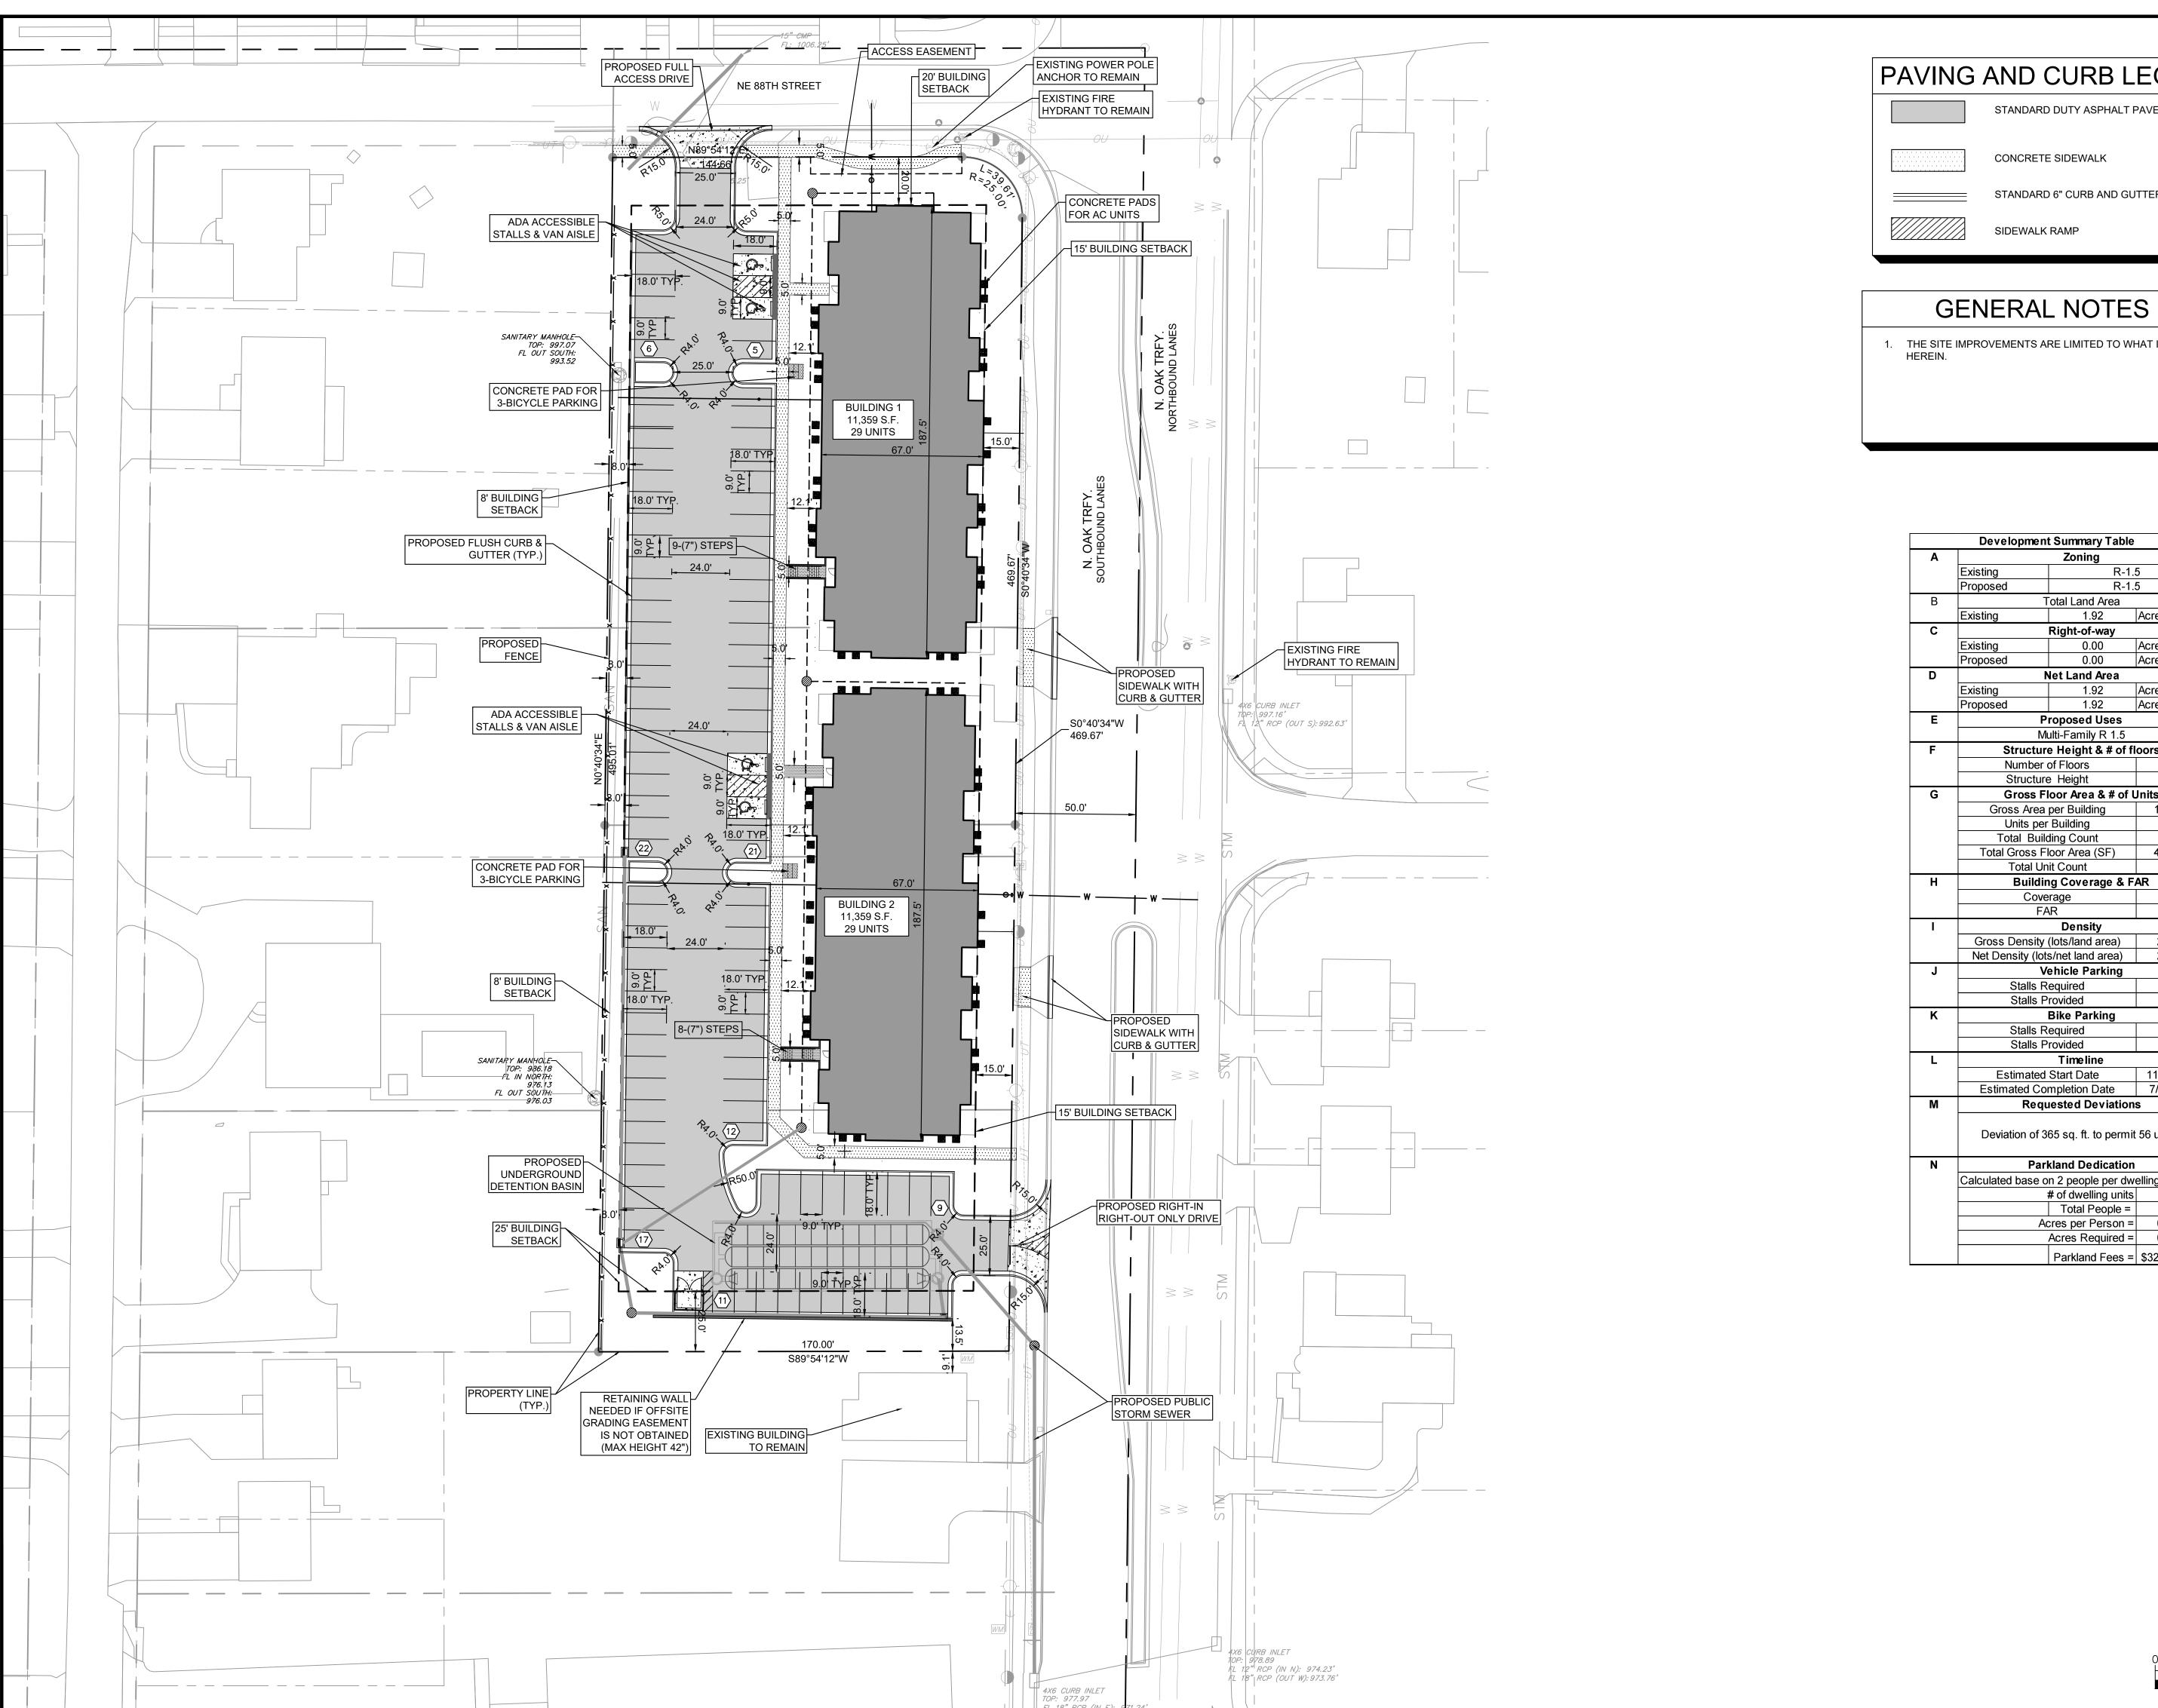

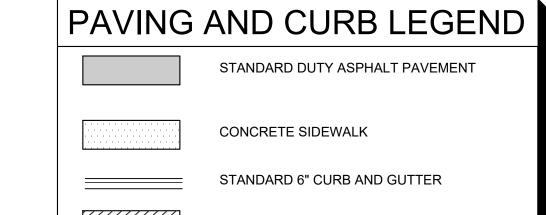

1. THE SITE IMPROVEMENTS ARE LIMITED TO WHAT IS SHOWN

	Developine	nt Summary Table					
Α		Zoning					
	Existing	R-1.					
	Proposed	R-1.	.5				
В		Total Land Area					
	Existing	1.92	Acres				
С		Right-of-way	•				
	Existing	0.00	Acres				
	Proposed	0.00	Acres				
D	'	Net Land Area	1				
_	Existing	1.92	Acres				
	Proposed	1.92	Acres				
E		Proposed Uses	7 10100				
_		Multi-Family R 1.5					
F	-	re Height & # of f	looro				
Г		of Floors	_				
			2				
	_	re Height	35				
G		Floor Area & # of	1				
		a per Building	11,359				
	•	er Building	28				
		Iding Count	2				
	Total Gross F	45,436					
	Total Unit Count						
Н	Buildi	ing Coverage & F	AR				
	Cov	27%					
	F	0.14					
ı		Density					
	Gross Density	(lots/land area)	29.17				
	Net Density (lo	ts/net land area)	29.17				
J	1	/ehicle Parking					
	Stalls I	Required	56				
	Stalls I	103					
K		Bike Parking	•				
-	Stalls F	6					
	Stalls I	6					
L		Timeline					
_	Fstimated	d Start Date	11/1/2022				
		ompletion Date	7/1/2023				
M		uested Deviation	ı				
IVI		365 sq. ft. to permi					
N	Parkland Dedication						
	Calculated base	Calculated base on 2 people per dw					
		56					
		112					
	Į.	+					
	Acres per Person = 0.006 Acres Required = 0.672						
		Daulder of E	\$32,794.52				




ORIGINAL ISSUE: 02.14.2022 KHA PROJECT NO. 268131000


SITE


SHEET NUMBER

NE 88TH STREET & NORTH OAK TRAFFICWAY APARTMENTS

Kimley » Horn

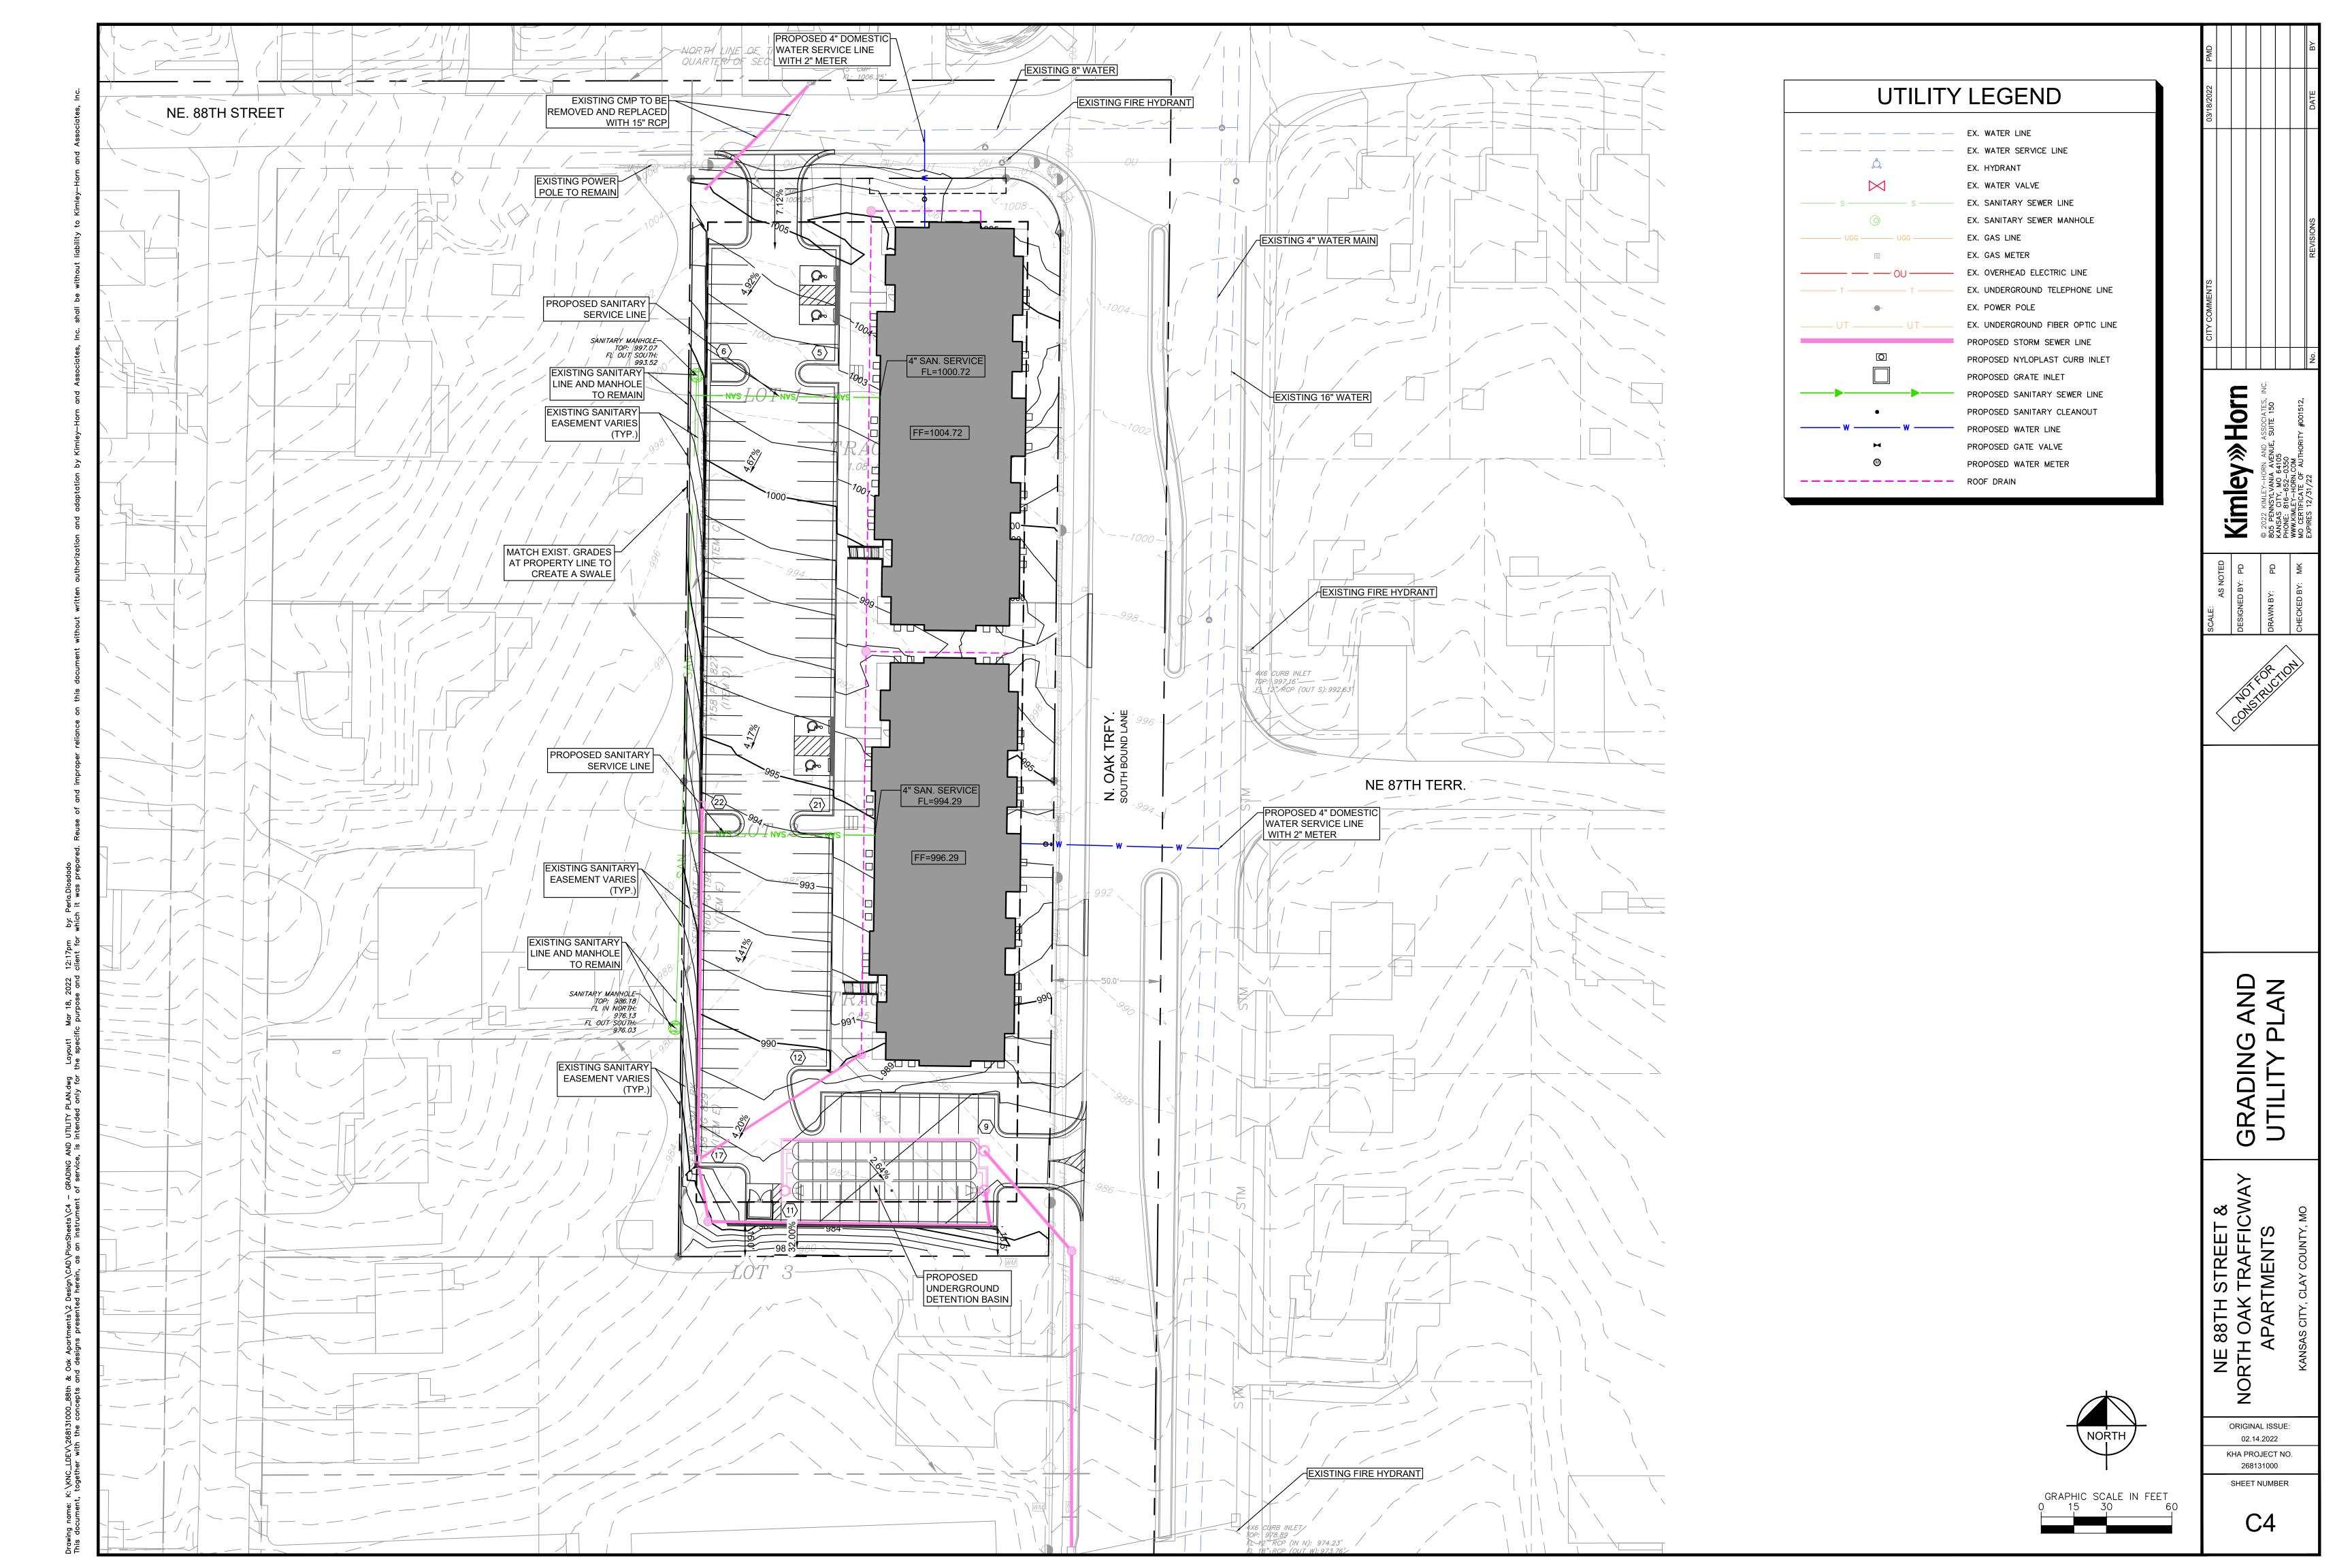

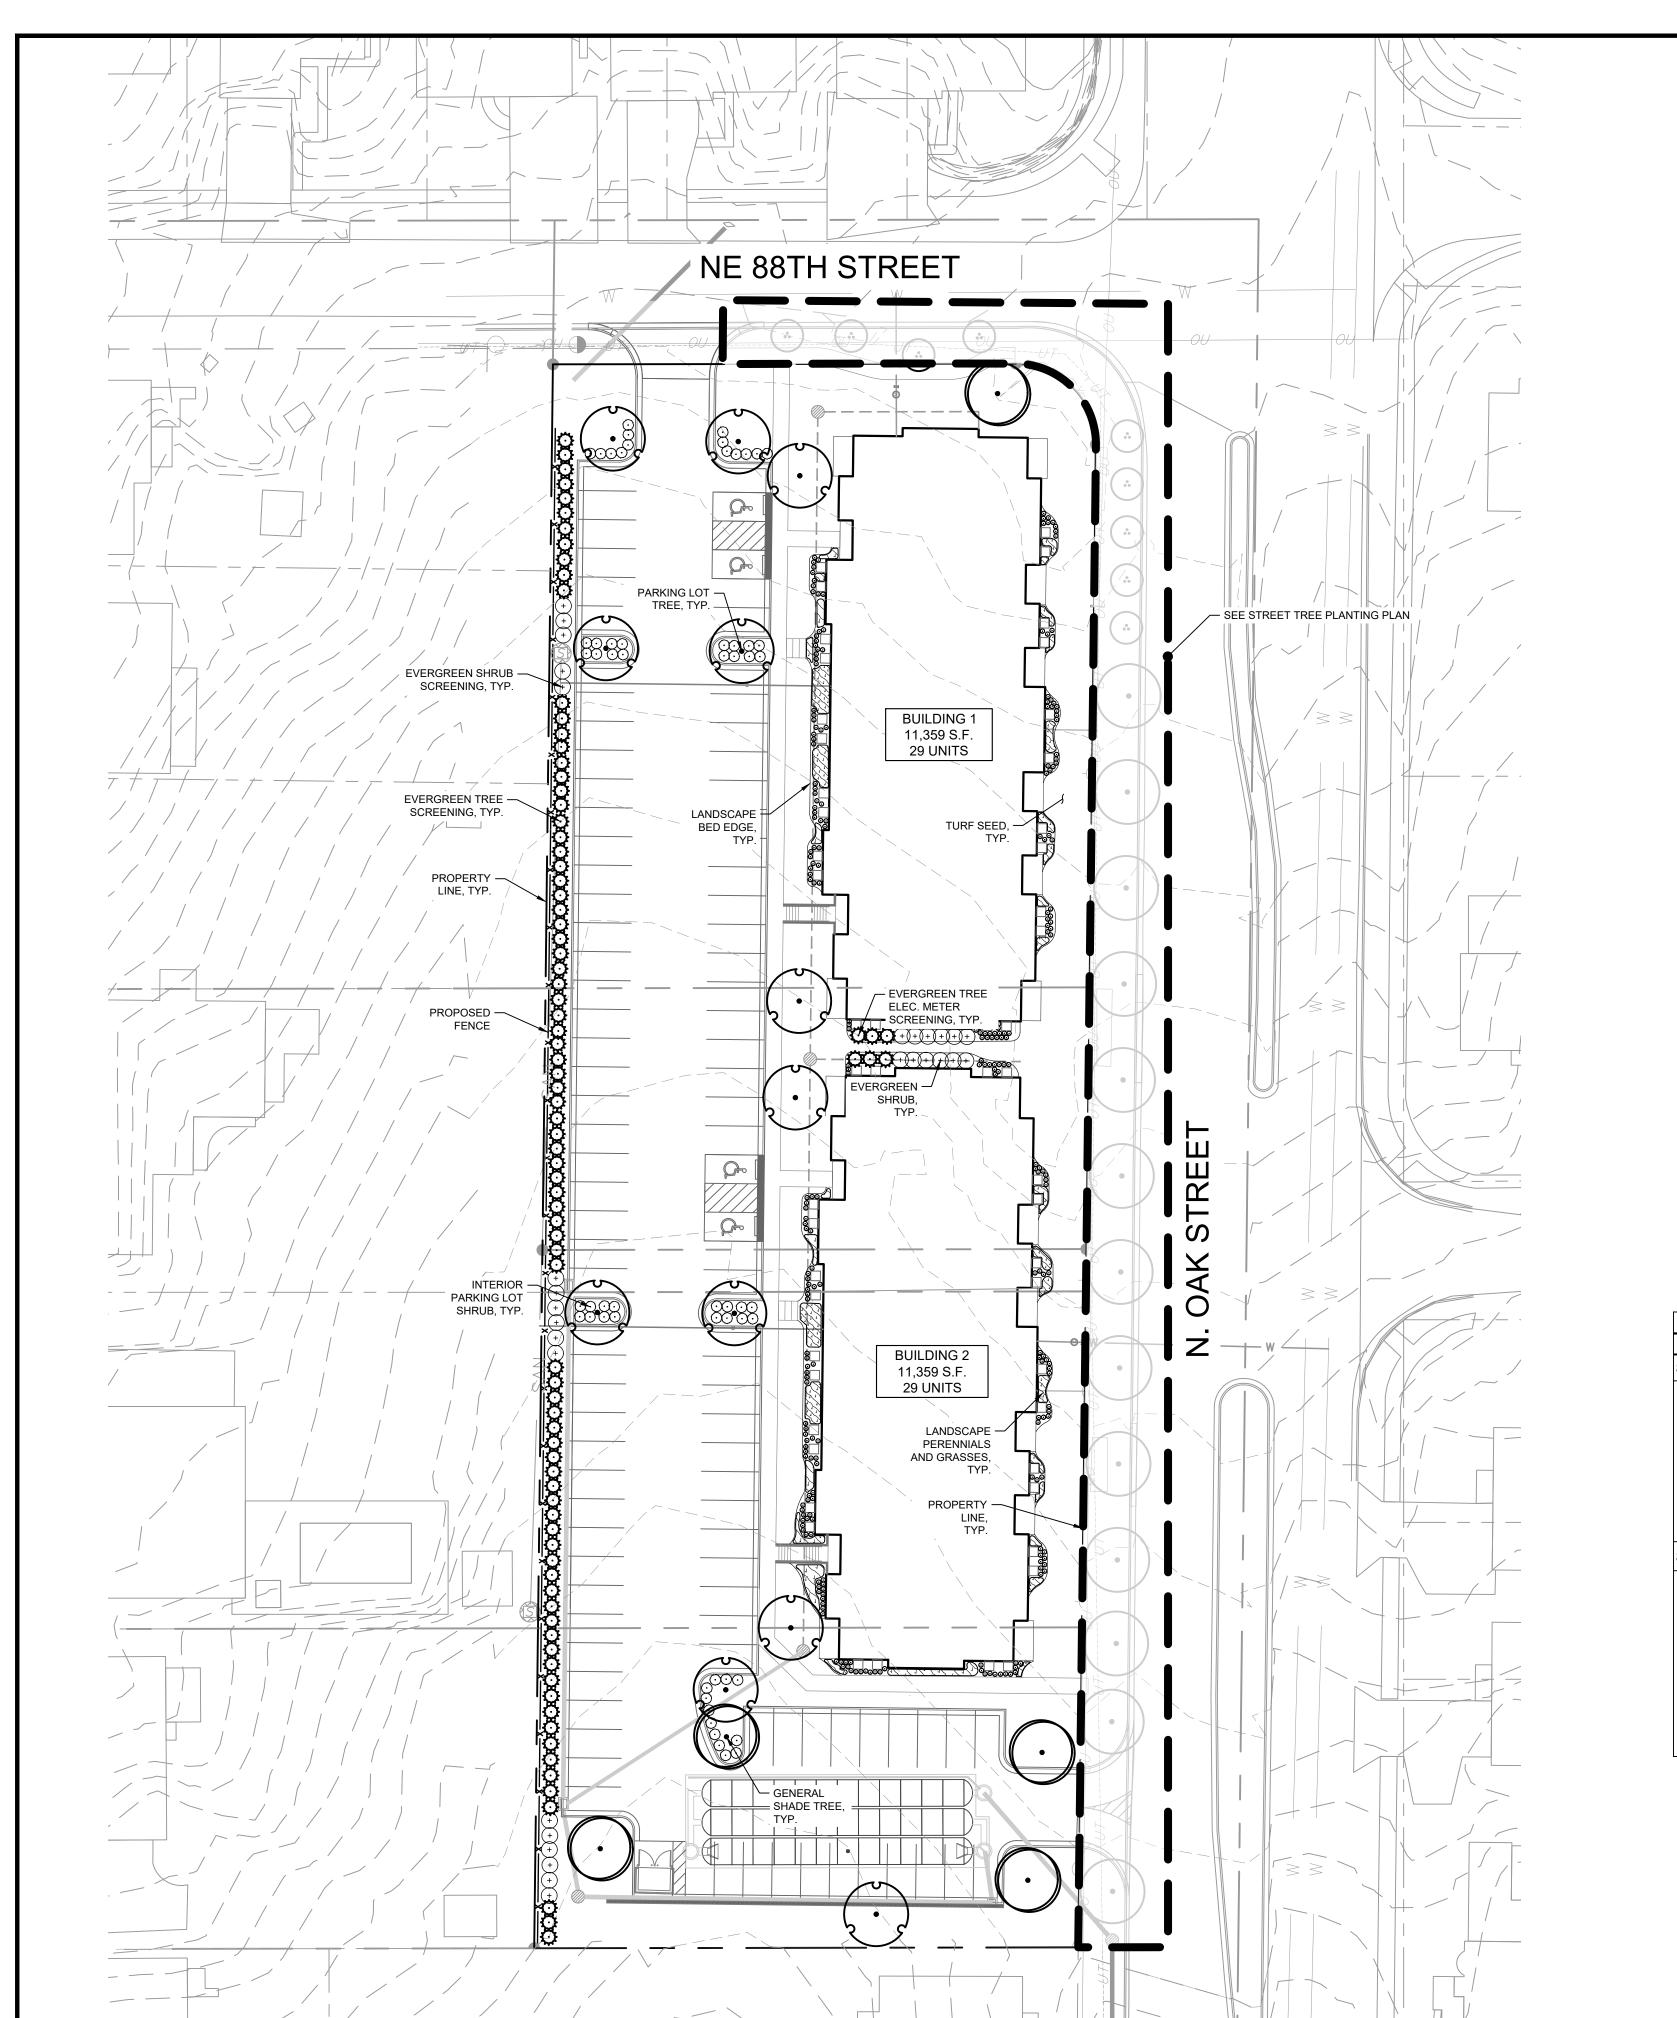

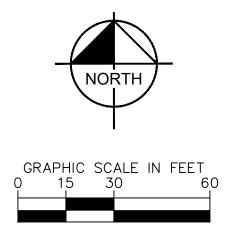

CONCEPT PLANT SCHEDULE

 \bigcirc

GENERAL SHADE TREE
ACER RUBRUM
QUERCUS ROBUR
GINKGO BILOBA

PARKING LOT TREE
QUERCUS ROBUR
GINKGO BILOBA
GLEDITSIA TRIACANTHOS
GYMNOCLADUS DIOICUS
QUERCUS RUBRA
QUERCUS BICOLOR

EVERGREEN TREE
JUNIPEROUS SCOPULORUM X
'SKYROCKET'
JUNIPEROUS CHINESIS X 'SPARTAN'
CHAMAECYPARIS OBTUSA X
'GRACILIS'

 \odot

INTERIOR PARKING LOT SHRUB
SPIRAEA JAPONICA
ARONIA MELANOCARPA
CEANOTHUS AMERICANUS
FORSYTHIA

(+) <u>EVERGREEN SHRUB</u> TAXUS X MEDIA BUXUS

SCREENING GRASS 255

764

PERENNIALS AND GRASSES

	KC, MO LANDSCAPE CODE		
ZONING ORDINANCE	REQUIREMENT	PROVIDED	
3-425-04-D GENERAL LANDSCAPE REQUIREMENTS			
AT LEAST ONE TREE IS REQUIRED PER 5,000 SQUARE FEET OF PRINCIPAL BUILDING COVERAGE (BUILDING FOOTPRINT). PLANTED IN SETBACKS AND OPEN SPACE AREAS.	BUILDING 1 - 11,359 S.F. BUILDING 2 - 11,359 S.F. TOTAL FOOTPRINT - 22,718 S.F. 22,718/ 5,000 = 4.54 TREES 5 TREES	5 TREES PROVIDED.	
3-425-06 - INTERIOR LANDSCAPING OF PARKING LOTS			
T LEAST 35 S.F. OF INTERIOR LANDSCAPE AREA MUST BE PROVIDED FOR EACH PARKING SPACES	58 PARKING SPACES 58/5 = 11.6 12 TREES	12 TREES PROVIDED IN INTERIOR PARKING	
AND ONE SHRUB PER PARKING SPACE. GROUND COVER PLANTS MUST COVER ALL INTERIOR LANDSCAPE AREAS.	58 PARKING SPACES 58 SHRUBS	58 INTERIOR SHRUBS PROVIDED	

INC.

No. REVISIONS

O3/18/2023

FD KIMLEY—HORN AND ASSOCIATES, INC 805 PENNSYLVANIA AVENUE, SUITE 150 KANSAS CITY, MO 64105 PHONE: 816–652–0350 WWW.KIMLEY—HORN.COM MO CERTIFICATE OF AUTHORITY #001512, EXPIRES 12/31/22

DESIGNED BY: PD
DRAWN BY: PD
CHECKED BY: MK


construction construction


ANDSCAPE PI AN


NORTH OAK TRAFFICWAY
APARTMENTS


ORIGINAL ISSUE: 02.14.2022 KHA PROJECT NO. 268131000

SHEET NUMBER

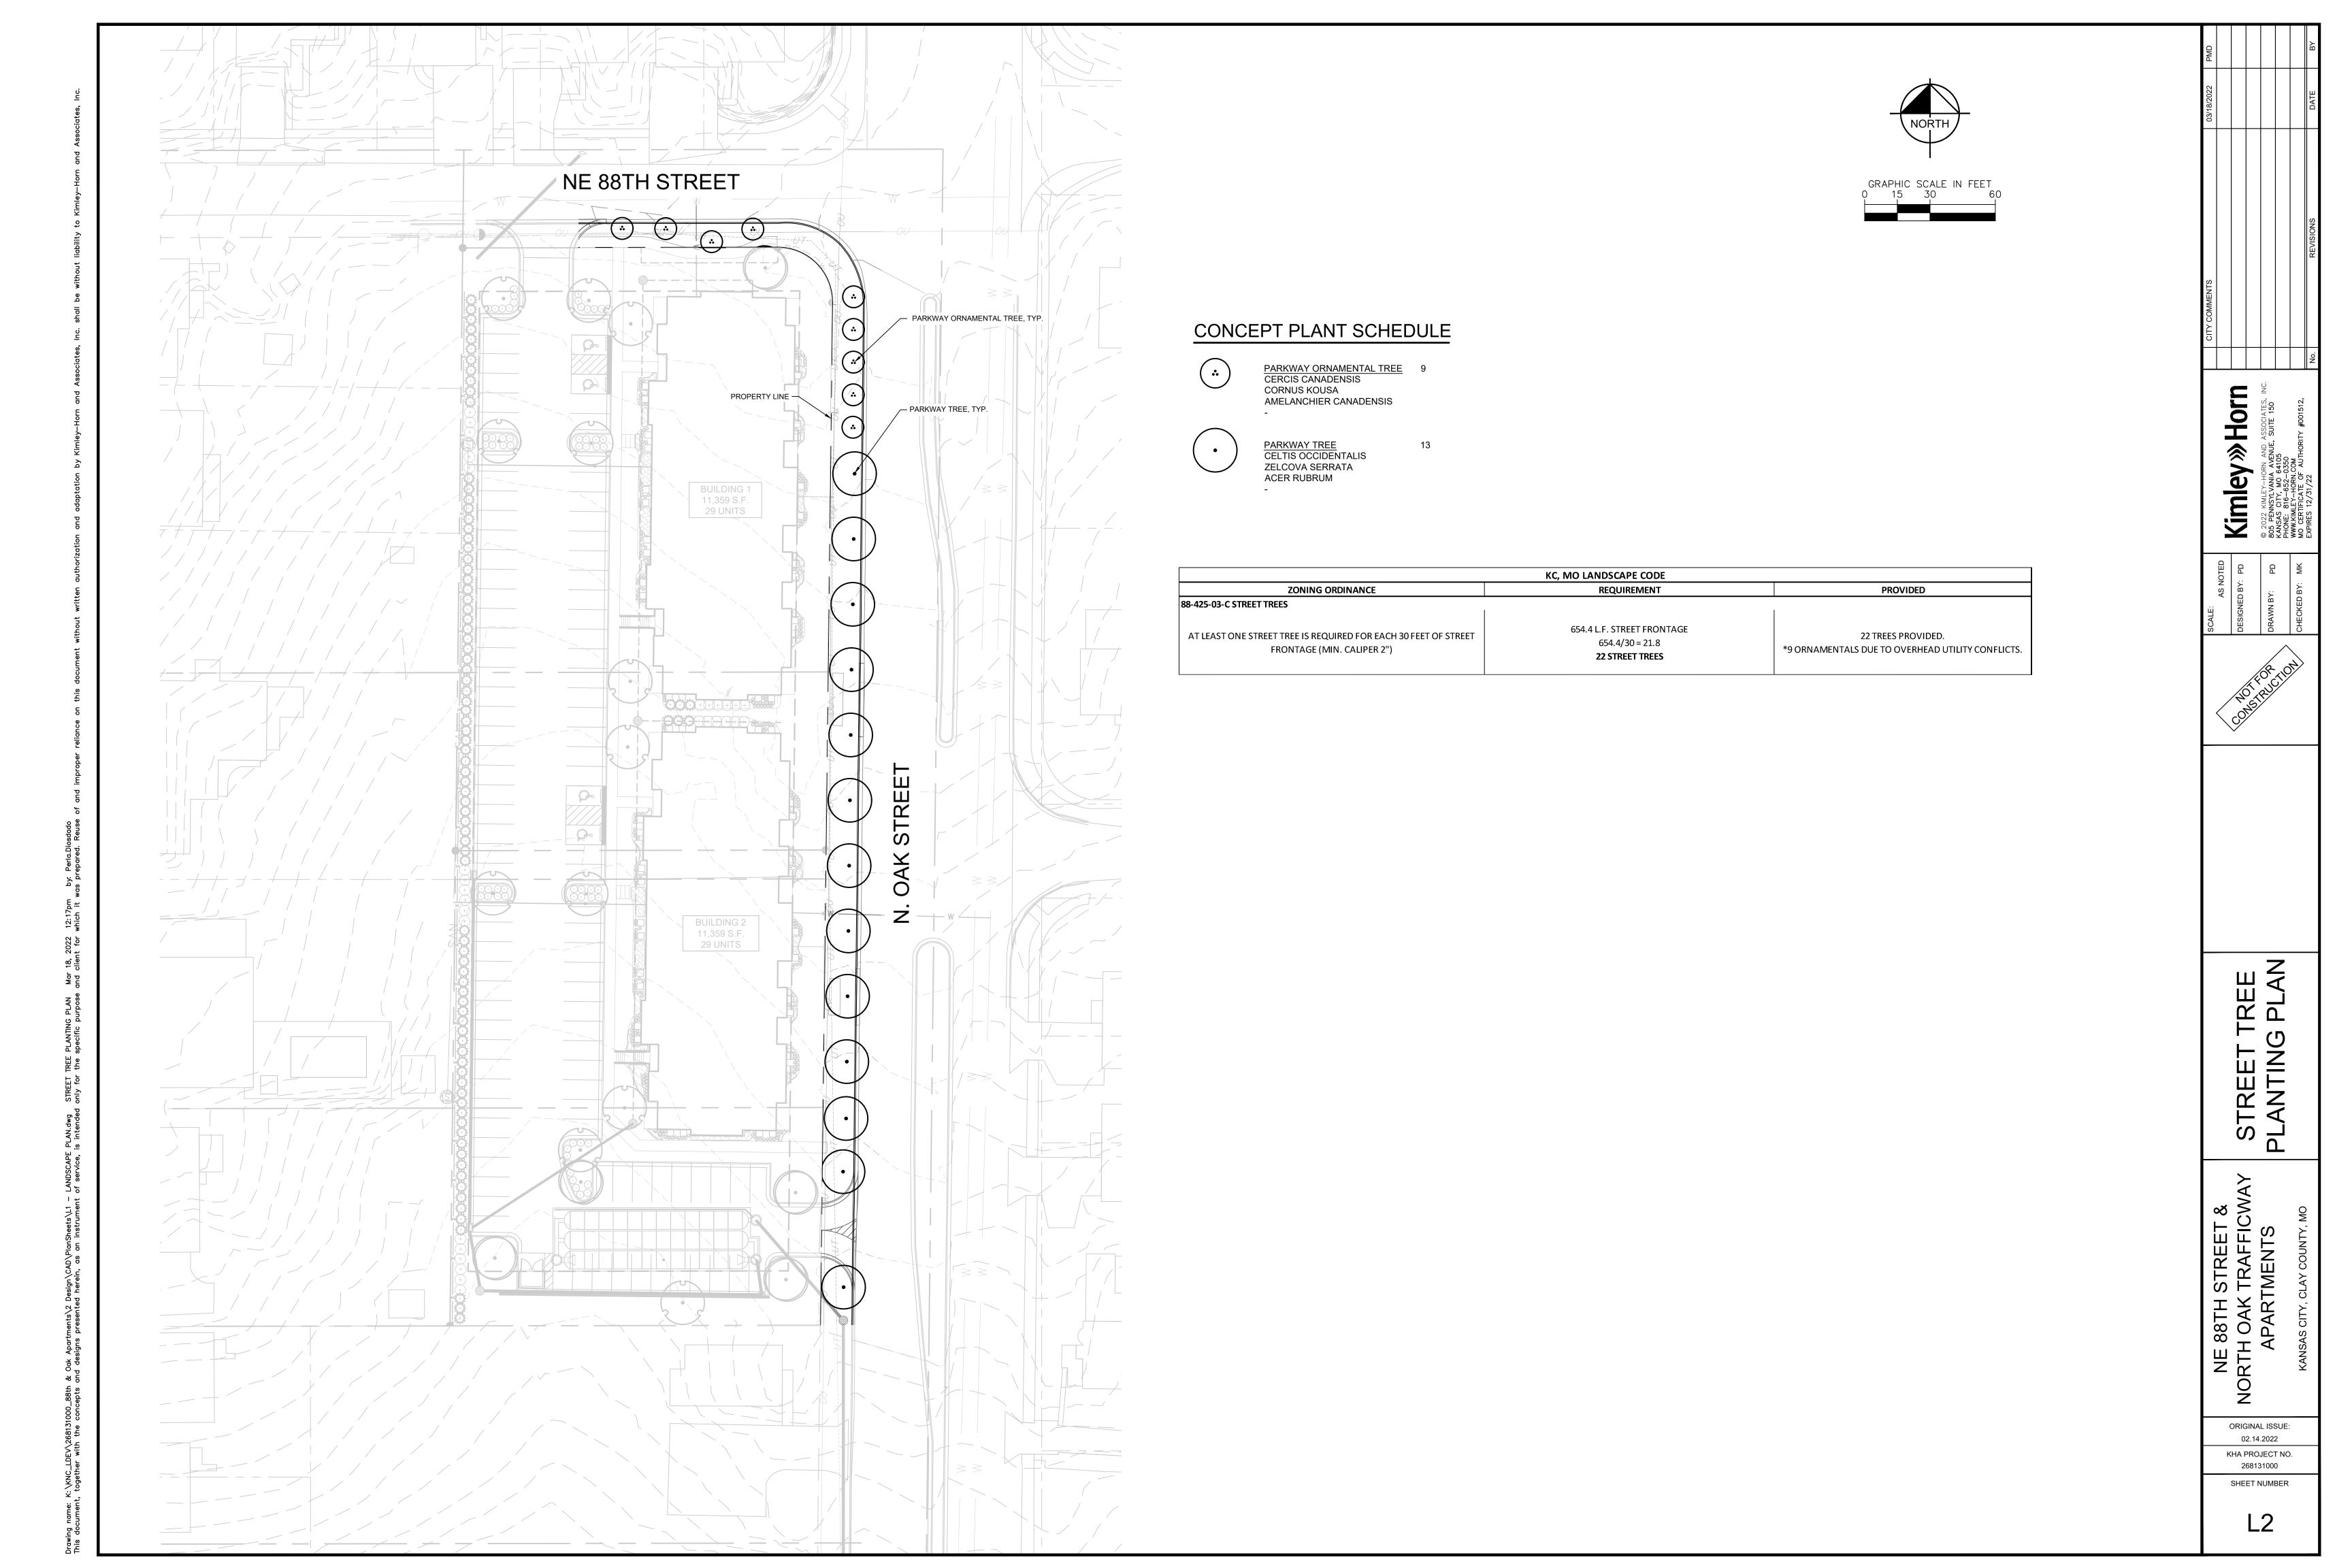

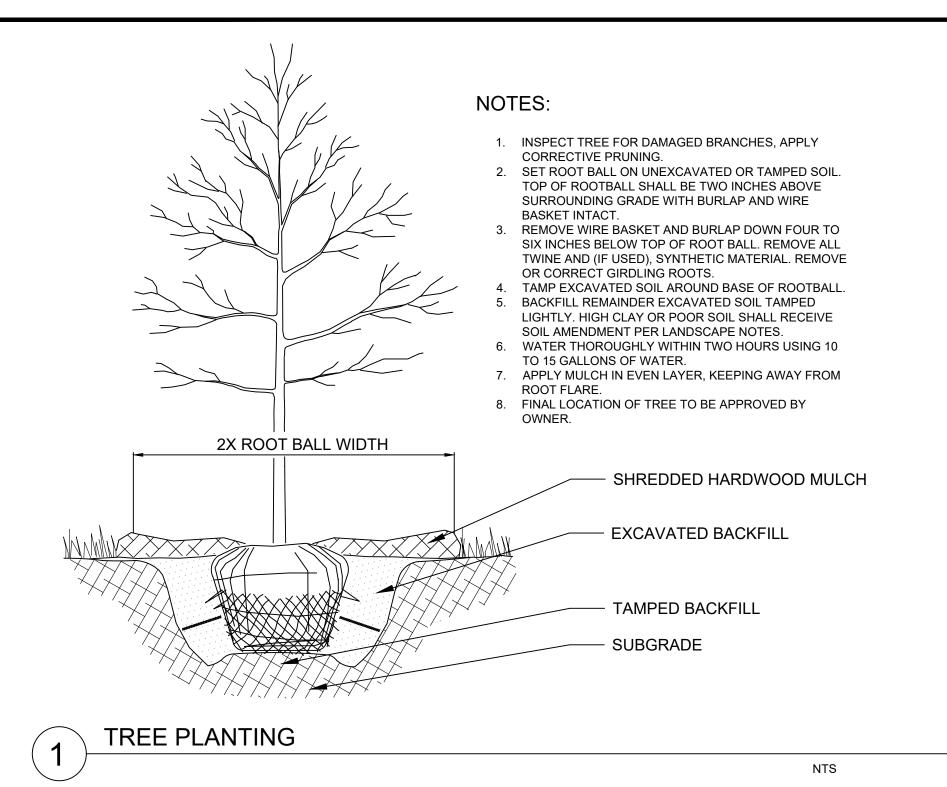

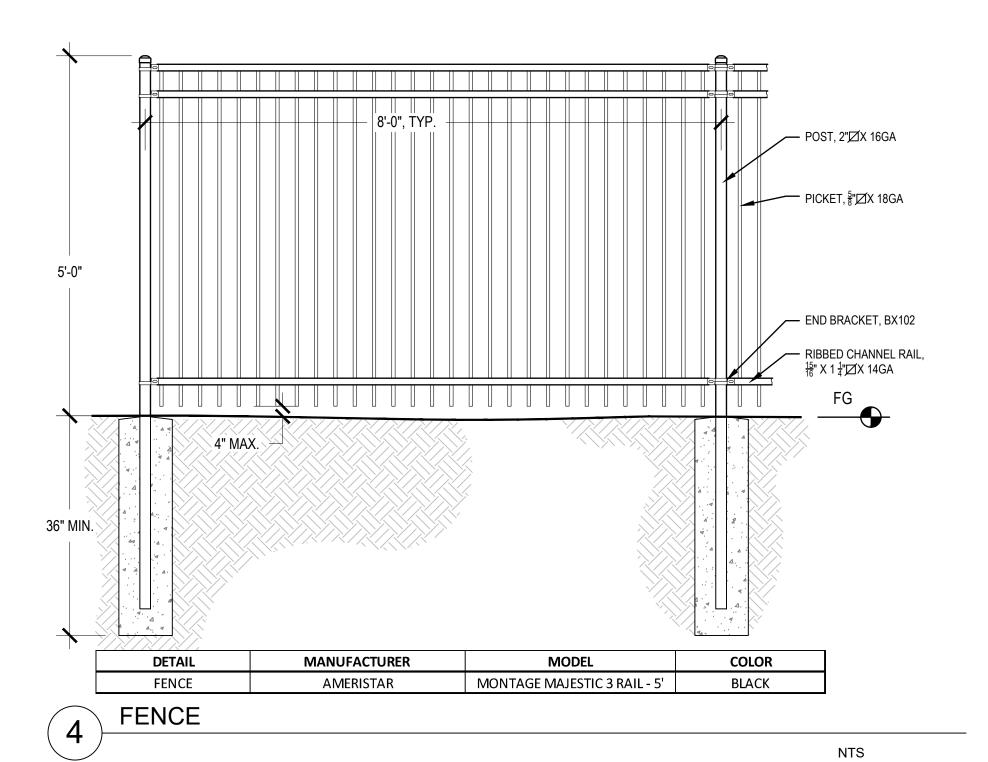

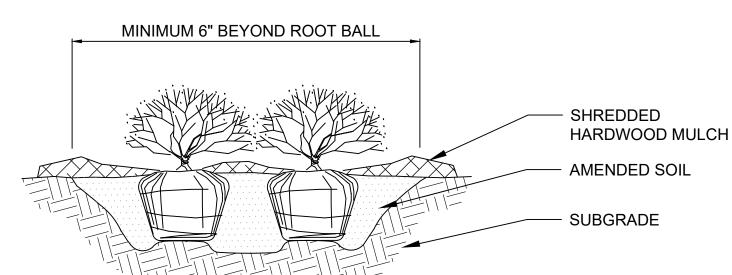

NOTES:

- APPLY CORRECTIVE PRUNING.
- 2. SET ROOT BALL OR CONTAINER ON UNEXCAVATED OR TAMPED SOIL. TOP OF ROOTBALL (CONTAINER) SHALL BE ONE INCH ABOVE SURROUNDING GRADE. FOR LARGER SHRUBS WITHIN PLANTING BED DIG A DEEPER PIT ONLY FOR THOSE SHRUBS
- 3. REMOVE BURLAP FROM TOP HALF THE LENGTH OF ROOTBALL. TWINE AND (IF USED) SYNTHETIC MATERIAL SHALL BE REMOVED FROM PLANTING BED. FOR CONTAINER GROWN SHRUBS, REMOVE CONTAINER AND LOOSEN ROOTS PRIOR TO INSTALLATION. REMOVE OR CORRECT GIRDLING ROOTS.
- 5. PLUMB AND BACKFILL WITH AMENDED SOIL PER LANDSCAPE NOTES. WATER THOROUGHLY WITHIN
- 6. APPLY MULCH IN EVEN LAYER, KEEPING AWAY FROM ROOT FLARE. MULCH LIMITS FOR SHRUBS
- EXTEND TO ALL LIMITS OF PLANTING BED, SEE PLANS FOR BED LAYOUTS.

SHRUB PLANTING

3. REMOVE CONTAINER, SCORE SOIL MASS TO REDIRECT AND PREVENT CIRCLING ROOTS. CORRECT GIRDLING ROOTS. 2. PLANT MATERIAL SHALL BE LAID OUT BY FOLLOWING THE BED EDGE, WORKING TOWARDS THE CENTER OF THE BED USING TRIANGULAR (STAGGERED) SPACING AS PLAUSIBLE. 3. PLUMB AND BACKFILL WITH PLANTING MIX AS SPECIFIED IN LANDSCAPE NOTES. 4. APPLY MULCH IN EVEN LAYER, KEEPING AWAY FROM ROOT FLARE. MULCH LIMITS FOR PERENNIALS/GROUNDCOVER EXTEND TO ALL LIMITS OF PLANTING BED, SEE PLANS FOR BED LAYOUTS. 5. SPACING TO BE AS SPECIFIED IN THE PLANT LIST. PERENNIALS SHALL BE PLACED WITH THEIR CENTER 24" FROM EDGE OF BED. O.C. SPACING, SEE PLANS FOR DETAILS

NOTES:

EXCAVATE PLANTING BED.

2. BED HEIGHT IS TO BE 2" ABOVE FINISH GRADE AND WELL DRAINED.

SHREDDED

HARDWOOD MULCH

SPADED BED EDGE AMENDED SOIL SUBGRADE **SECTION PLAN VIEW**

PERENNIAL PLANTING

LANDSCAPE NOTES

- 1. THE LANDSCAPE CONTRACTOR SHALL BE RESPONSIBLE FOR INSTALLING MATERIALS AND PLANTS SHOWN ON THE LANDSCAPE PLAN. THE CONTRACTOR IS RESPONSIBLE FOR THE COST TO REPAIR UTILITIES, ADJACENT LANDSCAPE, PUBLIC AND PRIVATE PROPERTY THAT IS DAMAGED BY THE CONTRACTOR OR THEIR SUBCONTRACTOR'S OPERATIONS DURING INSTALLATION OR DURING THE SPECIFIED MAINTENANCE PERIOD. CALL FOR UTILITY LOCATIONS PRIOR TO ANY EXCAVATION.
- 2. THE CONTRACTOR SHALL REPORT ANY DISCREPANCY IN PLAN VS. FIELD CONDITIONS IMMEDIATELY TO THE LANDSCAPE ARCHITECT, PRIOR TO CONTINUING WITH THAT PORTION OF
- 3. NO PLANTING WILL BE INSTALLED UNTIL ALL GRADING AND CONSTRUCTION HAS BEEN COMPLETED IN THE IMMEDIATE AREA.
- 4. THE CONTRACTOR SHALL BE RESPONSIBLE FOR THE REPAIR OF ANY OF THEIR TRENCHES OR **EXCAVATIONS THAT SETTLE.**
- 5. ALL PLANTS TO BE SPECIMEN GRADE, WELL BRANCHED, HEALTHY, FULL, PRE-INOCULATED AND FERTILIZED. PLANTS SHALL BE FREE FROM DISEASE, PESTS, WOUNDS, AND SCARS. PLANTS SHALL BE FREE FROM NOTICEABLE GAPS, HOLES, OR DEFORMITIES. PLANTS SHALL BE FREE FROM BROKEN OR DEAD BRANCHES. TRUNKS WILL BE WRAPPED IF NECESSARY TO PREVENT SUN SCALD AND INSECT DAMAGE. THE LANDSCAPE CONTRACTOR SHALL REMOVE THE WRAP AT THE PROPER TIME AS PART OF THIS CONTRACT.
- THE OWNER'S REPRESENTATIVE MAY REJECT ANY PLANT MATERIALS THAT ARE DISEASED. DEFORMED, OR OTHERWISE NOT EXHIBITING SUPERIOR QUALITY.
- 7. ALL NURSERY STOCK SHALL BE GUARANTEED, BY THE CONTRACTOR, FOR ONE YEAR FROM DATE OF FINAL INSPECTION. THE GUARANTEE BEGINS ON THE DATE OF THE LANDSCAPE ARCHITECT'S OR OWNERS WRITTEN ACCEPTANCE OF THE INITIAL PLANTING. REPLACEMENT PLANT MATERIAL SHALL HAVE A ONE YEAR GUARANTEE COMMENCING UPON PLANTING.
- 8. PLANTS TO MEET AMERICAN STANDARD FOR NURSERY STOCK (ANSI Z60.1-2014 OR MOST CURRENT VERSION) REQUIREMENTS FOR SIZE AND TYPE SPECIFIED.
- 9. PRUNE PLANTS AS NECESSARY- PER STANDARD NURSERY PRACTICE AND TO CORRECT POOR BRANCHING OF EXISTING AND PROPOSED TREES.
- 10. TOPSOIL SHALL BE PROVIDED AND GRADED BY THE GENERAL CONTRACTOR UP TO 6 INCHES BELOW FINISHED GRADE IN TURF AREAS AND 18 INCHES IN PLANTING AREAS.
- 11. PLANTING AREA TOPSOIL SHALL BE AMENDED WITH 25% SPHAGNUM PEATMOSS, 5% HUMUS AND 70% PULVERIZED SOIL FOR ALL NON TURF SEED MIX AREAS, SHRUB, ORNAMENTAL GRASS, PERENNIAL AND ANNUAL BEDS.
- 12. SEED/SOD LIMIT LINES ARE APPROXIMATE. CONTRACTOR SHALL SEED/SOD ALL AREAS WHICH ARE DISTURBED BY GRADING WITH THE SPECIFIED SEED/SOD MIXES.
- 13. EDGING TO BE A SPADED EDGE UNLESS INDICATED OTHERWISE ON THE PLANS. SPADED EDGE TO PROVIDE V-SHAPED DEPTH AND WIDTH TO CREATE SEPARATION BETWEEN MULCH AND GRASS. A SPADED BED EDGE SHALL SEPARATE MULCH BEDS FROM TURF OR SEEDED AREAS. A SPADED EDGE IS NOT REQUIRED ALONG CURBED EDGES.
- 14. CONTRACTOR SHALL INSTALL SHREDDED HARDWOOD MULCH AT A 3" DEPTH TO ALL TREES, SHRUB, PERENNIAL, AND GROUNDCOVER AREAS. TREES PLACED IN AREA COVERED BY TURF SHALL RECEIVE A 4 FT WIDE MAXIMUM TREE RING WITH 3" DEPTH SHREDDED HARDWOOD MULCH.
- 15. INSTALLATION OF TREES WITHIN PARKWAYS SHALL BE COORDINATED IN THE FIELD WITH LOCATIONS OF UNDERGROUND UTILITIES. TREES SHALL NOT BE LOCATED CLOSER THAN 5' FROM UNDERGROUND UTILITY LINES AND NO CLOSER THAN 10' FROM UTILITY STRUCTURES.
- 16. DO NOT DISTURB THE EXISTING PAVING, LIGHTING, OR LANDSCAPING THAT EXISTS ADJACENT TO THE SITE UNLESS OTHERWISE NOTED ON PLAN.
- 17. ALL DISTURBED AREAS TO BE SODDED OR SEEDED, UNLESS OTHERWISE NOTED. SOD/SEED
- SHALL BE LOCAL HARDY TURF GRASS MIX UNLESS, OTHERWISE NOTED.
- 18. PLANT QUANTITIES SHOWN ARE FOR THE CONVENIENCE OF THE OWNER AND JURISDICTIONAL REVIEW AGENCIES. THE CONTRACTOR IS RESPONSIBLE FOR VERIFYING ALL PLANT QUANTITIES AS DRAWN.

≫ Hor

STREET 88TH HOAK APART

ORIGINAL ISSUE: 02.14.2022 KHA PROJECT NO. 268131000

SHEET NUMBER



MATERIAL KEY







CEMENTITIOUS BOARD AND BATTEN PAINTED GREY

(1) WHITE VINYL WINDOW

KEY NOTES

- PREFINISHED ALUMINUM BALCONY RAILINGS PAINTED BLAC
- ALUMINUM STOREFRONT WINDOWS PAINTED BLACK
- 4) CEMENTITIOUS ROOF AND BALCONY FASCIAS
- MECHANICAL EQUIPMENT LOCATED AT GRADE

NORTH

1/8" = 1'-0"

SOUTH 1/8" = 1'-0"



2 EAST (FRONT)
1/8" = 1'-0"



WEST (BACK)

1/8" = 1'-0"

PDP RE-SUBMITTAL

K ST.
KANSAS CITY, MO

PRAWING RELEASE LOG

• 02.14.22 - PDP SUBMITTAL

DATE:
03/04/2022
JOB NO.
709022
DRAWN BY:
BHALL
SHEET NO.

A₁

FROM 88TH AND N. OAK LOOKING SOUTH



FROM PARKING LOOKING SOUTHEAST

CITY, MO OA AND **88TH**

88TH

DRAWING RELEASE LOG

• 02.14.22 - PDP SUBMITTAL

 \triangle REVISIONS:

DATE:

03/04/2022 JOB NO. 709022 DRAWN BY: Author SHEET NO.

ARCHITECTS PA 3515 W. 75TH ST., SUITE 201 PRAIRIE VILLAGE, KS 66208

FROM STREET LOOKING NORTH WEST



BUILDING ENTRY



DRAWING RELEASE LOG

• 02.14.22 - PDP SUBMITTAL

 \triangle REVISIONS:

DATE:

JOB NO.
709022
DRAWN BY:
Author
SHEET NO.

03/04/2022

ARCI 3515 W. 7


SITE LIGHT FIXTURE SCHEDULE													
MADK MA		MANUFACTURE	MODEL NUMBER	T .	MOUNTING		FINICH	LAMPS				DEMANDIC	
MARK	IVIAKK	MANUFACTURE	MODEL NUMBER	RECESS	SURFACE	WALL	FINISH	LED	FLOUR.	HID	CODE	QUANTITY	REMARKS
	SL1	MCGRAW EDISON	GWC-AF-02-LED-E1-T4FT-1200			X	BLACK	X			13,709LUM/129W	1	1, 2
	SL2	MCGRAW EDISON	GWC-AF-02-LED-E1-SL2-1200			X	BLACK	X			13,350LUM/129W	1	1, 2


REMARKS:

1 WALL MOUNTED 18' AFF.

2 4000 K

STATISTICS									
Description	Avg	Max	Min	Max/Min	Avg/M				
PROPERTY LINE	0.0 FC	0.1 FC	0.0 FC	N/A	N/A				
PARKING LOT	1.4 FC	5.7FC	0.1 fc	57.0:1	14.0:1				

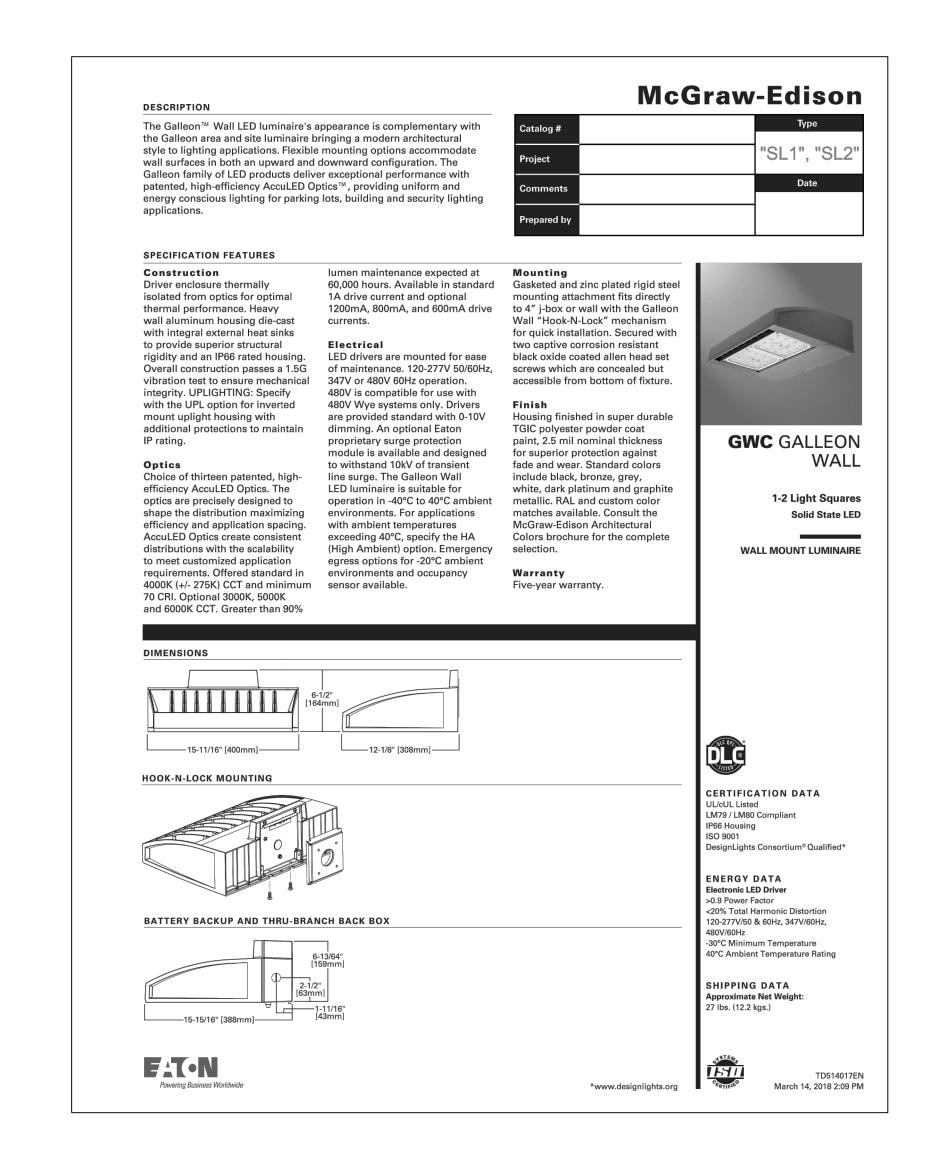


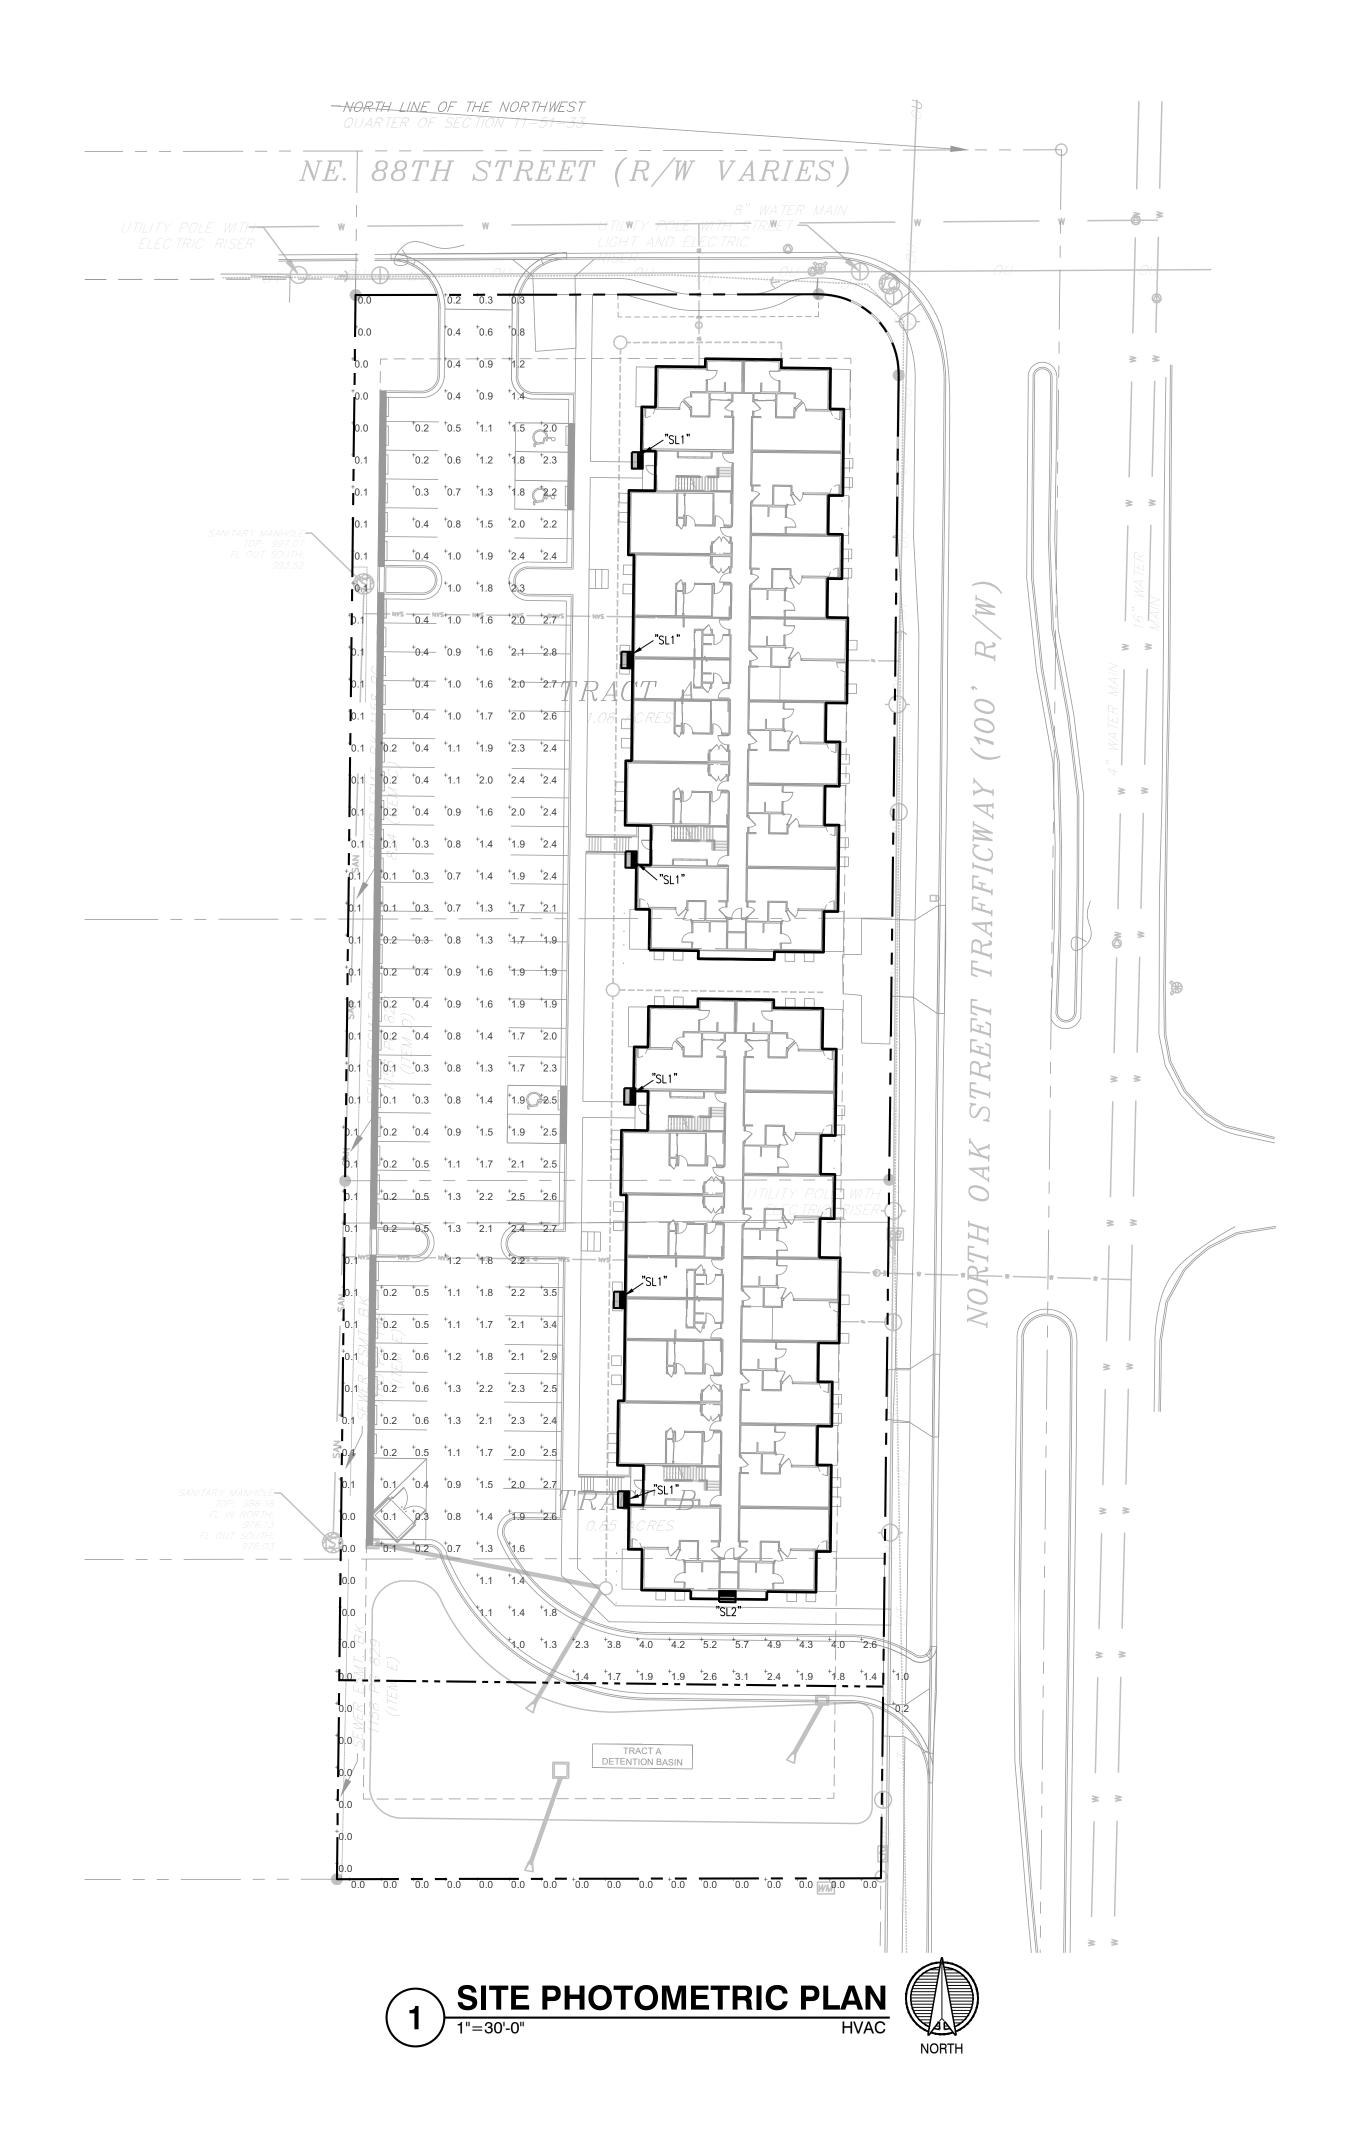







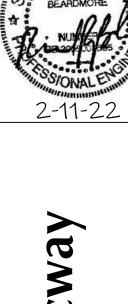

City 88th

DRAWING RELEASE LOG

REVISIONS:

DATE: 02-14-2022 JOB NO. 709022 DRAWN BY: CAD/KRW SHEET NO.