

# CITY PLAN COMISSION REPORT

City of Kansas City, Missouri
City Panning & Development Department
www.kcmo.gov/cpc

### Project Name 88th & North Oak Apartments

Hearing Date April 5, 2022

Docket # Request

8 CD-CPC-2022-00017 Development Plan

(residential)

**Applicant** 

Rachelle Biondo

Rouse Frets White Goss Gentile Rhodes

Owner

8728 N Oak LLC 2002 Burlington St. Kansas City, MO 64116

Location 8716 & 8728 N Oak Trfy

Area 1.92 acres
Zoning R-1.5
Council District 2<sup>nd</sup>
County Clay

School District North Kansas City 250

### **Surrounding Land Uses**

North – residential use, zoned R-7.5

**South** – commercial and civic use, zoned B1-1

**East** – residential use zoned R-7.5 **West** – residential use zoned R-7.5

### Land Use Plan

The Gashland/Nashua Area Plan recommends residential low density. The current zoning does not comply with the recommended future land use; however, Long Range Planning only requires an area plan amendment if the zoning is being changed. There is not request for a rezoning in this case.

### **Major Street Plan**

N Oak is designated as a Thoroughfare at this location according to the Major Street Plan.

### APPROVAL PROCESS



### NEIGHBORHOOD AND CIVIC ORGANIZATIONS NOTIFIED

No registered neighborhood or civic organizations were found at this location. Notice of the public hearing was sent to surrounding properties within 300 feet.

### REQUIRED PUBLIC ENGAGEMENT

Public engagement as required by 88-505-12 applies to this request. The applicant hosted a public meeting on March 8, 2022. A summary of the meeting is attached to this report. The applicant team had an additional public meeting on March 29, 2022.

### **EXISTING CONDITIONS**

The subject site is two currently separate parcels that are residentially zoned. The land is currently vacant and mostly surrounded by single family homes. There is a recently approved rezoning to allow for a coffee shop on the parcel directly to the south.

### **SUMMARY OF REQUEST**

CD-CPC-2022-00017 - A request to approve a development plan for two multi-family residential buildings to contain a total of 56 units on about 1.92 acres generally located at the southwest corner of NE 88th Street and N Oak Trafficway.

### **KEY POINTS**

• Residential Development Plan

### PROFESSIONAL STAFF RECOMMENDATION

Docket # Recommendation

8 Approval with conditions

### **CONTROLLING CASE**

No controlling case was found.

### **RELATED RELEVANT CASES**

No relevant cases found.

### **HISTORY**

The two parcels previously contained single family homes but appear to be demolished sometime between 2018 and 2021.

### **PLAN REVIEW**

The proposed plan consists of two, two-story multi-family residential buildings to contain a total of 56 units. Each building will be approximately 11,000 square feet, and front N Oak Trfy. Proposed parking will be to the rear of the building, adjacent to the single-family homes on McGee St. There are 103 parking spaces proposed. The site will be accessible from NE 88th St. Additionally, there will be a right-in and right-out only exit on the southern portion of the lot onto N Oak Trfy. Pedestrian sidewalks are proposed between in the buildings and the parking lot, as well as to the north and south of the buildings.

Landscaping and decorative fencing is shown on the plans to screen the parking lot from the residences to the west. Street trees and interior landscaping are shown in the parking lot, around the propose buildings, the street side yard bordering N Oak Trfy, and between the 2 buildings.

Proposed elevations show the use of cementitious lap siding, cementitious board and batten, and stone veneer building materials. Architectural articulation is provided with the varying roofline and building setbacks.

Use-Specific (88-300) and Development Standards (88-400)

Standards	Applicability	Meets	More Information
Boulevard and Parkway Standards (88-323)	No	N/A	
Parkland Dedication (88-408)	Yes	Subject to conditions	
Parking and Loading Standards (88-420)	Yes	Yes	
Landscape and Screening Standards (88-425)	Yes	Subject to conditions	Landscaping affidavit required prior to Certificate of Occupancy.
Outdoor Lighting Standards (88-430)	Yes	Yes	
Sign Standards (88-445)	Yes	Subject to conditions	All future proposed signage shall comply with 88-445.
Pedestrian Standards (88-450)	Yes	Yes	

### **PLAN ANALYSIS**

### Plan Review Criteria (88-516-05)

In order to be approved, the plan must comply with all of the following criteria:

88-516-05-A. The plan must comply with all standards of this zoning and development code and all other applicable city ordinances and policies, (Note: this provision is not intended to prohibit an applicant from seeking a variance or other form of relief authorized under this zoning and development code or other applicable ordinances, when authorized.)

The development plan does not comply with the lot and building standards in an R-1.5 district for the minimum lot area per unit. The applicant has worked with staff to reduce the number of units from 58 to 56, but a deviation of 365 square feet is required, and being requested by the applicant. Other than this deviation, the plan complies with the zoning and development code, subject to the conditions attached to this report.

88-516-05-B. The proposed use must be allowed in the district in which it is located.

Multi-unit residential uses/buildings are permitted in this zoning district.

88-516-05-C. Vehicular ingress and egress to and from the site, and circulation within the site must provide for safe, efficient and convenient movement of traffic not only within the site but on adjacent roadways.

Proposed ingress and egress from the site is located on NE 88<sup>th</sup> St. This curb cut will provide access to the parking to the rear of the proposed buildings. Additionally, there will be a right-in and right-out only curb cut on the southern portion of the site.

88-516-05-D. The plan must provide for safe, efficient, and convenient non-motorized travel opportunities, being pedestrian and bicycle movement, on the subject site.

The applicant is proposing sidewalk extensions to accommodate pedestrians around the entire building. Bicycle parking will also be available.

88-516-05-E. The plan must provide for adequate utilities based on City standards for the particular development proposed.

Existing utilities will be extended accommodate the development

88-516-05-F. The location, orientation, and architectural features, including design and material, of buildings and other structures on the site must be designed to be compatible with adjacent properties.

The proposed architecture of the buildings is comparable to the character of the existing single-family housing in the area. Building materials include both earth tone stone veneer and neutral colored siding.

88-516-05-G. Landscaping, berms, fences and/or walls must be provided to buffer the site from undesirable views, noises, lighting or other off-site negative influences and to buffer adjacent properties from negative influences that may be created by the plan.

The plan proposes to variety of trees and shrubs to properly screen vehicular areas and meet the Code requirements for street trees and interior landscaping.

88-516-05-H. The design of streets, drives, and parking areas within the project should result in a minimum of area devoted to asphalt or other impervious surfaces consistent with the needs of the project and city code requirements.

The proposed development will increase the impervious surface on the site. There is a proposed underground detention basin under the south portion of parking lot to accommodate stormwater runoff.

88-516-05-I. The plan must identify trees to be removed and trees to be preserved during the development of the subject property with the goal of saving trees that are not required to be removed for the development of the property.

Any trees currently on the site will be removed to allow for the buildings and parking lot.

### PROFESSIONAL STAFF RECOMMENDATION

Based on the applications submitted by the applicant, staff recommends **APPROVAL WITH CONDITIONS** as stated in the Conditions Report

Respectfully submitted,

Genevieve Kohn Staff Planner

Denne Kohn

### **Plan Conditions**



Report Date: March 31, 2022

Case Number: CD-CPC-2022-00017

Project: 88th and North Oak Apartments

Condition(s) by City Planning and Development Department. Contact Genevieve Kohn at (816) 513-8808 / Genevieve.Kohn@kcmo.org with questions.

- 1. The developer shall secure approval of a street tree planting plan from the City Forester and plant according to said plan prior to Certificate of Occupancy.
- 2. The developer shall submit an affidavit, completed by a landscape architect licensed in the State of Missouri, verifying that all landscaping required of the approved plan has been installed in accordance with the plan and is healthy prior to Certificate of Occupancy.
- 3. That all signage shall conform to 88-445 and shall require a sign permit prior to installation.
- 4. The developer shall submit an affidavit, completed by a landscape architect licensed in the State of Missouri, verifying that street trees have been installed in accordance with the approved street tree planting plan and are healthy prior to Certificate of Occupancy.
- 5. That the developer shall submit an affidavit, prepared by an engineer licensed in the State of Missouri, verifying that all outdoor lighting has been installed in accordance with approved plans and that lighting levels do not exceed that shown on the approved lighting plan at the property lines prior to Certificate of Occupancy.
- 6. The developer shall combine the parcels via minor subdivision or deeds.
- 7. Dumpster enclosures shall be constructed of decorative split-face block or other similar, complementary, material to the residential buildings.
- 8. Meet the Long-Term Bicycle Parking requirement in 88-420-09-C. One space per 3 units (18 total spaces)

Condition(s) by City Planning and Development Department. Contact Lucas Kaspar at (816) 513-2558 / Lucas.Kaspar@kcmo.org with questions.

- 9. The developer shall submit a detailed Micro storm drainage analysis from a Missouri-licensed civil engineer to the Land Development Division showing compliance with current adopted standards in effect at the time of submission, including Water Quality BMP's, prior to approval and issuance of any building permits to construct improvements on the site. The developer shall verify and/or improve downstream conveyance systems or address solutions for impacted properties due to flow contributions from the site; and that the developer construct any other improvements as required by Land Development Division as necessary to mitigate impacts from rate, volume, and quality of runoff from each proposed phase.
- 10. The developer shall submit verification of vertical and horizontal sight distance for the drive connection to public right-of-way to the Land Development Division and make improvements to ensure local jurisdiction and/or minimum AASHTO adequate sight distance standards are met, prior to issuance of any certificate of occupancy.
- 11. The developer must pay impact fees as required by Chapter 39 of the City's Code of ordinances as required by the Land Development Division.
- 12. That the South half of NE 88th Street shall be improved to current standards as required by Chapter 88, to current standards, including curbs and gutters, sidewalks, street lights, relocating any utilities as may be necessary and adjusting vertical grades for the road, etc., and obtaining required permit from Land Development Division for said improvement prior to issuance of a Building Permit.
- 13. The developer shall submit plans to Land Development Division and obtain permits to construct sidewalks along the platted frontage, and construct associated ADA ramps at the proposed entrance drives as necessary for the type of drive approach.
- 14. The developer must grant a city approved pedestrian right-of-way easement, for the portions of the public sidewalks approved to be outside of the street right-of-way, to the City as required by the Land Development Division, prior to recording the plat.

Condition(s) by City Planning and Development Department. Contact Lucas Kaspar at (816) 513-2558 / Lucas.Kaspar@kcmo.org with questions.

- 15. The owner/developer must submit plans for grading, siltation, and erosion control to Land Development Division for review and acceptance, and secure a Site Disturbance permit for any proposed disturbance area equal to one acre or more prior to beginning any construction activities.
- 16. The developer shall submit an analysis to verify adequate capacity of the existing sewer system as required by the Land Development Division prior to issuance of a building permit to connect private system to the public sewer main and depending on adequacy of the receiving system, make other improvements may be required.
- 17. The developer must grant a BMP and/or Surface Drainage Easement to the City as required by the Land Development Division, prior to Certificate of Occupancy.

Condition(s) by Fire Department. Contact Michael Schroeder at (816) 513-4604 / michael.schroeder@kcmo.org with questions.

- 18. Fire Water Flow
- 19. Fire Hydrant
- 20. Fire Department Connection

Condition(s) by Parks & Recreation. Contact Justin Peterson at (816) 513-7599 / Justin.Peterson@kcmo.org with questions.

- 21. The developer shall submit a streetscape plan with street tree planting plan per 88-425-03 for approval and permitting by the Parks & Recreation Department's Forestry Division prior to beginning work in the public right-of-way
- 22. The developer shall pay money-in-lieu of parkland dedication fee in the amount of \$32,794.52 prior to Certificate of Occupancy for 56 multi-family residential units.

Condition(s) by Water Services Department. Contact Heather Massey at (816) 513-2111 / heather.massey@kcmo.org with auestions.

- 23. The developer shall ensure that water and fire service lines should meet current Water Services Department Rules and Regulations. Prior to C of O.
  - https://www.kcwater.us/wp-content/uploads/2019/04/2018-Rules-and-Regulations-for-Water-Service-Lines.pdf
- 24. The developer shall have a water flow test done to ensure there is adequate water pressure to serve the development. South of River contact –Sean Allen -816-513-0318

  North of River contact Todd Hawes 816-513-0296





# Public Meeting Summary Form

Project Case #
Meeting Date:
Meeting Location:
Meeting Time (include start and end time):
Additional Comments (optional):


# Meeting Sign-In Sheet

Project Name and Address		

Name	Address	Phone	Email
Theresa Durkin			
Joshua Huckabey			
Dave Evans			
Lavonne and Lowe	ell Oldehoff		
Kennth Bauman			

# DEVELOPMENT PLAN FOR NE 88TH STREET & NORTH OAK TRAFFICWAY APARTMENTS

SECTION 11, TOWNSHIP 51, RANGE 33 IN KANSAS CITY, CLAY COUNTY, MISSOURI

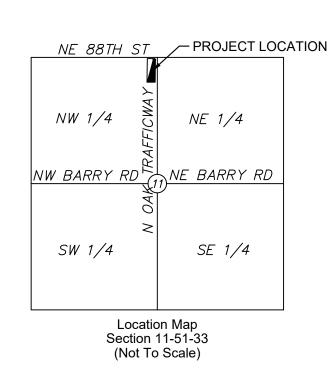


# PROJECT TEAM

DEVELOPER
PC HOMES, LLC
7607 NW JOHN ANDERS RD
KANSAS CITY, MO 64152TEL: 816-753-9200
CONTACT: BRIAN MERTZ
EMAIL: BMERTZ1@KC.RR.COM

DESIGN PROFESSIONAL (CIVIL ENGINEER)
KIMLEY-HORN AND ASSOCIATES, INC.
805 PENNSYLVANIA AVENUE, SUITE 150
KANSAS CITY, MO 64105
TEL: (816) 652-0350
PRIMARY CONTACT: MATT KIST, P.E.
EMAIL: MATT.KIST@KIMLEY-HORN.COM
SECONDARY CONTACT: PERLA DIOSDADO, P.E.
EMAIL: PERLA.DIOSDADO@KIMLEY-HORN.COM

SURVEYOR
AYLETT SURVEY & ENGINEERING CO.
201 NW 72ND STREET,
GLADSTONE, MO 64118
TEL: 816-436-0732

ARCHITECT
TIM BALDRIDGE
3515 W. 75TH ST. SUITE 201,
PRAIRIE VILLAGE, KS 66208
TEL: 913-831-1563
EMAIL: TBALDRIDGE@NSPJARCH.COM

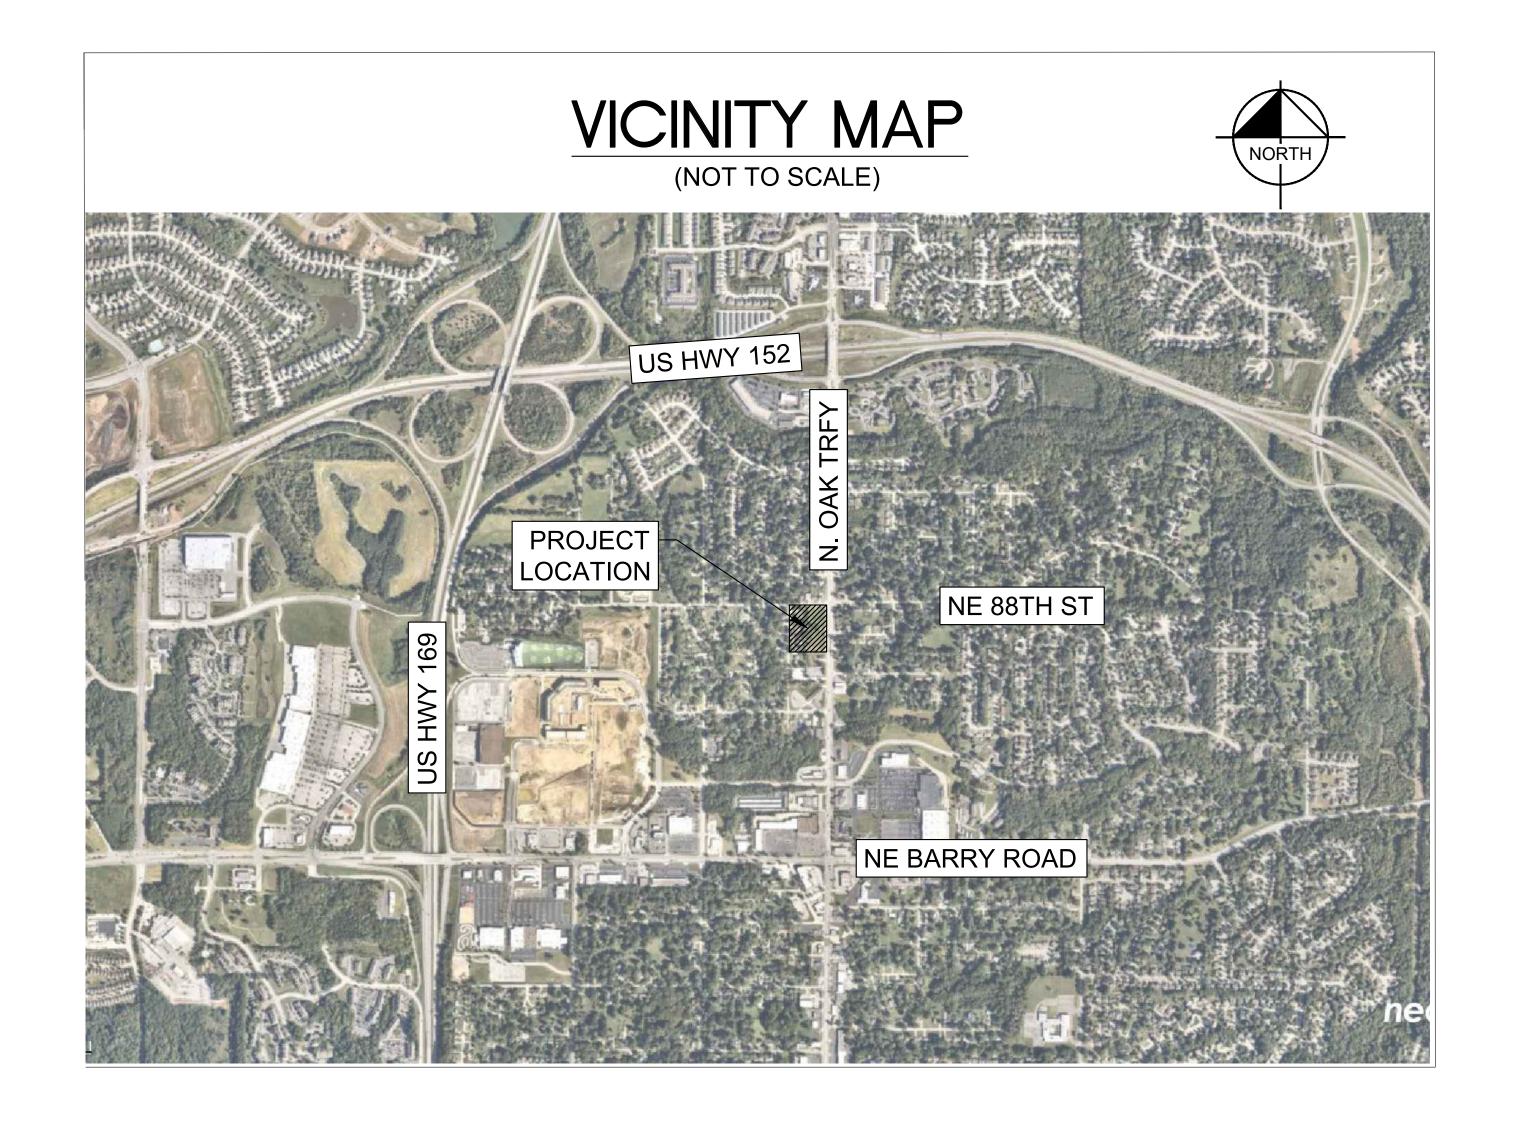

	Sheet List Table
Sheet Number	Sheet Title
C1	COVER SHEET
C2	EXISTING CONDITIONS
C3	SITE PLAN
C4	GRADING AND UTILITY PLAN
L1	LANDSCAPE PLAN
L2	STREET TREE PLANTING PLAN
L3	LANDSCAPE NOTES AND DETAILS
A1	BUILDING ELEVATIONS-1
A2	BUILDING ELEVATIONS-2
A3	BUILDING ELEVATIONS-3

# EXISTING LEGAL DESCRIPTION

THE NORTH 95 FEET OF THE EAST ONE HALF OF LOT 2, GASHLAND HEIGHTS RESURVEY, EXCEPT THE EAST 20 FEET THEREOF, A SUBDIVISION IN KANSAS CITY, CLAY COUNTY, MISSOURI; AND ALSO THE EAST HALF OF LOT 1, GASHLAND HEIGHTS RESURVEY, A SUBDIVISION IN KANSAS CITY, CLAY COUNTY, MISSOURI, EXCEPT THAT PART DEEDED TO THE CITY OF KANSAS CITY IN DEED RECORDED OCTOBER 7, 1996 AS DOCUMENT NO. N17010 IN BOOK 2609 AT PAGE 520; AND ALSO THE EAST 190 FEET OF THE SOUTH ONE HALF OF LOT 2, GASHLAND HEIGHTS RESURVEY, A SUBDIVISION OF LAND IN KANSAS CITY, CLAY COUNTY, MISSOURI, AND ALL OF THE EAST ONE HALF OF LOT 2, EXCEPT THE NORTH 95 FEET THEREOF, GASHLAND HEIGHTS RESURVEY, A SUBDIVISION IN KANSAS CITY, CLAY COUNTY, MISSOURI, ALSO EXCEPT THE FOLLOWING TRACT DEEDED TO KANSAS CITY, DESCRIBED AS FOLLOWS: THE EAST 20.00 FEET OF THE SOUTH 105 FEET OF LOT 2, GASHLAND HEIGHTS RESURVEY, A SUBDIVISION IN KANSAS CITY, CLAY COUNTY, MISSOURI; AND ALSO THE EAST HALF OF THE NORTH HALF OF TRACT 3, GASHLAND HEIGHTS RESURVEY, A SUBDIVISION IN KANSAS CITY, CLAY COUNTY, MISSOURI; AND ALSO THE EAST HALF OF THE NORTH HALF OF TRACT 3, GASHLAND HEIGHTS RESURVEY, A SUBDIVISION IN KANSAS CITY, CLAY COUNTY, MISSOURI, EXCEPT THAT EAST 20 FEET THEREOF.

AS NOTED

KIMIEY—HORN AND ASSOCIATES, INC. 805 PENNSYLVANIA AVENUE, SUITE 150 WWW.KIMIEY—HORN.COM

BY: MK

WOOD STATE OF AUTHORITY #001512, INC. 100 MENUE, SUITE 150 MENUE, SUI

DESIGNED BY: PD
DRAWN BY: PD
CHECKED BY: MK




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NE 88TH STREET &
RTH OAK TRAFFICWA
APARTMENTS

ORIGINAL ISSUE: 02.14.2022 KHA PROJECT NO. 268131000

SHEET NUMBER

C1

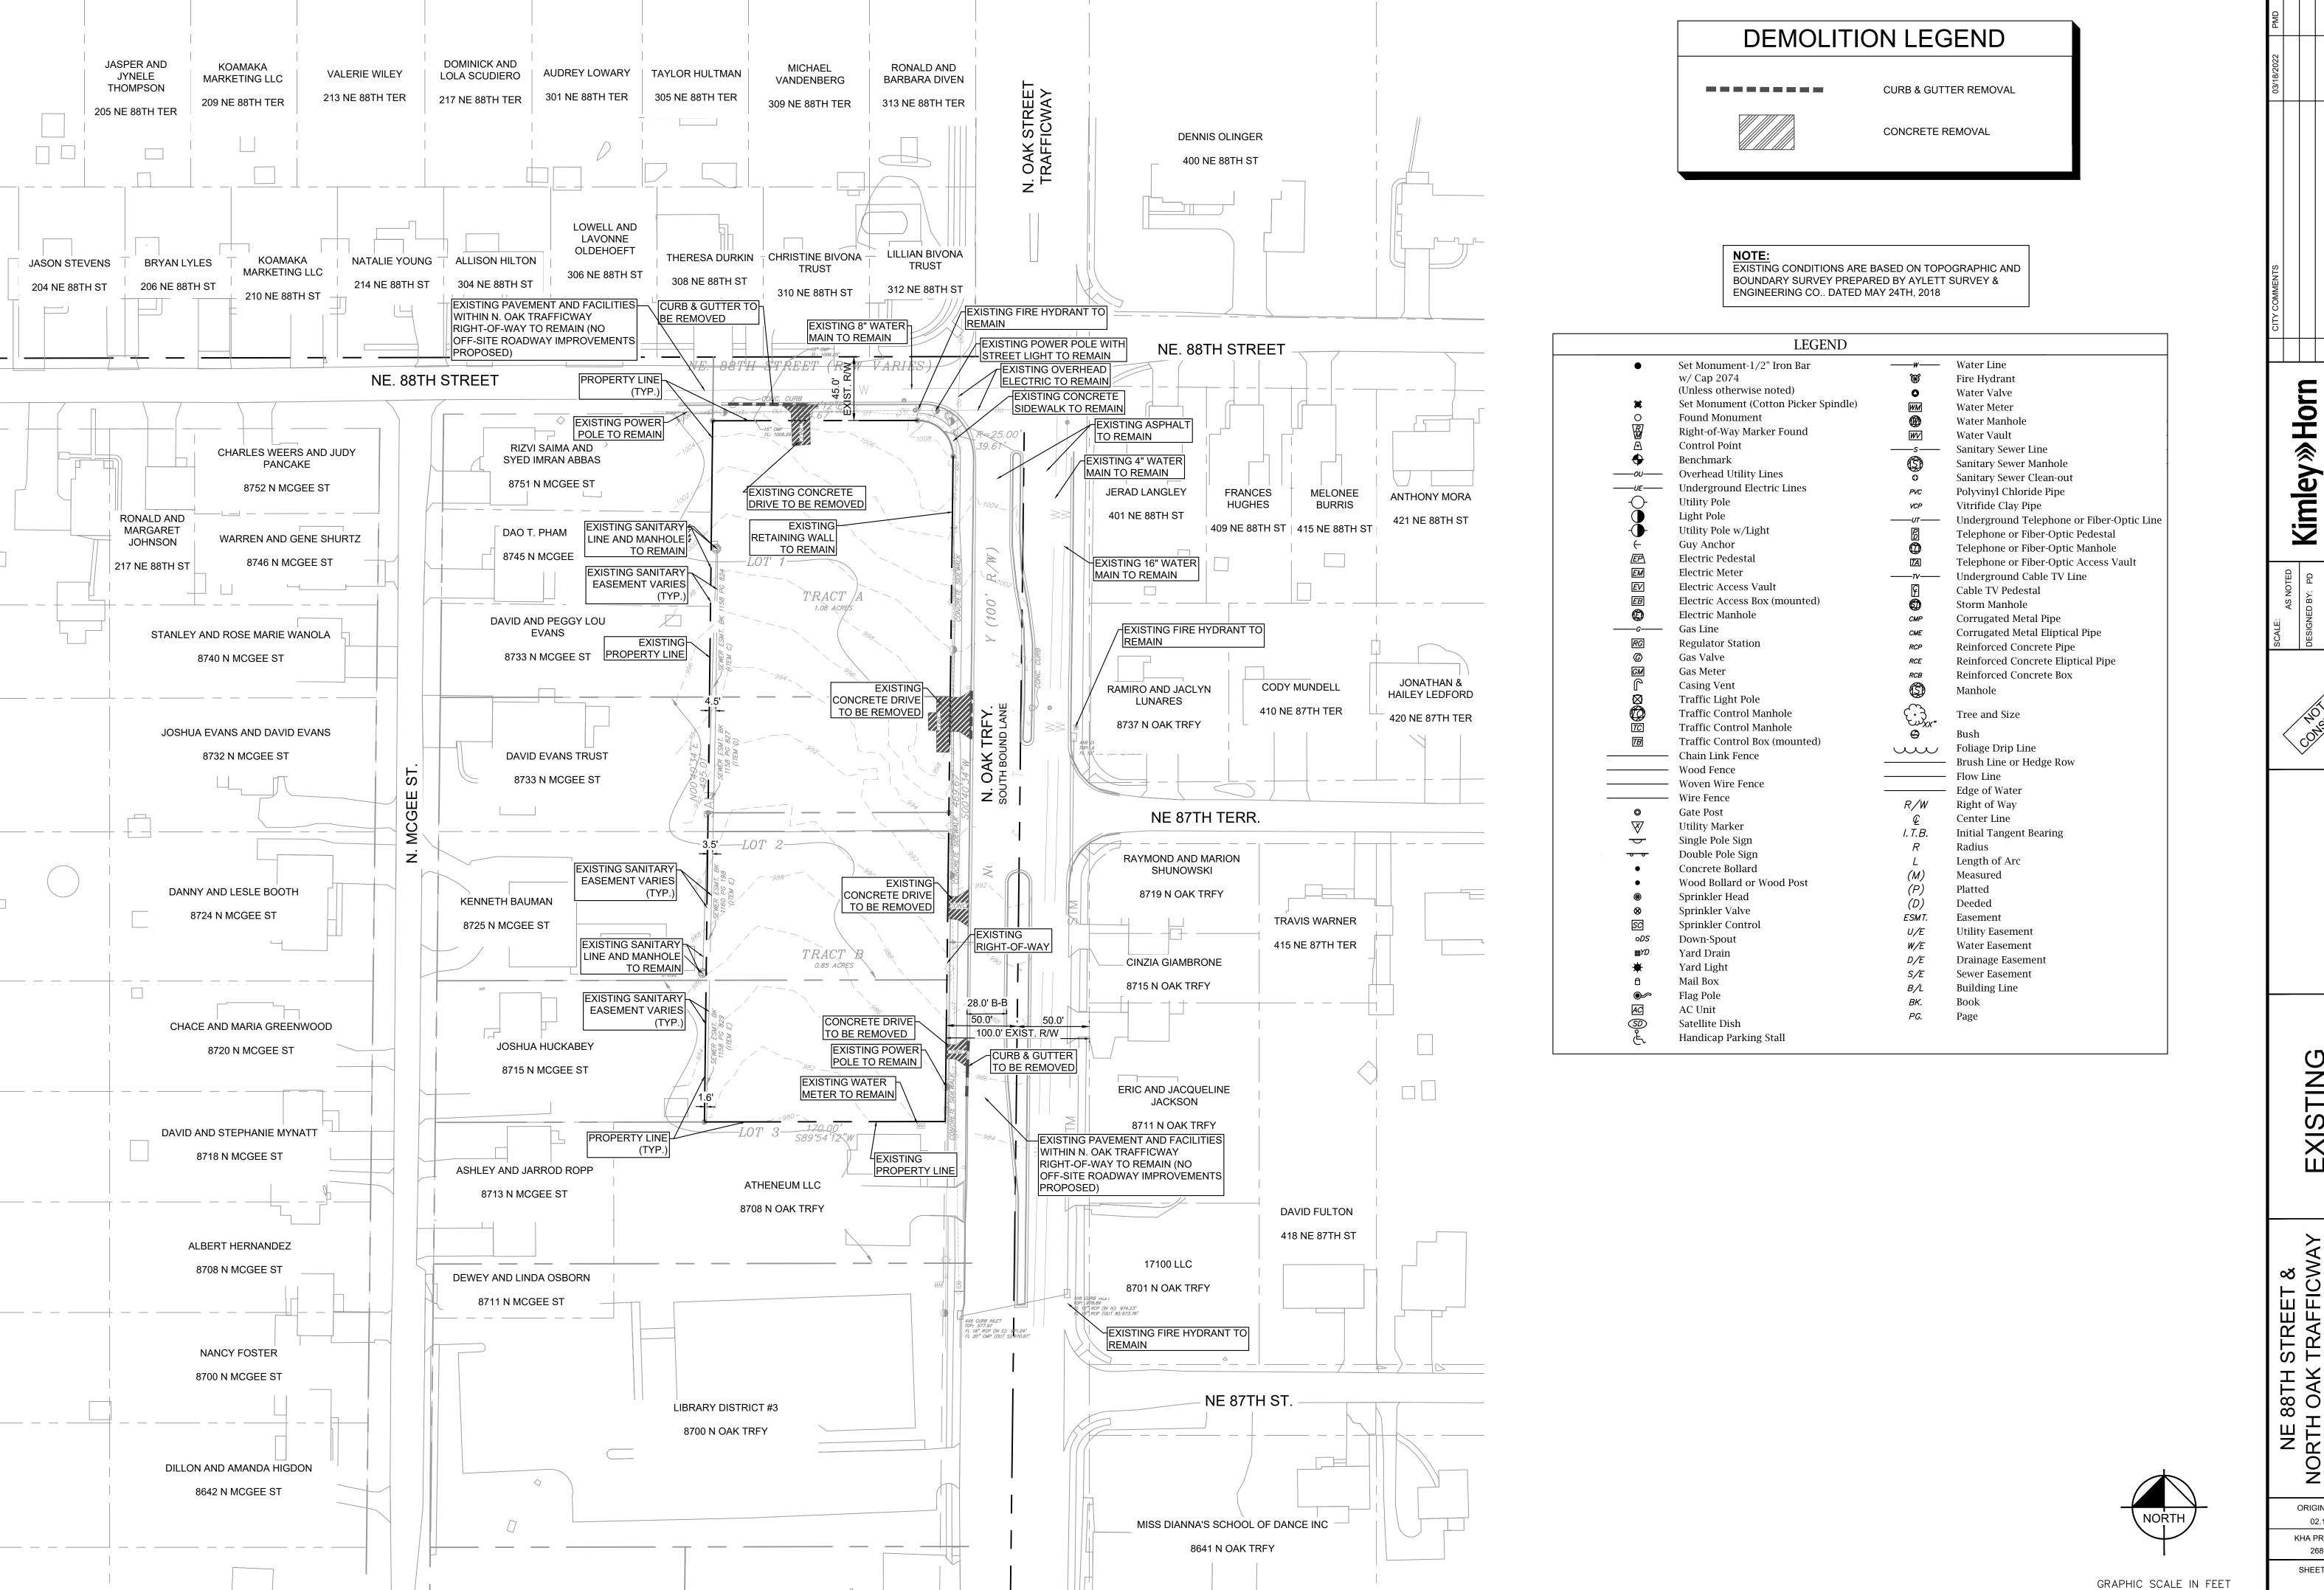



ORIGINAL ISSUE: 02.14.2022 KHA PROJECT NO. 268131000 SHEET NUMBER

EXISTING CONDITIONS

≫Horn

Kimley

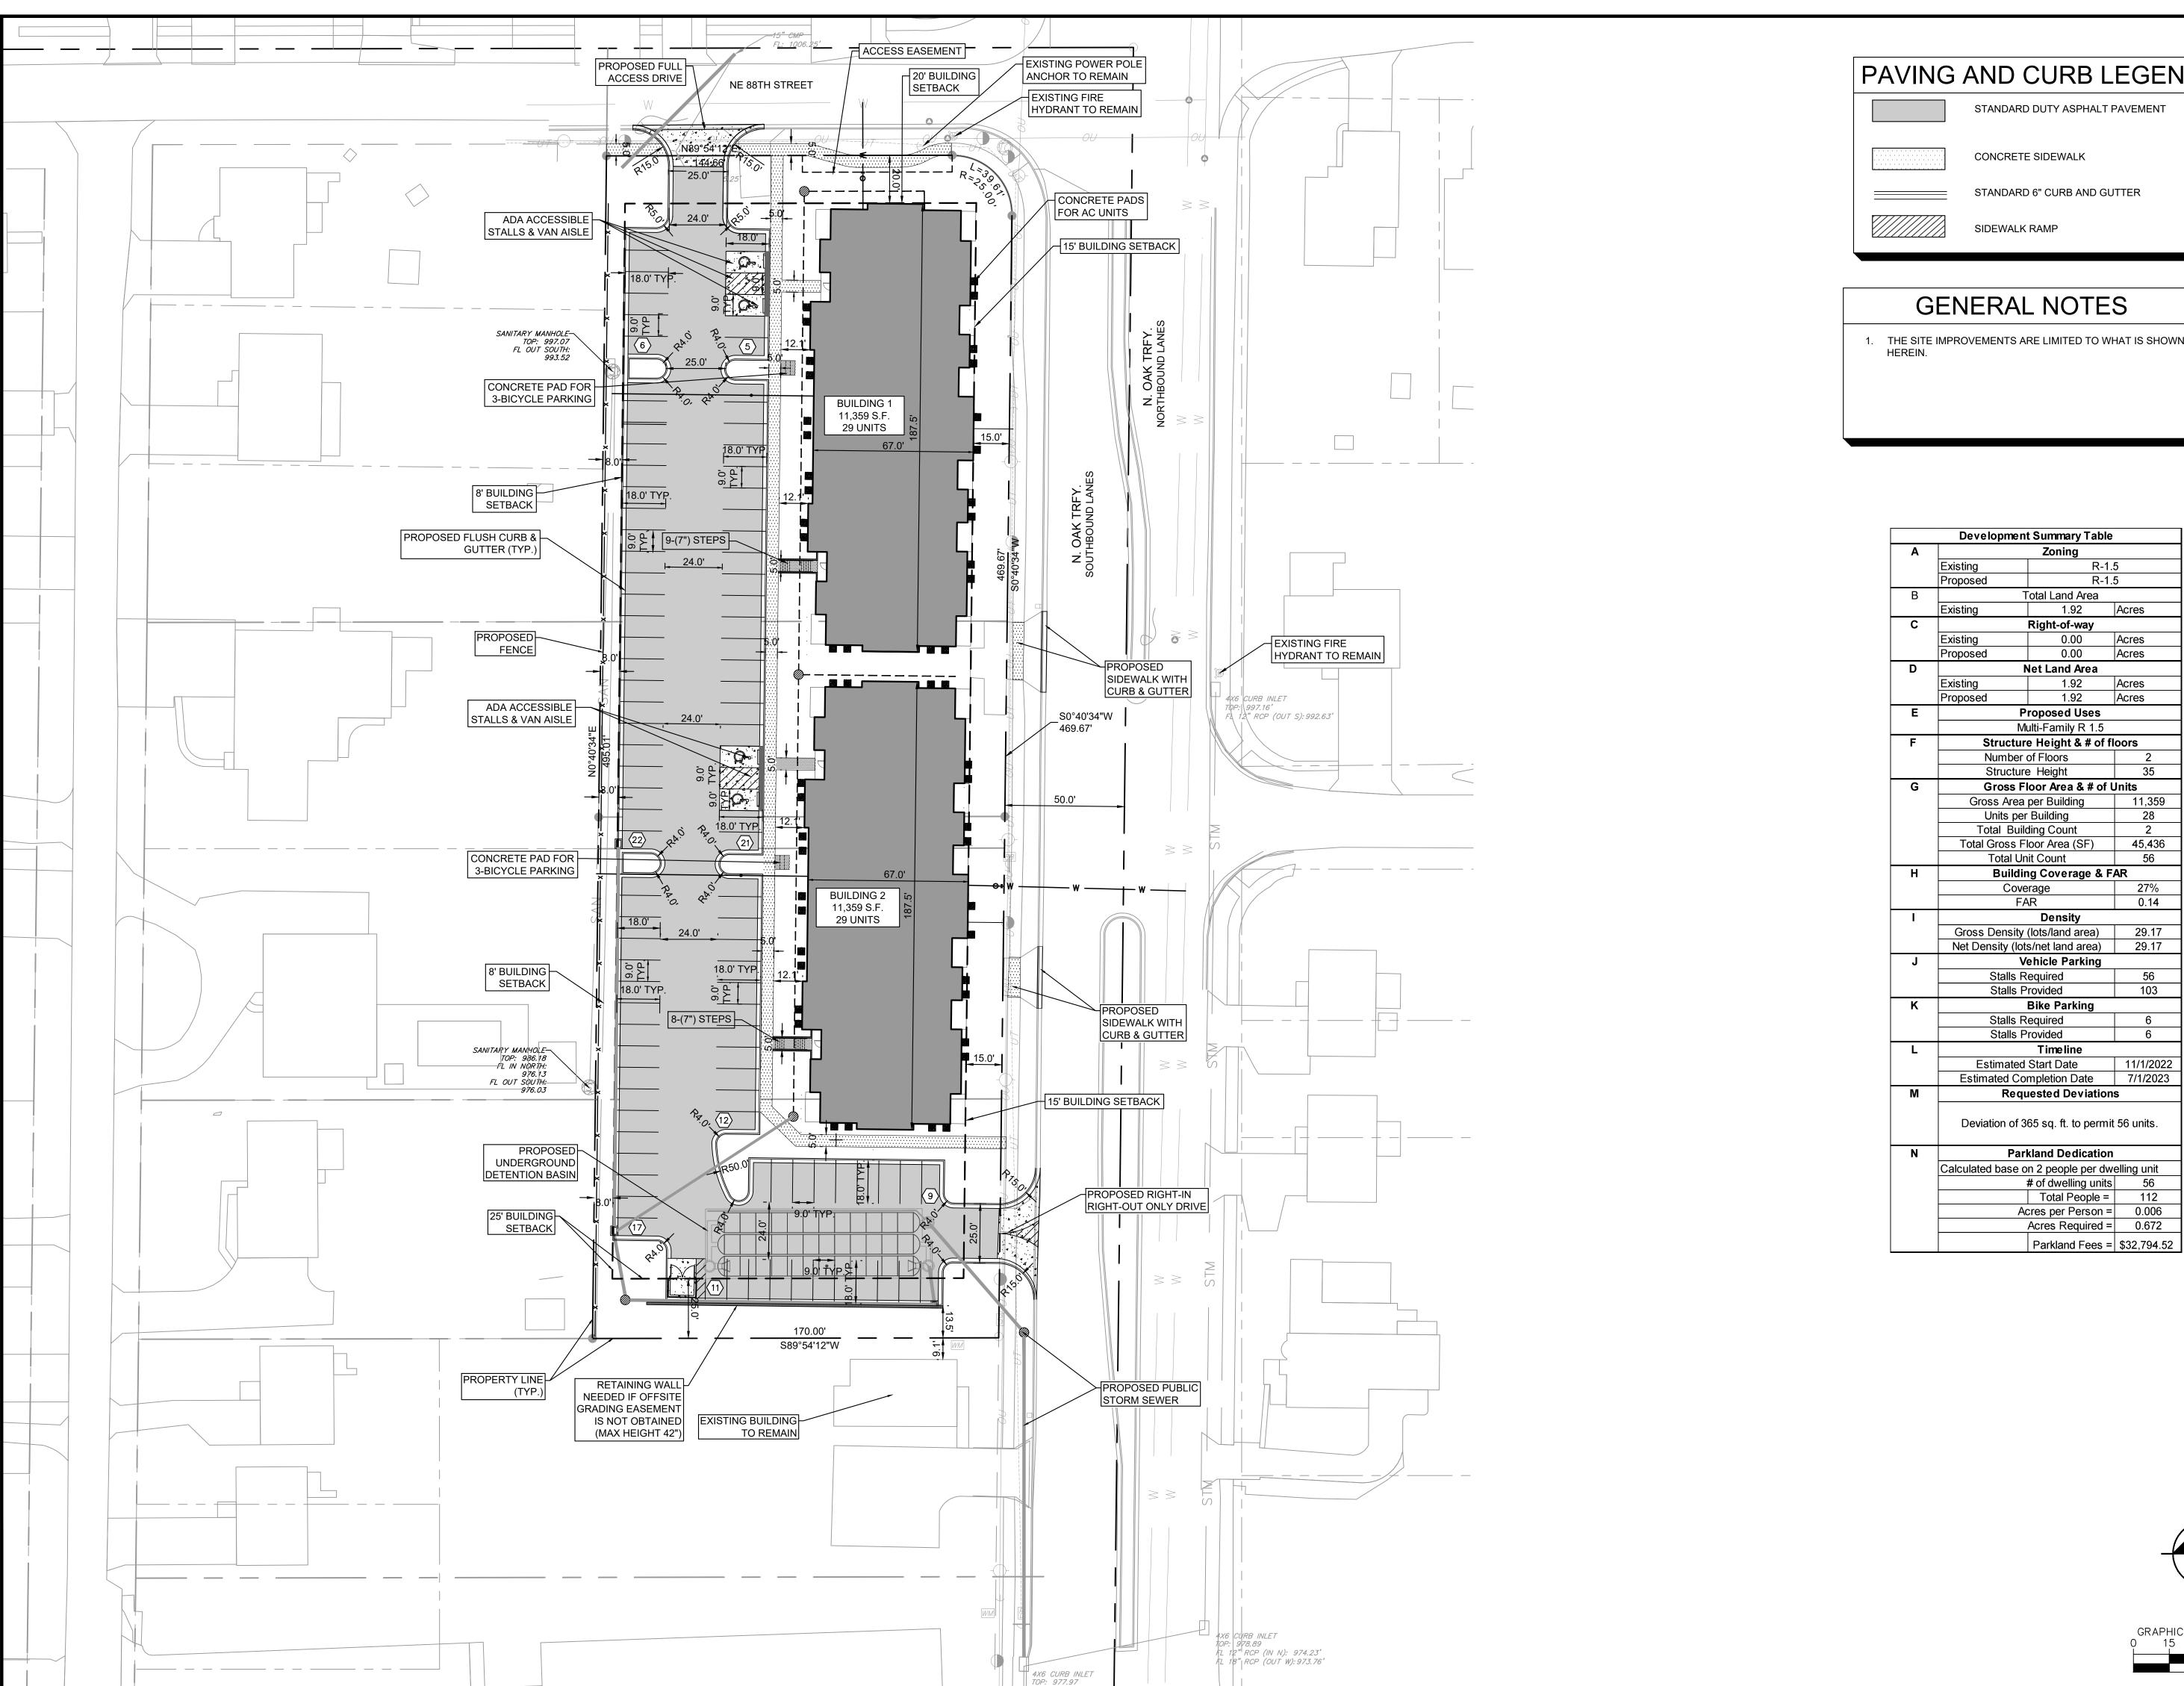

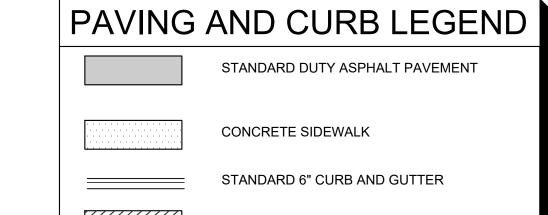

1. THE SITE IMPROVEMENTS ARE LIMITED TO WHAT IS SHOWN

<b>В</b>	İ	nt Summary Table	
		Zoning	
	Existing	5	
	Proposed	5	
		Total Land Area	
$\sim$	Existing	1.92	Acres
•		Right-of-way	
	Existing	0.00	Acres
	Proposed	0.00	Acres
D		Net Land Area	
	Existing	1.92	Acres
	Proposed	1.92	Acres
Е	•	Proposed Uses	•
		/ulti-Family R 1.5	
F		re Height & # of f	loors
•		of Floors	2
		re Height	35
G	+	Floor Area & # of l	
G		a per Building	
		11,359	
	Units pe	28	
	Total Bu		
	Total Gross I	45,436	
	Total U	56	
Н	Build	1	
		rerage	27%
	F	0.14	
I		Density	1
	Gross Density	29.17	
	Net Density (lo	29.17	
J	•	Vehicle Parking	
	Stalls I	56	
	Stalls	Provided	103
K		Bike Parking	
	Stalls I	6	
	Stalls	6	
		Timeline	
L	Estimated	d Start Date	11/1/2022
L			
L		ompletion Date	7/1/2023
L M	Estimated C		ı
	Estimated Co	ompletion Date	S
	Estimated Control Reg	ompletion Date  uested Deviation	s t 56 units.
M	Estimated Control Registration of Pa	ompletion Date uested Deviation 365 sq. ft. to permit	s t 56 units.
M	Estimated Control Registration of Pa	ompletion Date puested Deviation 365 sq. ft. to permiterished stand Dedication	s t 56 units.
M	Estimated Control Registration of Pa	ompletion Date  Juested Deviation  365 sq. ft. to permit  rkland Dedication on 2 people per dw	s t 56 units.
M	Deviation of  Pa  Calculated base	ompletion Date puested Deviation 365 sq. ft. to permit rkland Dedication on 2 people per dw # of dwelling units	s t 56 units. elling unit 56
M	Deviation of  Pa  Calculated base	ompletion Date  Juested Deviation  365 sq. ft. to permit  rkland Dedication on 2 people per dw # of dwelling units  Total People =	s t 56 units.  elling unit 56 112





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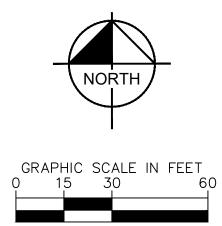
NE 88TH STREET & NORTH OAK TRAFFICWAY APARTMENTS

SITE

Kimley » Horn



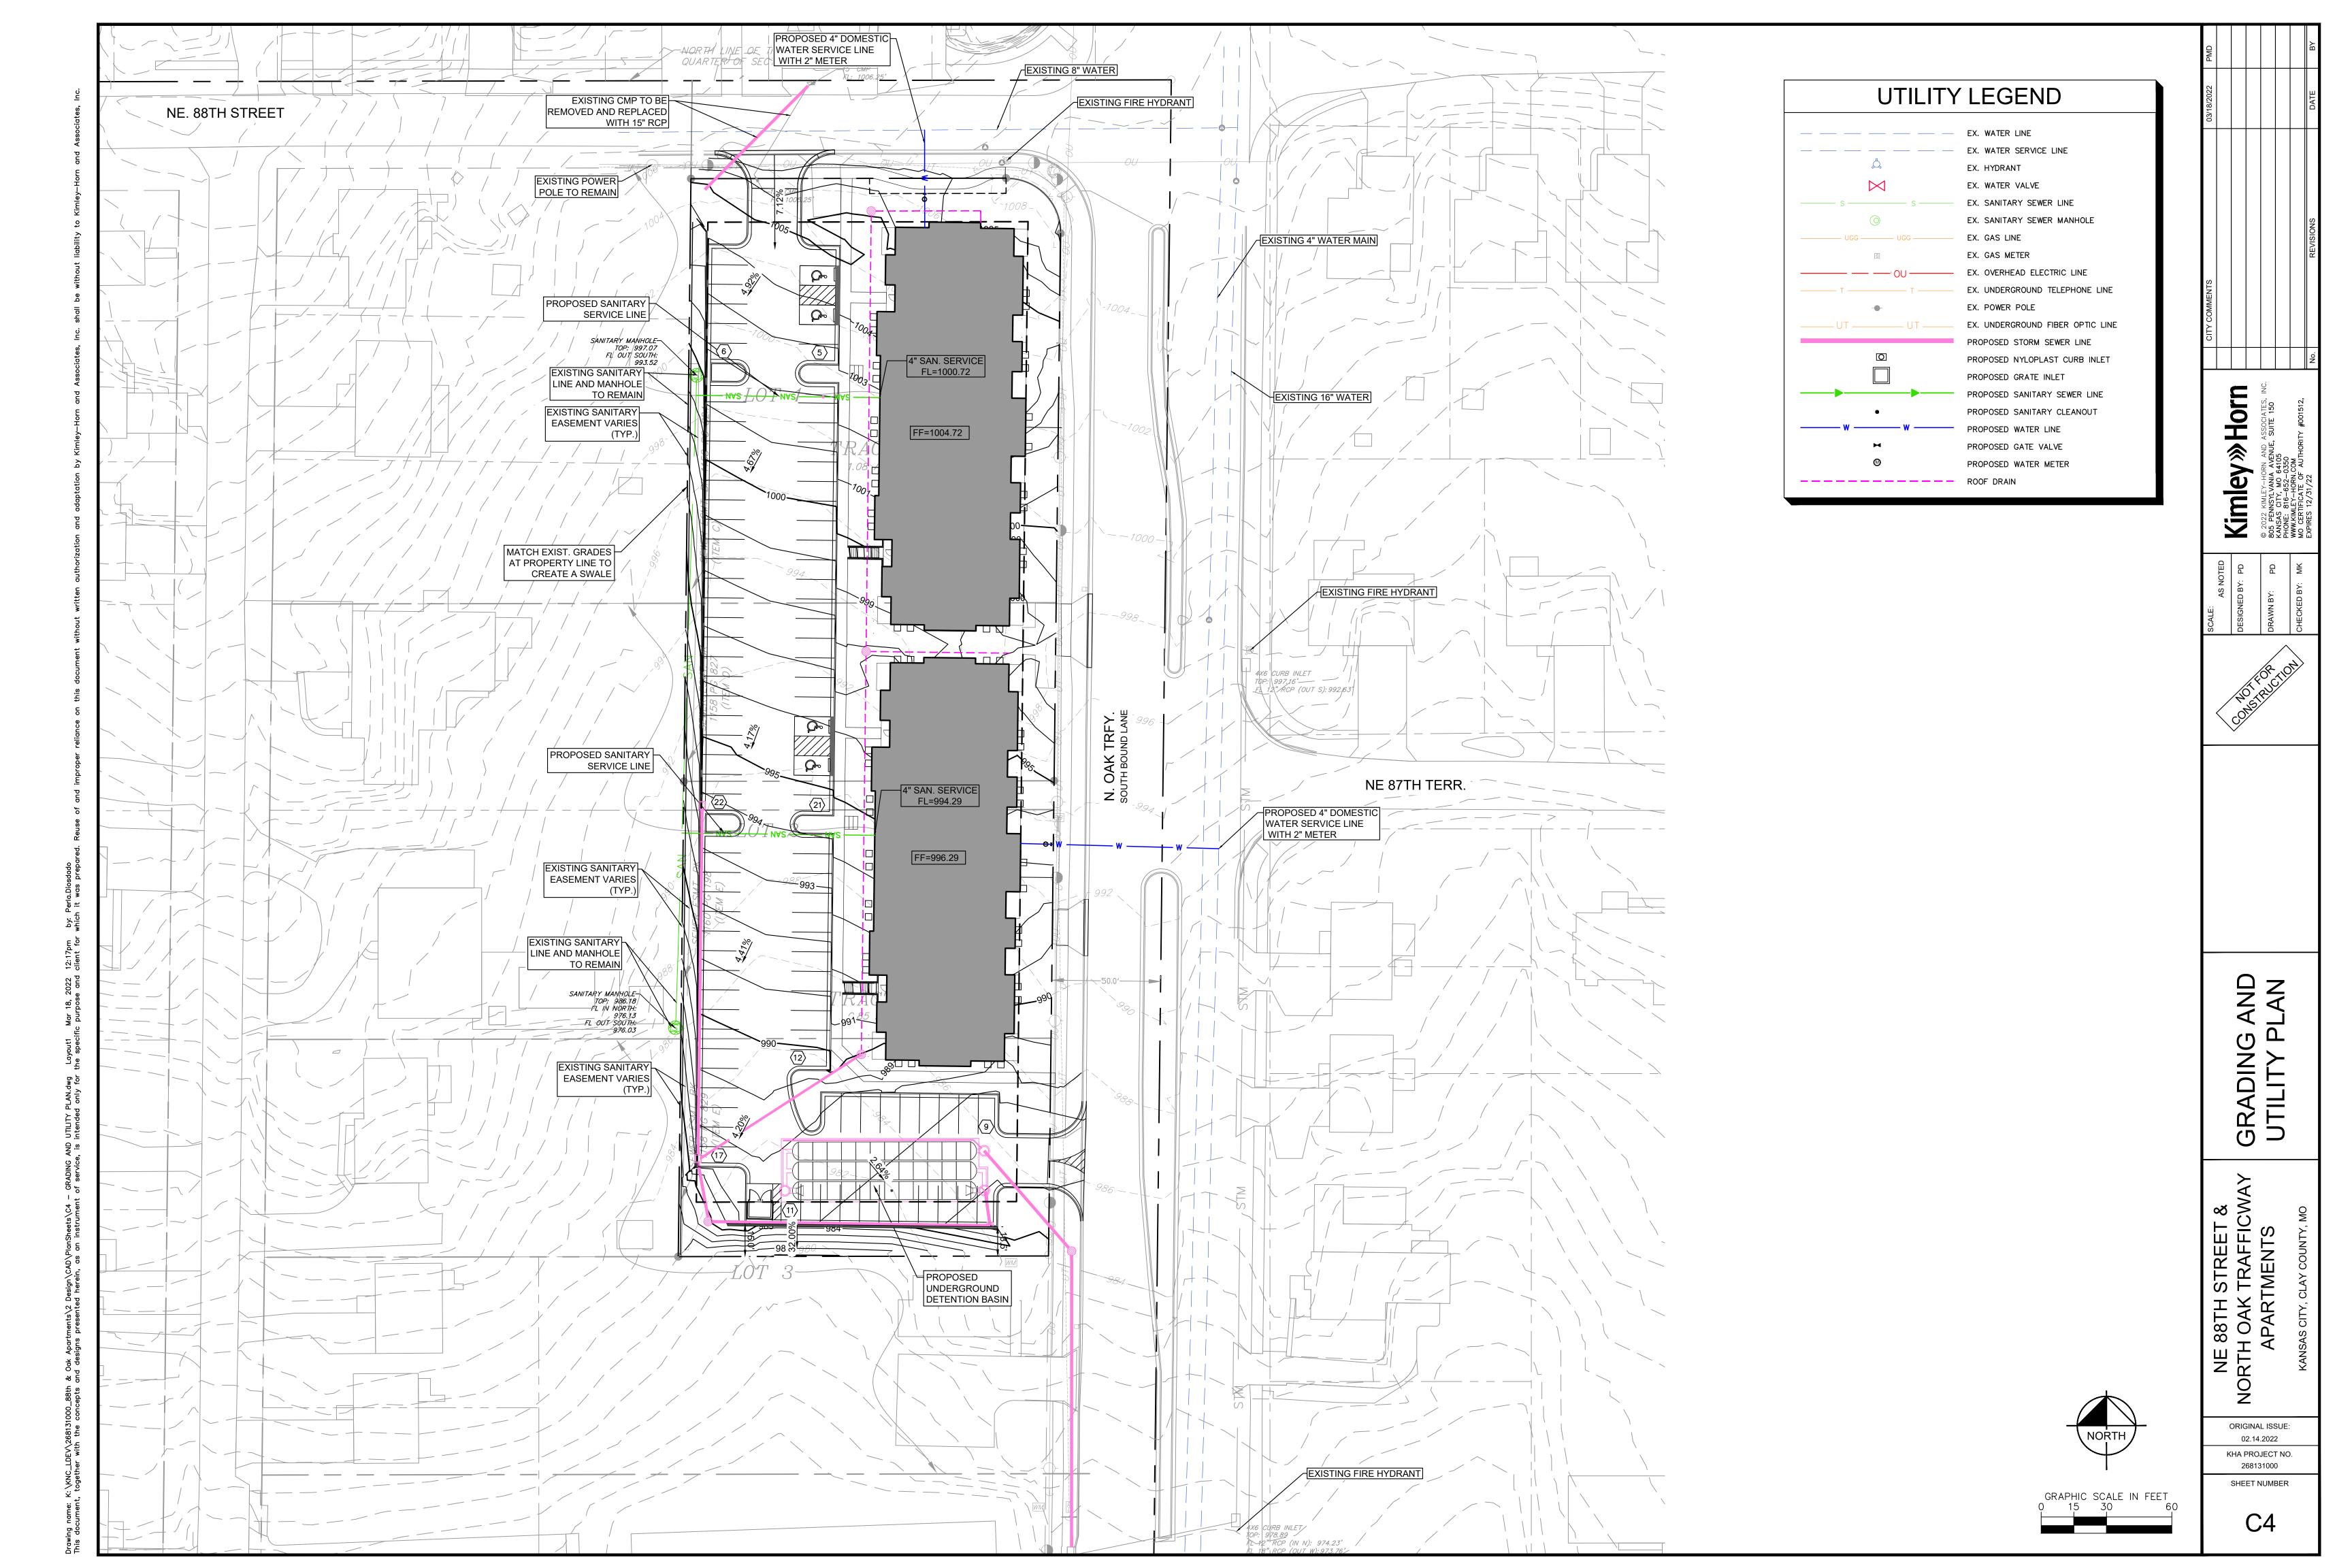

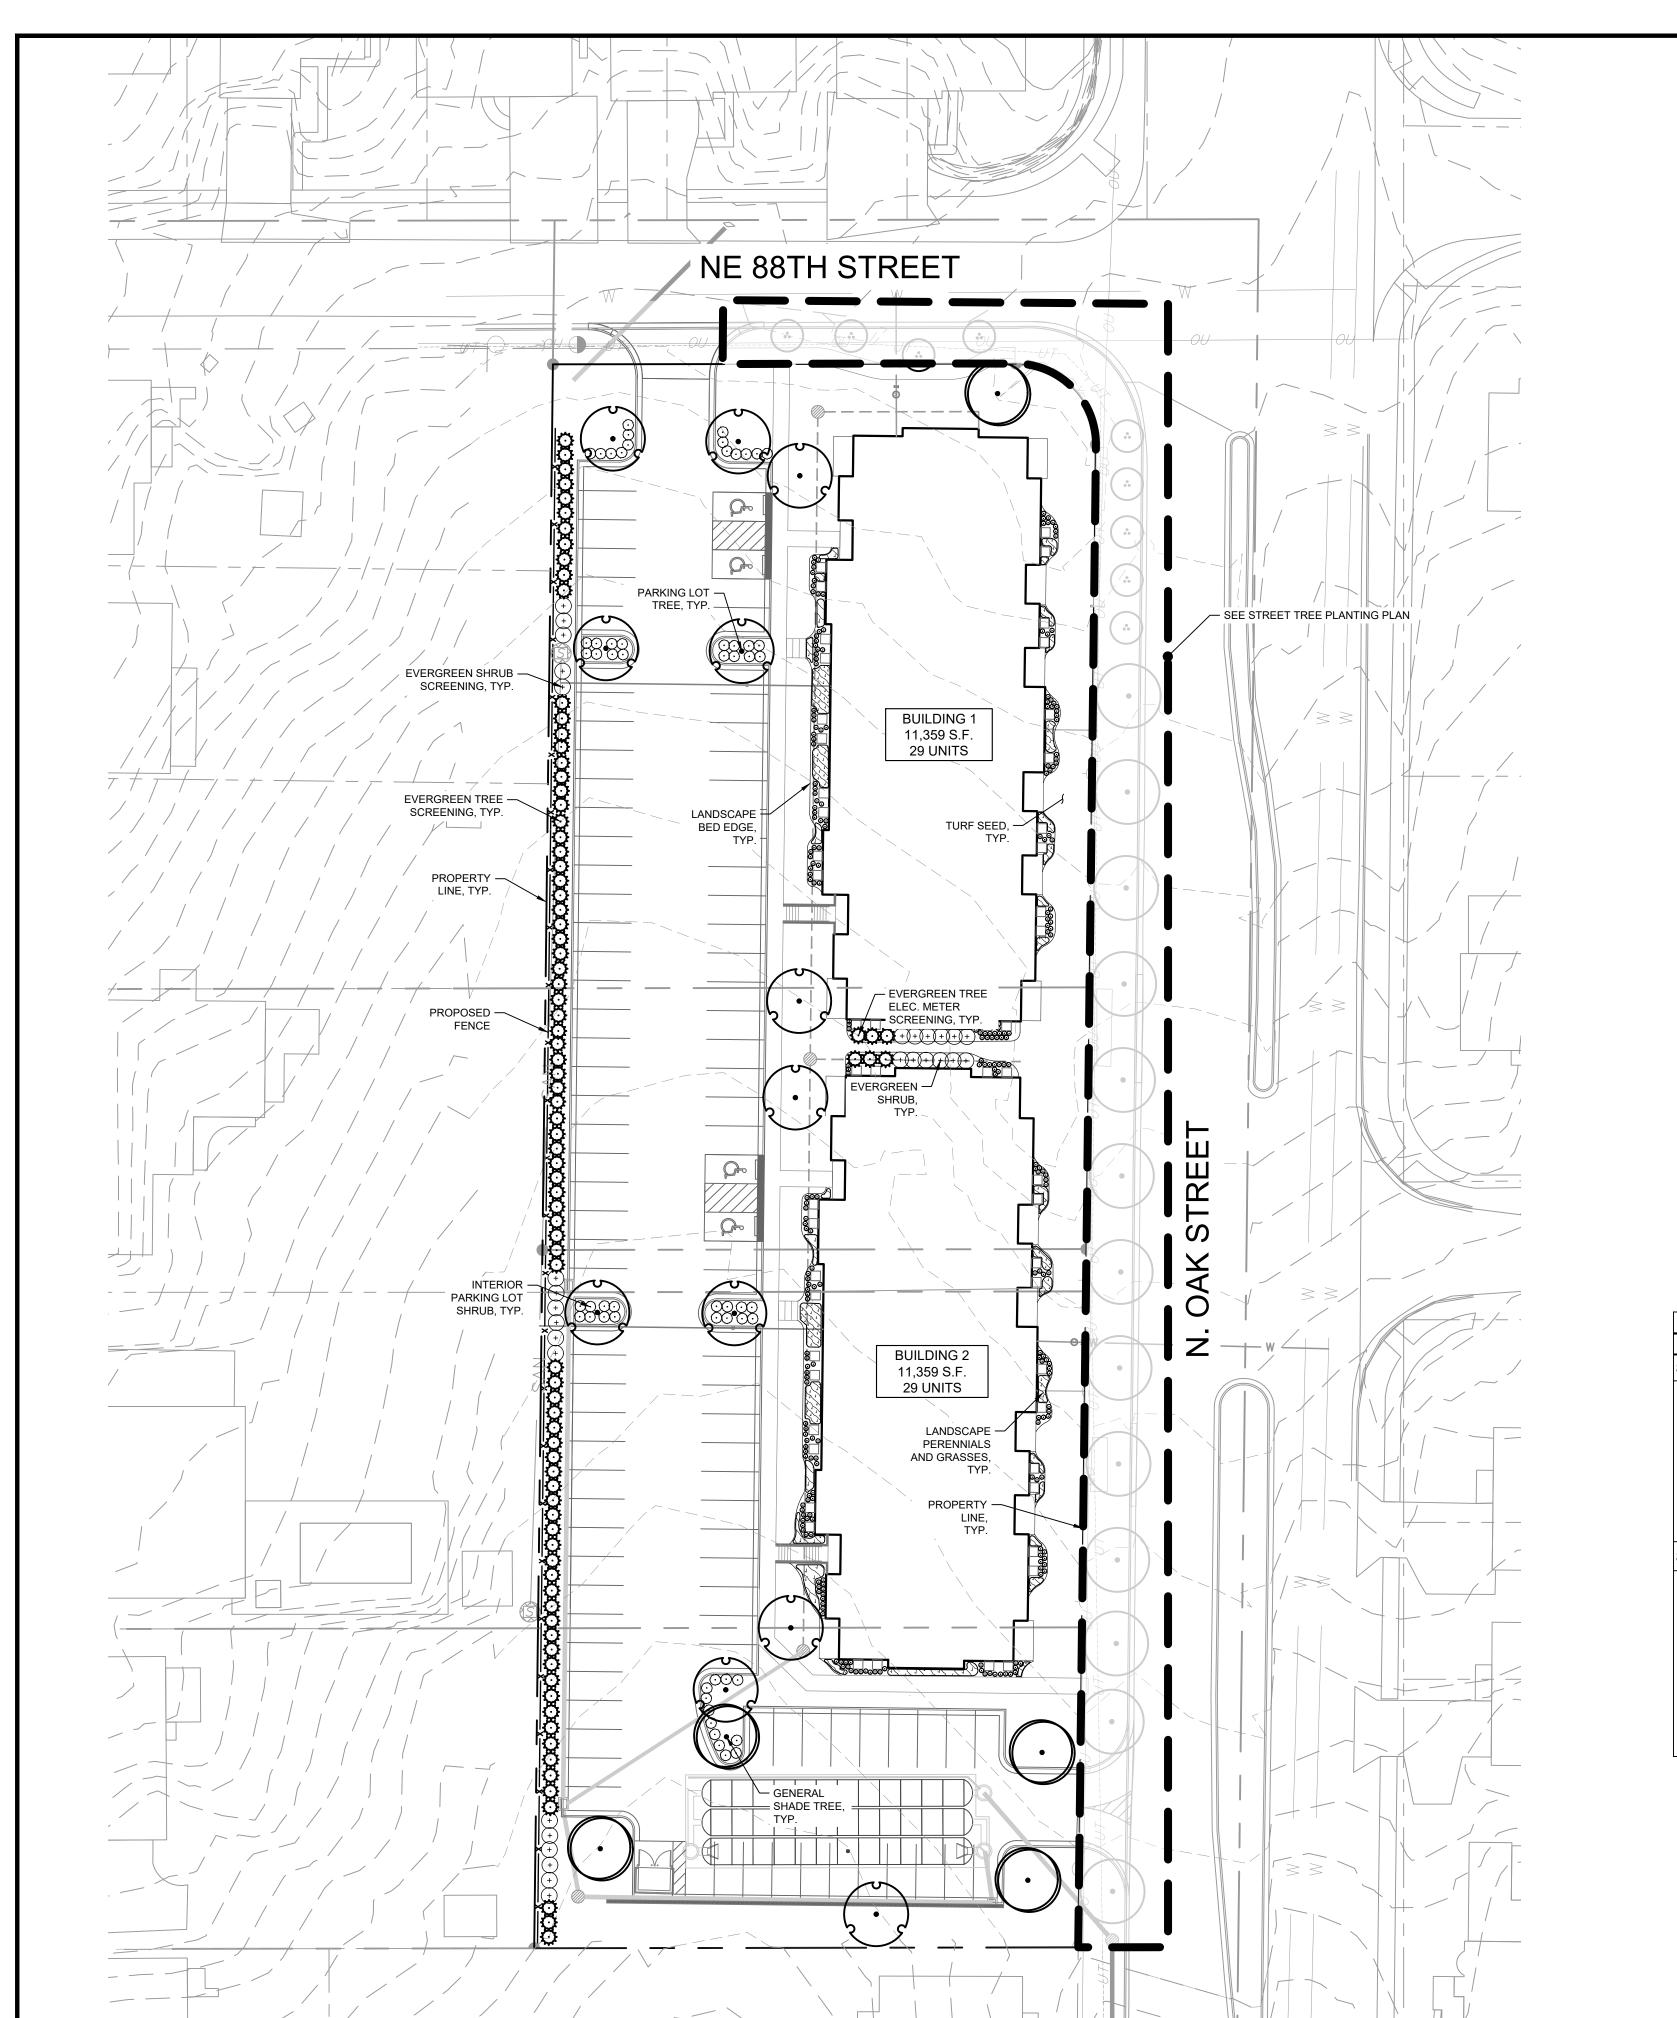

# CONCEPT PLANT SCHEDULE

GENERAL SHADE TREE
ACER RUBRUM QUERCUS ROBUR GINKGO BILOBA



PARKING LOT TREE QUERCUS ROBUR GINKGO BILOBA GLEDITSIA TRIACANTHOS GYMNOCLADUS DIOICUS QUERCUS RUBRA



**EVERGREEN TREE** JUNIPEROUS SCOPULORUM X `SKYROCKET` JUNIPEROUS CHINESIS X 'SPARTAN' CHAMAECYPARIS OBTUSA X `GRACILIS`

QUERCUS BICOLOR



INTERIOR PARKING LOT SHRUB SPIRAEA JAPONICA ARONIA MELANOCARPA CEANOTHUS AMERICANUS FORSYTHIA

(+)	EVERGRE
$\bigcirc$	TAXUS X
	BLIXLIS

REEN SHRUB X MEDIA



PERENNIALS AND GRASSES

255

764


KC, MO LANDSCAPE CODE							
ZONING ORDINANCE	REQUIREMENT	PROVIDED					
425-04-D GENERAL LANDSCAPE REQUIREMENTS							
AT LEAST ONE TREE IS REQUIRED PER 5,000 SQUARE FEET OF PRINCIPAL BUILDING COVERAGE (BUILDING FOOTPRINT). PLANTED IN SETBACKS AND OPEN SPACE AREAS.	BUILDING 1 - 11,359 S.F.  BUILDING 2 - 11,359 S.F.  TOTAL FOOTPRINT - 22,718 S.F.  22,718/ 5,000 = 4.54 TREES  5 TREES	5 TREES PROVIDED.					
3-425-06 - INTERIOR LANDSCAPING OF PARKING LOTS							
T LEAST 35 S.F. OF INTERIOR LANDSCAPE AREA MUST BE PROVIDED FOR EACH PARKING SPACES	58 PARKING SPACES 58/5 = 11.6 <b>12 TREES</b>	12 TREES PROVIDED IN INTERIOR PARKING					
AND ONE SHRUB PER PARKING SPACE. GROUND COVER PLANTS MUST  COVER ALL INTERIOR LANDSCAPE AREAS.	58 PARKING SPACES 58 SHRUBS	58 INTERIOR SHRUBS PROVIDED					


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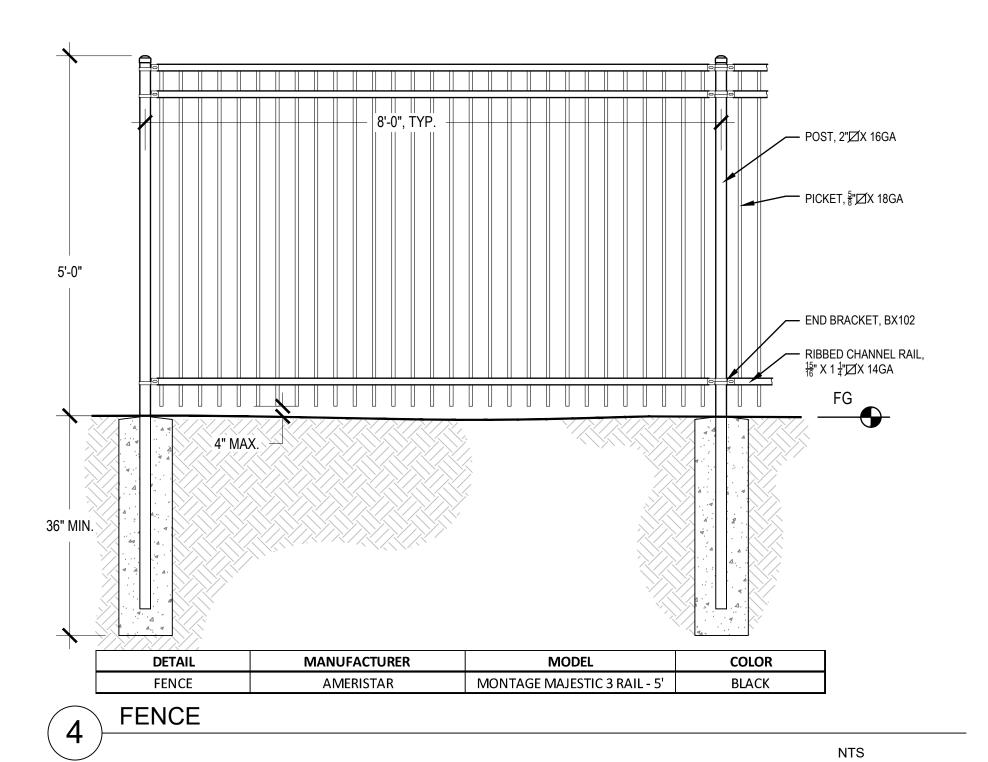
NE 88TH STREET & NORTH OAK TRAFFICWA APARTMENTS


ORIGINAL ISSUE: 02.14.2022 KHA PROJECT NO. 268131000

SHEET NUMBER



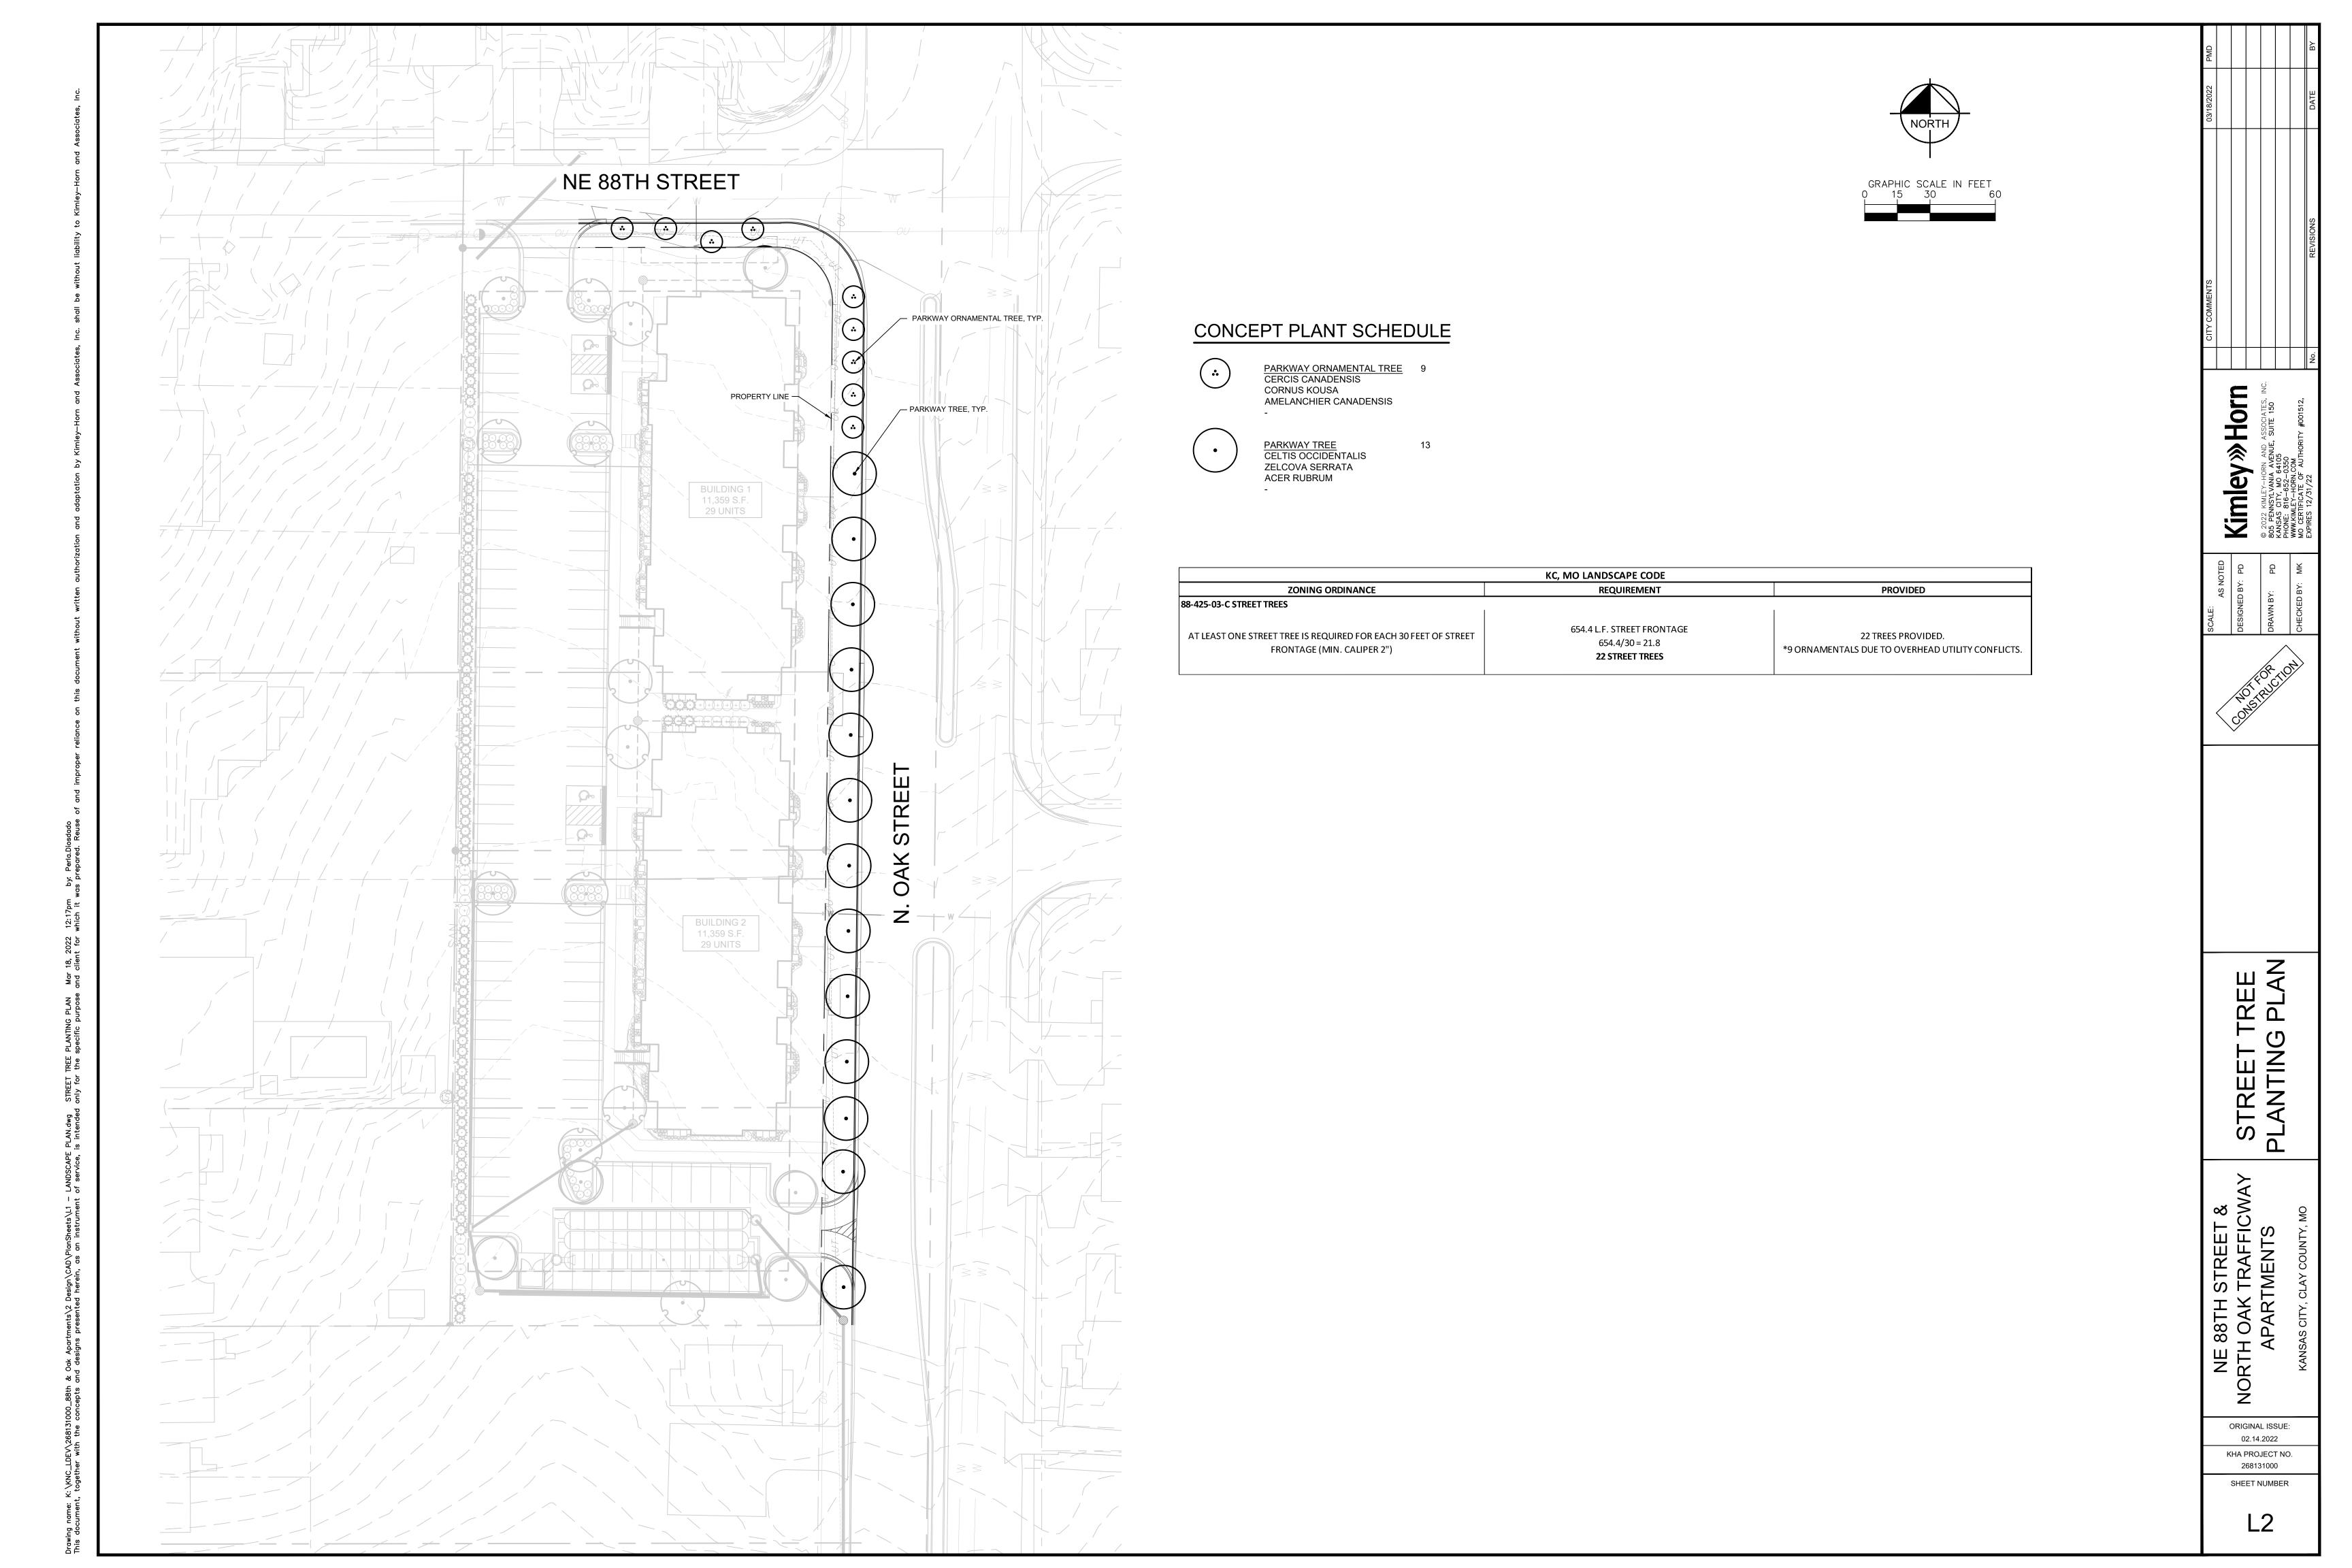

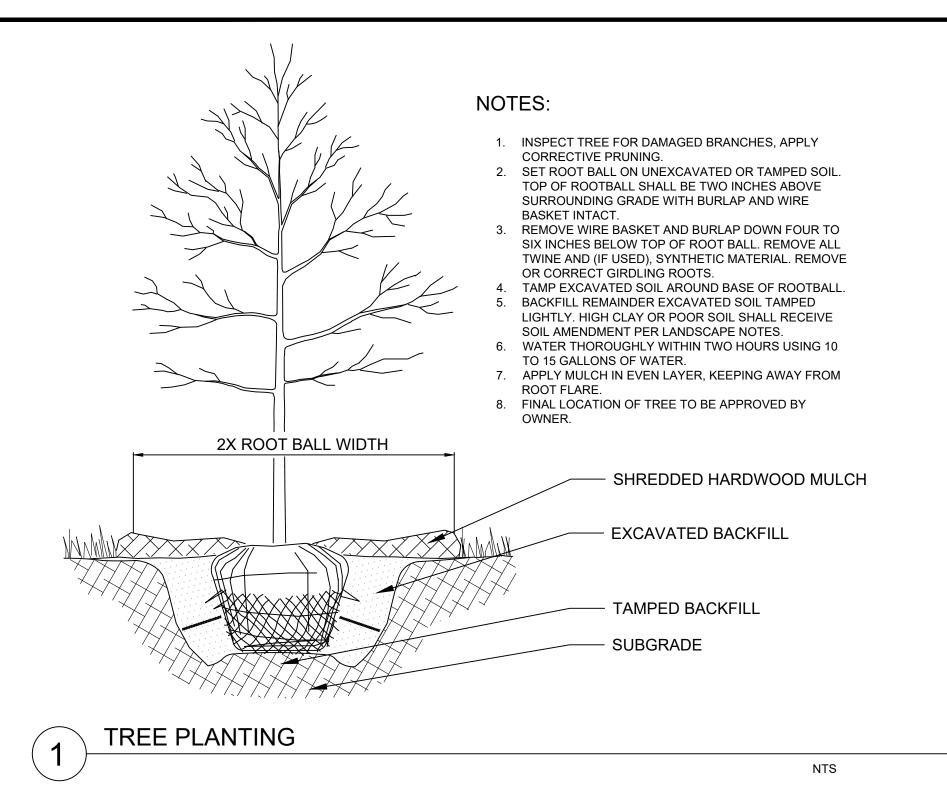

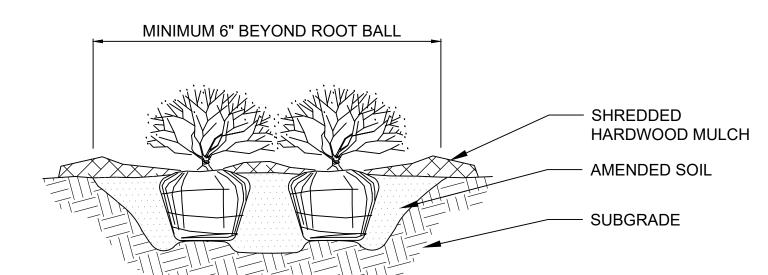

# NOTES:

- 1. APPLY CORRECTIVE PRUNING.
- SET ROOT BALL OR CONTAINER ON UNEXCAVATED OR TAMPED SOIL. TOP OF ROOTBALL (CONTAINER) SHALL BE ONE INCH ABOVE SURROUNDING GRADE. FOR LARGER SHRUBS WITHIN PLANTING BED DIG A DEEPER PIT ONLY FOR THOSE SHRUBS.
- 3. REMOVE BURLAP FROM TOP HALF THE LENGTH OF ROOTBALL. TWINE AND (IF USED) SYNTHETIC MATERIAL SHALL BE REMOVED FROM PLANTING BED. FOR CONTAINER GROWN SHRUBS, REMOVE CONTAINER AND LOOSEN ROOTS PRIOR TO INSTALLATION.
- PLUMB AND BACKFILL WITH AMENDED SOIL PER LANDSCAPE NOTES. WATER THOROUGHLY WITHIN TWO HOURS.
- 6. APPLY MULCH IN EVEN LAYER, KEEPING AWAY FROM ROOT FLARE. MULCH LIMITS FOR SHRUBS EXTEND TO ALL LIMITS OF PLANTING BED, SEE PLANS FOR BED LAYOUTS.
- SHRUB PLANTING

REMOVE OR CORRECT GIRDLING ROOTS.

NTS

# PREVENT CIRCLING ROOTS. CORRECT GIRDLING ROOTS. 2. PLANT MATERIAL SHALL BE LAID OUT BY FOLLOWING THE BED EDGE, WORKING TOWARDS THE CENTER OF THE BED USING TRIANGULAR (STAGGERED) SPACING AS PLAUSIBLE. 3. PLUMB AND BACKFILL WITH PLANTING MIX AS SPECIFIED IN LANDSCAPE NOTES. 4. APPLY MULCH IN EVEN LAYER, KEEPING AWAY FROM ROOT FLARE. MULCH LIMITS FOR PERENNIALS/GROUNDCOVER EXTEND TO ALL LIMITS OF PLANTING BED, SEE PLANS FOR BED LAYOUTS. 5. SPACING TO BE AS SPECIFIED IN THE PLANT LIST. PERENNIALS SHALL BE PLACED WITH THEIR CENTER 24" FROM EDGE OF BED. O.C. SPACING, SEE PLANS FOR DETAILS SHREDDED HARDWOOD MULCH SPADED BED EDGE AMENDED SOIL SUBGRADE **SECTION PLAN VIEW**

2. BED HEIGHT IS TO BE 2" ABOVE FINISH GRADE AND WELL DRAINED.

3. REMOVE CONTAINER, SCORE SOIL MASS TO REDIRECT AND

NOTES:

PERENNIAL PLANTING

EXCAVATE PLANTING BED.

# LANDSCAPE NOTES

- 1. THE LANDSCAPE CONTRACTOR SHALL BE RESPONSIBLE FOR INSTALLING MATERIALS AND PLANTS SHOWN ON THE LANDSCAPE PLAN. THE CONTRACTOR IS RESPONSIBLE FOR THE COST TO REPAIR UTILITIES, ADJACENT LANDSCAPE, PUBLIC AND PRIVATE PROPERTY THAT IS DAMAGED BY THE CONTRACTOR OR THEIR SUBCONTRACTOR'S OPERATIONS DURING INSTALLATION OR DURING THE SPECIFIED MAINTENANCE PERIOD. CALL FOR UTILITY LOCATIONS PRIOR TO ANY EXCAVATION.
- 2. THE CONTRACTOR SHALL REPORT ANY DISCREPANCY IN PLAN VS. FIELD CONDITIONS IMMEDIATELY TO THE LANDSCAPE ARCHITECT, PRIOR TO CONTINUING WITH THAT PORTION OF WORK.
- 3. NO PLANTING WILL BE INSTALLED UNTIL ALL GRADING AND CONSTRUCTION HAS BEEN COMPLETED IN THE IMMEDIATE AREA.
- 4. THE CONTRACTOR SHALL BE RESPONSIBLE FOR THE REPAIR OF ANY OF THEIR TRENCHES OR EXCAVATIONS THAT SETTLE.
- 5. ALL PLANTS TO BE SPECIMEN GRADE, WELL BRANCHED, HEALTHY, FULL, PRE-INOCULATED AND FERTILIZED. PLANTS SHALL BE FREE FROM DISEASE, PESTS, WOUNDS, AND SCARS. PLANTS SHALL BE FREE FROM NOTICEABLE GAPS, HOLES, OR DEFORMITIES. PLANTS SHALL BE FREE FROM BROKEN OR DEAD BRANCHES. TRUNKS WILL BE WRAPPED IF NECESSARY TO PREVENT SUN SCALD AND INSECT DAMAGE. THE LANDSCAPE CONTRACTOR SHALL REMOVE THE WRAP AT THE PROPER TIME AS PART OF THIS CONTRACT.
- THE OWNER'S REPRESENTATIVE MAY REJECT ANY PLANT MATERIALS THAT ARE DISEASED. DEFORMED, OR OTHERWISE NOT EXHIBITING SUPERIOR QUALITY.
- 7. ALL NURSERY STOCK SHALL BE GUARANTEED, BY THE CONTRACTOR, FOR ONE YEAR FROM DATE OF FINAL INSPECTION. THE GUARANTEE BEGINS ON THE DATE OF THE LANDSCAPE ARCHITECT'S OR OWNERS WRITTEN ACCEPTANCE OF THE INITIAL PLANTING. REPLACEMENT PLANT MATERIAL SHALL HAVE A ONE YEAR GUARANTEE COMMENCING UPON PLANTING.
- 8. PLANTS TO MEET AMERICAN STANDARD FOR NURSERY STOCK (ANSI Z60.1-2014 OR MOST CURRENT VERSION) REQUIREMENTS FOR SIZE AND TYPE SPECIFIED.
- 9. PRUNE PLANTS AS NECESSARY- PER STANDARD NURSERY PRACTICE AND TO CORRECT POOR BRANCHING OF EXISTING AND PROPOSED TREES.
- 10. TOPSOIL SHALL BE PROVIDED AND GRADED BY THE GENERAL CONTRACTOR UP TO 6 INCHES BELOW FINISHED GRADE IN TURF AREAS AND 18 INCHES IN PLANTING AREAS.
- 11. PLANTING AREA TOPSOIL SHALL BE AMENDED WITH 25% SPHAGNUM PEATMOSS, 5% HUMUS AND 70% PULVERIZED SOIL FOR ALL NON TURF SEED MIX AREAS, SHRUB, ORNAMENTAL GRASS, PERENNIAL AND ANNUAL BEDS.
- 12. SEED/SOD LIMIT LINES ARE APPROXIMATE. CONTRACTOR SHALL SEED/SOD ALL AREAS WHICH ARE DISTURBED BY GRADING WITH THE SPECIFIED SEED/SOD MIXES.
- 13. EDGING TO BE A SPADED EDGE UNLESS INDICATED OTHERWISE ON THE PLANS. SPADED EDGE TO PROVIDE V-SHAPED DEPTH AND WIDTH TO CREATE SEPARATION BETWEEN MULCH AND GRASS. A SPADED BED EDGE SHALL SEPARATE MULCH BEDS FROM TURF OR SEEDED AREAS. A SPADED EDGE IS NOT REQUIRED ALONG CURBED EDGES.
- 14. CONTRACTOR SHALL INSTALL SHREDDED HARDWOOD MULCH AT A 3" DEPTH TO ALL TREES, SHRUB, PERENNIAL, AND GROUNDCOVER AREAS. TREES PLACED IN AREA COVERED BY TURF SHALL RECEIVE A 4 FT WIDE MAXIMUM TREE RING WITH 3" DEPTH SHREDDED HARDWOOD MULCH.
- 15. INSTALLATION OF TREES WITHIN PARKWAYS SHALL BE COORDINATED IN THE FIELD WITH LOCATIONS OF UNDERGROUND UTILITIES. TREES SHALL NOT BE LOCATED CLOSER THAN 5' FROM UNDERGROUND UTILITY LINES AND NO CLOSER THAN 10' FROM UTILITY STRUCTURES.
- 16. DO NOT DISTURB THE EXISTING PAVING, LIGHTING, OR LANDSCAPING THAT EXISTS ADJACENT TO
- THE SITE UNLESS OTHERWISE NOTED ON PLAN.

  17. ALL DISTURBED AREAS TO BE SODDED OR SEEDED, UNLESS OTHERWISE NOTED. SOD/SEED
- SHALL BE LOCAL HARDY TURF GRASS MIX UNLESS, OTHERWISE NOTED.
- 18. PLANT QUANTITIES SHOWN ARE FOR THE CONVENIENCE OF THE OWNER AND JURISDICTIONAL REVIEW AGENCIES. THE CONTRACTOR IS RESPONSIBLE FOR VERIFYING ALL PLANT QUANTITIES AS DRAWN.

PLAN VIEW

NITS

SCAL SCAL DESIGNATION OF SIGNATURES OF SIGNA

ANDSCAPE NOTES AND

NE 88TH STREET &
ORTH OAK TRAFFICWA
APARTMENTS


ORIGINAL ISSUE: 02.14.2022 KHA PROJECT NO. 268131000

SHEET NUMBER

L3



**MATERIAL KEY** 

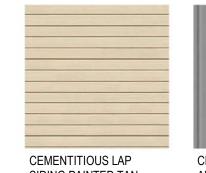





CEMENTITIOUS LAP SIDING PAINTED TAN

MANUFACTURED STONE VENEER

# **KEY NOTES**

- ALUMINUM STOREFRONT WINDOWS PAINTED BLACK
- CEMENTITIOUS ROOF AND BALCONY FASCIAS
- MECHANICAL EQUIPMENT LOCATED AT GRADE

3 NORTH
1/8" = 1'-0"



2 EAST (FRONT)
1/8" = 1'-0"



1 WEST (BACK)
1/8" = 1'-0"

PDP RE-SUBMITTAL

**88TH** 

DRAWING RELEASE LOG • 02.14.22 - PDP SUBMITTAL

△REVISIONS:

03/04/2022 JOB NO. 709022 DRAWN BY: BHALL

SHEET NO. **A**1

FROM 88TH AND N. OAK LOOKING SOUTH



FROM PARKING LOOKING SOUTHEAST

CITY, MO OA AND **88TH** 

**88TH** 

DRAWING RELEASE LOG

• 02.14.22 - PDP SUBMITTAL

 $\triangle$ REVISIONS:

ARCHITECTS PA 3515 W. 75TH ST., SUITE 201 PRAIRIE VILLAGE, KS 66208

PDP RE-SUBMITTAL

JOB NO. 709022 DRAWN BY: Author SHEET NO.

DATE:

03/04/2022

FROM STREET LOOKING NORTH WEST



**BUILDING ENTRY** 



DRAWING RELEASE LOG

• 02.14.22 - PDP SUBMITTAL

 $\triangle$ REVISIONS:

DATE:

JOB NO.
709022
DRAWN BY:
Author
SHEET NO.

03/04/2022

**ARCI** 3515 W. 7


SITE LIGHT FIXTURE SCHEDULE												
MARK MANUFACTURE MOREL NUMBER		ı	MOUNTING		FINICII	LAMPS				DEMANDIC		
MARK MANUFACTURE MODEL NUMBER	RECESS	SURFACE	WALL	LINISH	LED	FLOUR.	HID	CODE	QUANTITY	REMARKS		
.1 MCG	GRAW EDISON	GWC-AF-02-LED-E1-T4FT-1200			X	BLACK	X			13,709LUM/129W	1	1, 2
2 MCG	GRAW EDISON	GWC-AF-02-LED-E1-SL2-1200			X	BLACK	X			13,350LUM/129W	1	1, 2
	.1 MCG	MANUFACTURE  1 MCGRAW EDISON 2 MCGRAW EDISON	MANUFACTURE MODEL NUMBER  1 MCGRAW EDISON GWC-AF-02-LED-E1-T4FT-1200	MANUFACTURE MODEL NUMBER  RECESS  MCGRAW EDISON GWC-AF-02-LED-E1-T4FT-1200	MANUFACTURE MODEL NUMBER  MOUNTING RECESS SURFACE  1 MCGRAW EDISON GWC-AF-02-LED-E1-T4FT-1200	MANUFACTURE MODEL NUMBER  MOUNTING  RECESS SURFACE WALL  MCGRAW EDISON GWC-AF-02-LED-E1-T4FT-1200 X	MANUFACTURE MODEL NUMBER MOUNTING RECESS SURFACE WALL  1 MCGRAW EDISON GWC-AF-02-LED-E1-T4FT-1200 X BLACK	MANUFACTURE MODEL NUMBER    MOUNTING   FINISH   LED	MANUFACTURE MODEL NUMBER  MODEL NUMBER  MOUNTING  RECESS SURFACE WALL  LED FLOUR.  X BLACK X	MANUFACTURE MODEL NUMBER  MODEL NUMBER  MOUNTING  RECESS SURFACE WALL  LED FLOUR. HID  ARK MANUFACTURE  RECESS SURFACE X BLACK X	MANUFACTURE MODEL NUMBER MODEL NUMBER MOUNTING RECESS SURFACE WALL FINISH LED FLOUR. HID CODE  1 MCGRAW EDISON GWC-AF-02-LED-E1-T4FT-1200 X BLACK X BLACK X 13,709LUM/129W	MANUFACTURE MODEL NUMBER MODEL NUMBER FINISH FINISH LED FLOUR. HID CODE QUANTITY  1 MCGRAW EDISON GWC-AF-02-LED-E1-T4FT-1200 X BLACK X BLACK X 13,709LUM/129W 1


## **REMARKS:**

1 WALL MOUNTED 18' AFF.

2 4000 K

STATISTICS								
Description	Avg	Max	Min	Max/Min	Avg/M			
PROPERTY LINE	0.0 FC	0.1 FC	0.0 FC	N/A	N/A			
PARKING LOT	1.4 FC	5.7FC	0.1 fc	57.0:1	14.0:1			

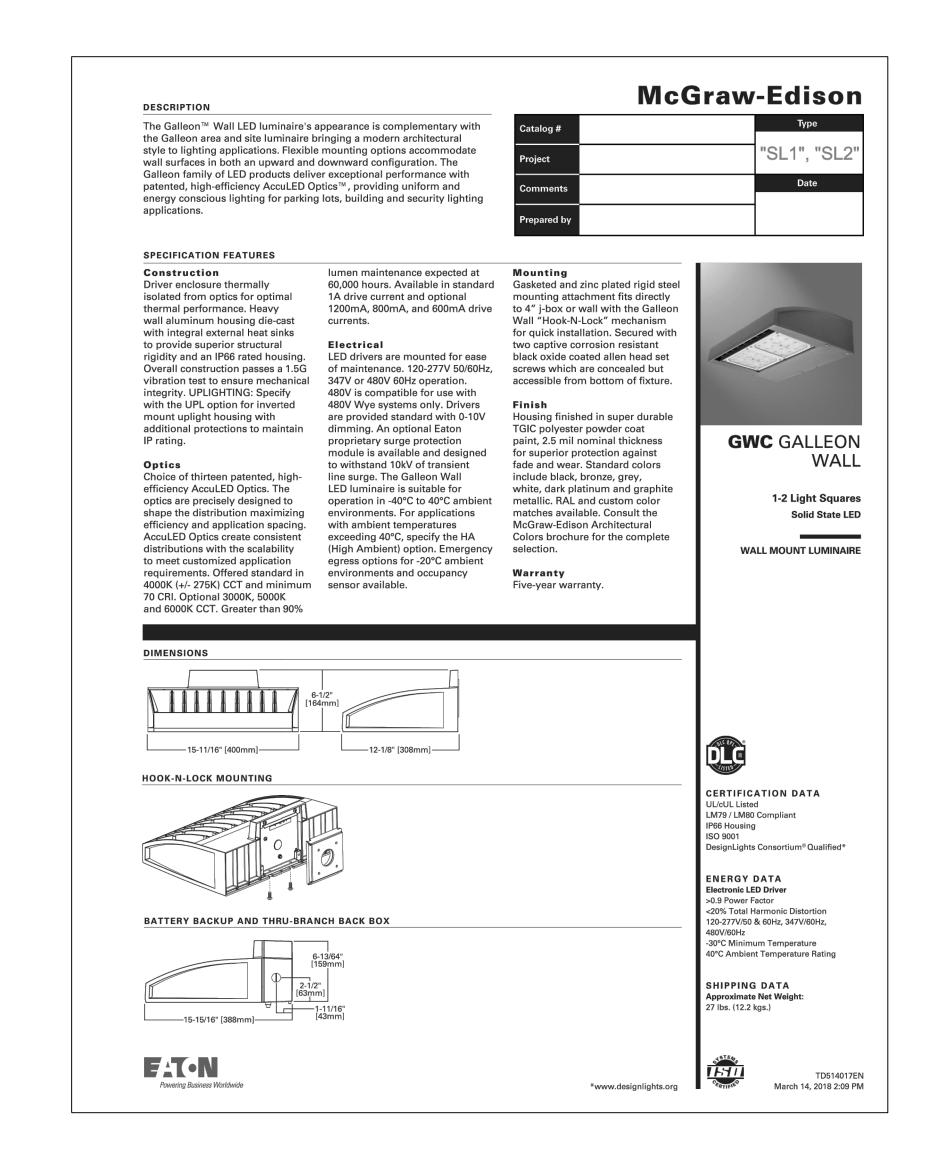

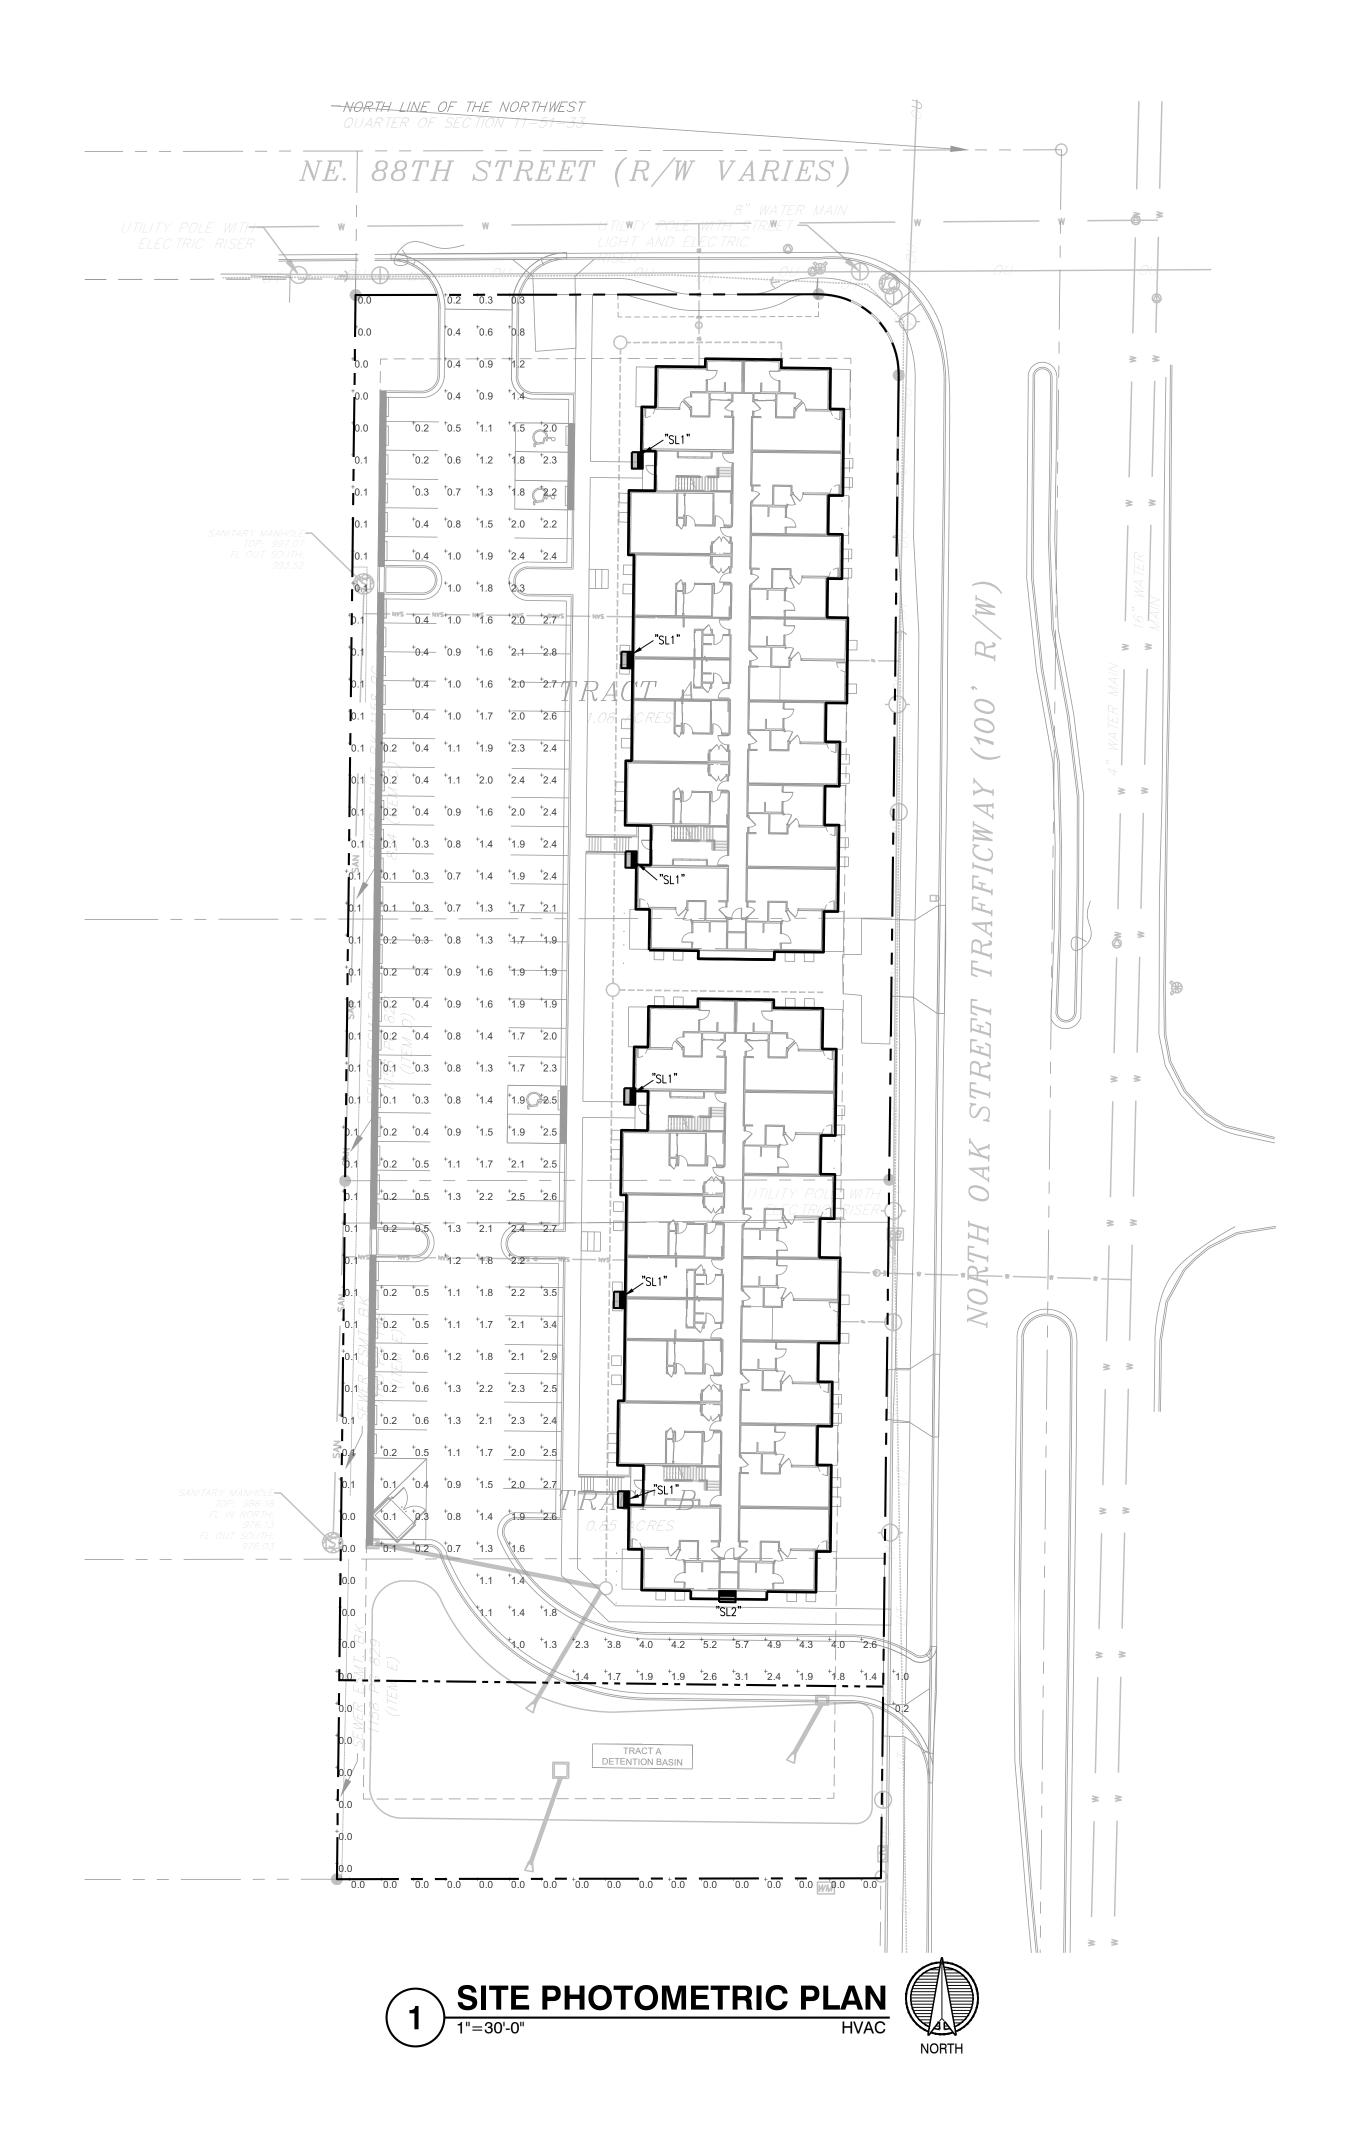









88th DRAWING RELEASE LOG

City

**REVISIONS:** 

DATE: 02-14-2022 JOB NO. 709022 DRAWN BY: CAD/KRW SHEET NO.