

### **HALO Kansas City Program Description and Daily Operations**

HALO Kansas City will operate two different programs on site, comprising of two residential HALO Homes, and one HALO Learning Center. HALO Headquarters office will also be on site, within the same building as the HALO Learning Center.

**HALO Homes:** The HALO Homes are residential transitional living programs that help youth get out of crisis mode, set long-term goals and learn how to live independently in a safe environment. The HALO Home provides a safe haven and foundation of hope for homeless and at-risk youth ages 16-21 years old and their dependents, if applicable. The HALO Home Program is a 16-24 month program. Youth who have graduated from high school must either obtain full-time employment or start higher education classes.

While in the program, youth are provided with a support system to help them set and achieve their future goals, overseen by a Youth Advocate.


Youth participate in life-skill workshops, which are aimed at teaching them how to live independently and gain knowledge and experience in the areas of Daily Living, Self-Care, Relationships & Communication, Housing & Money Management and Career & Education. HALO will have 2 HALO Homes on site, one for males and one for females. Homes will be staffed 24/7, 365 days a year.

**HALO Learning Center:** The HALO Learning Center is a safe-haven of healing and hope for homeless and at-risk youth in Kansas City. HALO puts at-risk kids on a path to a positive future. Through therapeutic art programs, tutoring, professional development, scholarships and help preparing for higher education, our kids work hard to leave the "at-risk" label behind and finally be seen as a great kid with the potential to do great things. Programs are offered year-round, multiple times a week, with a future focused curriculum to equip our youth with life skills to promote healing and help them to learn independently in a safe environment. The end goal of youth attending all HALO programs is to become a contributing member of their community.

# HALO VILLAGE - KANSAS CITY MASTER PLANNED DEVELOPMENT

## KANSAS CITY, MISSOURI 64129

5928 E. 52ND TERRACE

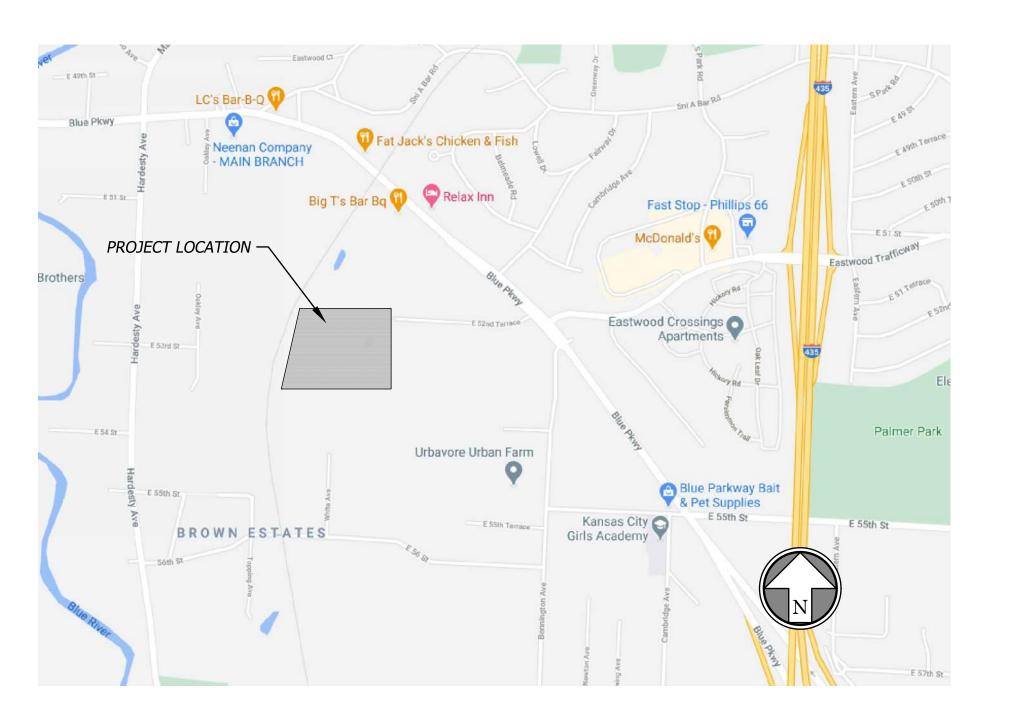

SW 1/4

**SECTION MAP** 

SCALE: 1" = 2000'

SECTION 36-T49N-R33W

JACKSON COUNTY, MISSOURI

## **LEGAL DESCRIPTION**

5926-28 E 52ND TER PRT W 1/2 NW 1/4 SEC 36 49 33 BEG 1723.92 FT S & 1316.04 FT E OF NW COR SD 1/2 1/4 TH N 898.92 FT TH W 785.05 FT TH N TO SELY R/W OF KC & GRANDVIEW RR TH SWLY ALG SD R/W TO A PT 180 FT E OF W LI SD 1/2 1/4 THS 180 FT E & PARL WITH SD W LITO A PT 1723.92 FT S OF N LI SD 1/2 1/4 TH E TO BEG

## **CIVIL ENGINEER**

7101 COLLEGE BOULEVARD, SUITE 400 OVERLAND PARK, KANSAS 66210 P (913) 663-1900 F (913) 663-1633 CONTACT: MATT GIBBS P.E.

MATT.GIBBS@IBHC.COM

## **OWNER/DEVELOPER**

HALO FOUNDATION 1600 GENESSEE STREET #200 KANSAS CITY, MO 64102 PH: (816) 472-4256 CONTACT: REBECCA WELSH REBECCA@HALOWORLDWIDE.ORG

## **APPROVED BY:**

Date

Administrator, Engineering Services Division


**SUBMITTED BY:** 

OVERLAND PARK, KANSAS

Matthew Gibbs, P.E. Date Missouri P.E. No. 202004655

All existing utility locations shown are approximate only and are not guaranteed to be accurate or all inclusive. Contractor shall be responsible for contacting all utility companies and verifying the actual field locations of all utilities prior to any construction activity. Contractor shall keep all utility locations current. Utilities damaged through the negligence of the contractor to obtain the proper field locations shall be the responsibility of the contractor to repair or replace at their expense and at the direction of the utility company. The contractor shall pothole and survey all utility crossings prior to construction of any portion of storm sewer, sanitary sewer laterals, underdrains, conduit and any other subsurface element of the project. The survey information shall be forwarded to the project engineer for review. The contractor shall not begin construction on any subsurface element on the project without the approval of the project engineer. Utility coordination, potholing/surveying shall be subsidiary to other bid items.




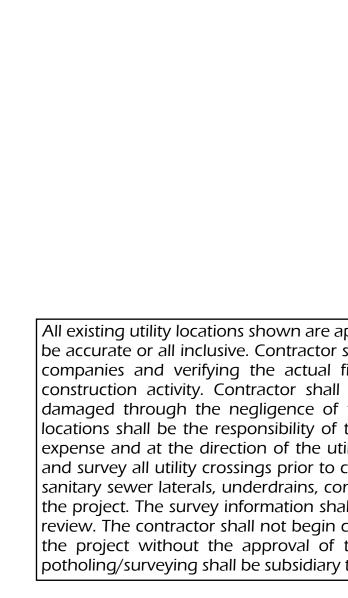






ssue Date: 04/23/202

- Drawn: MG

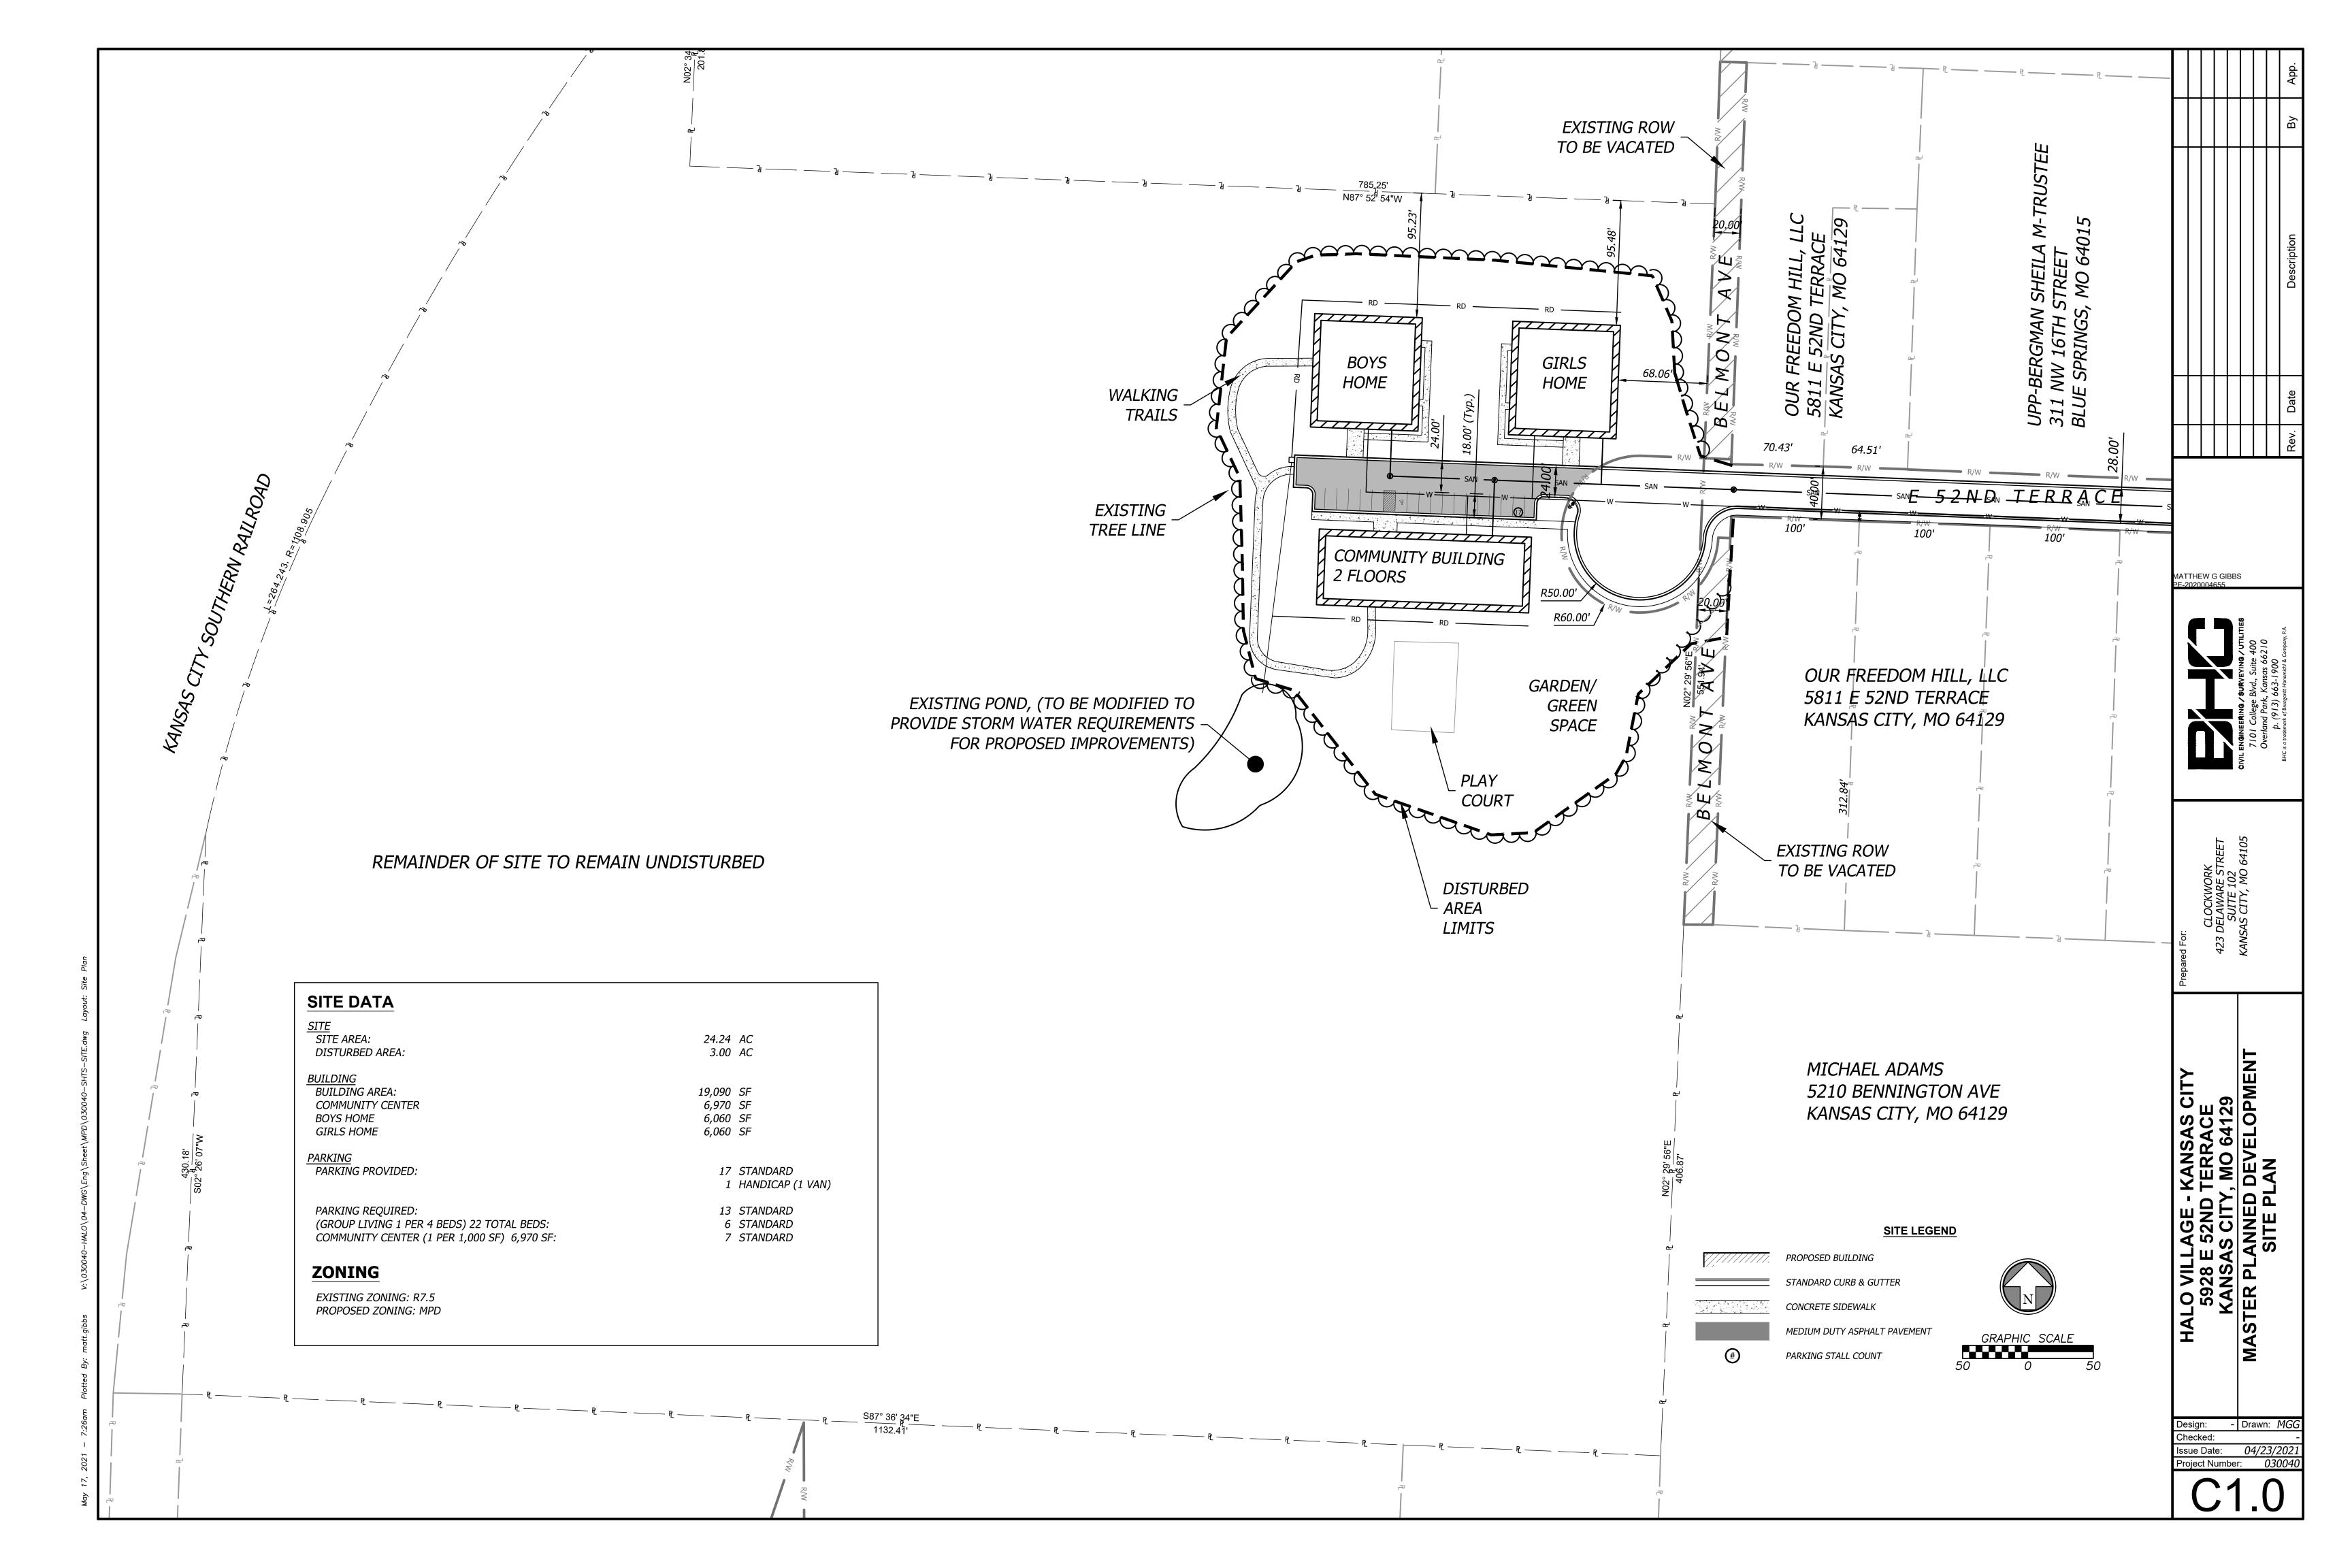

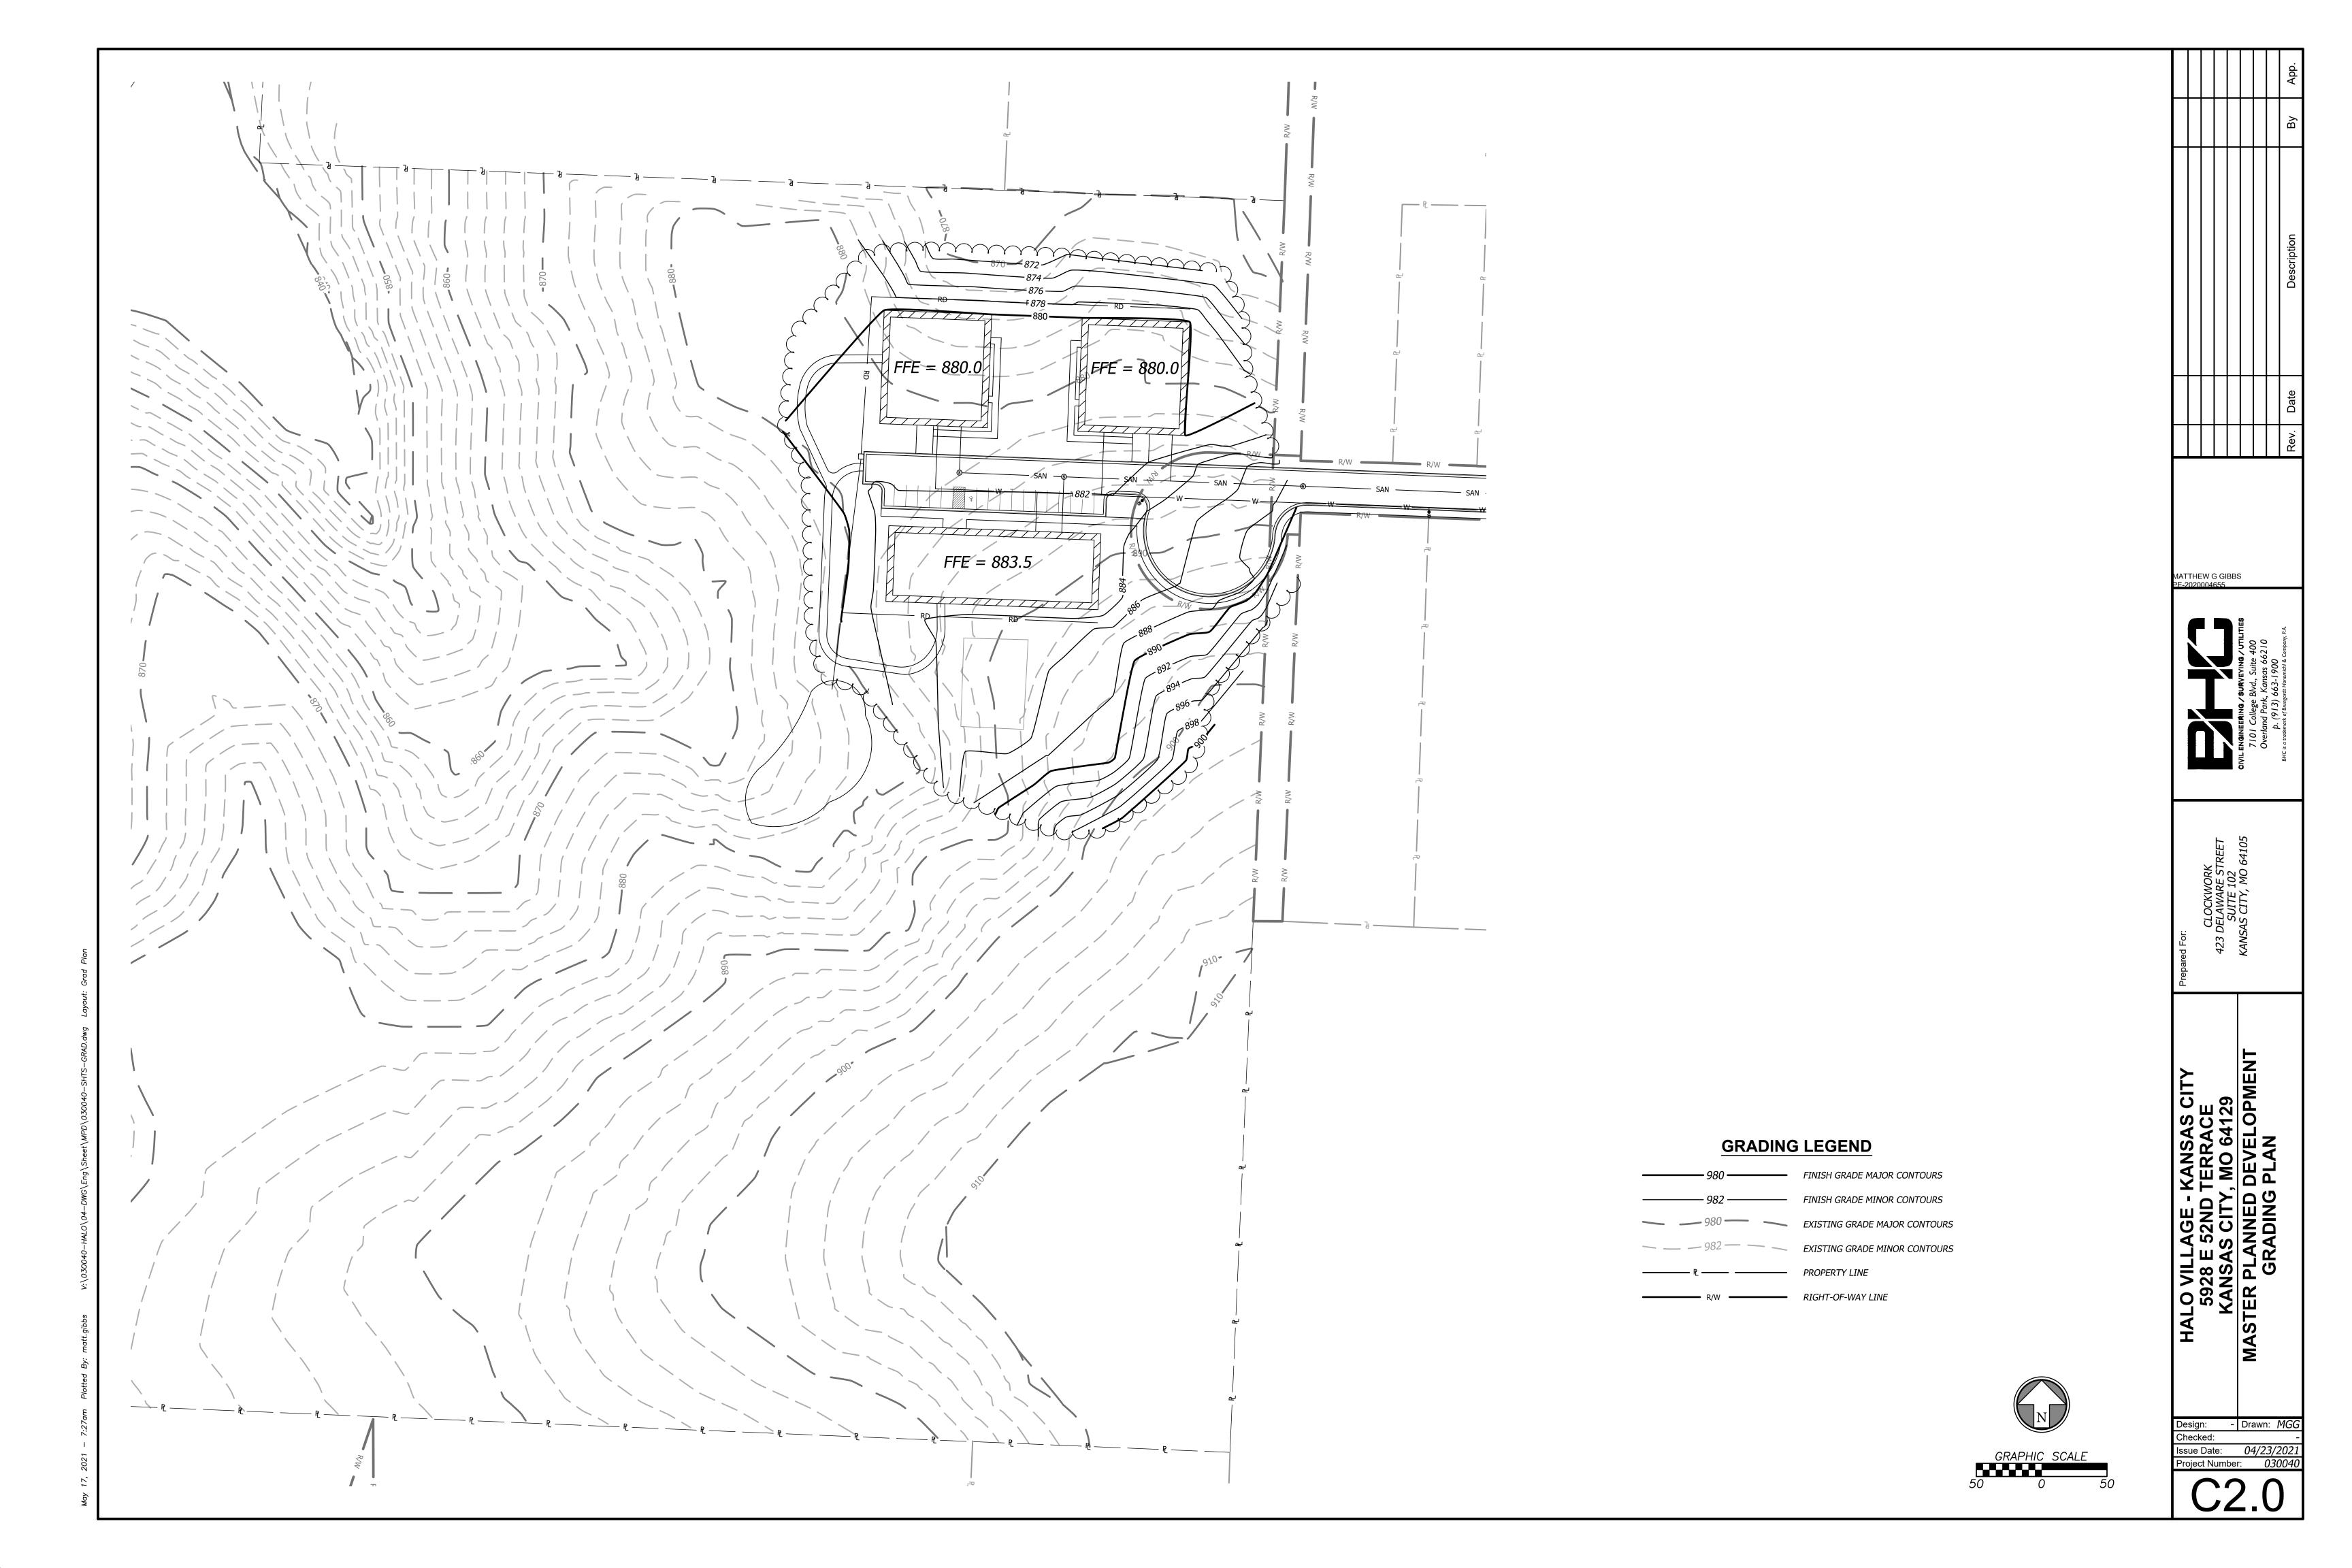

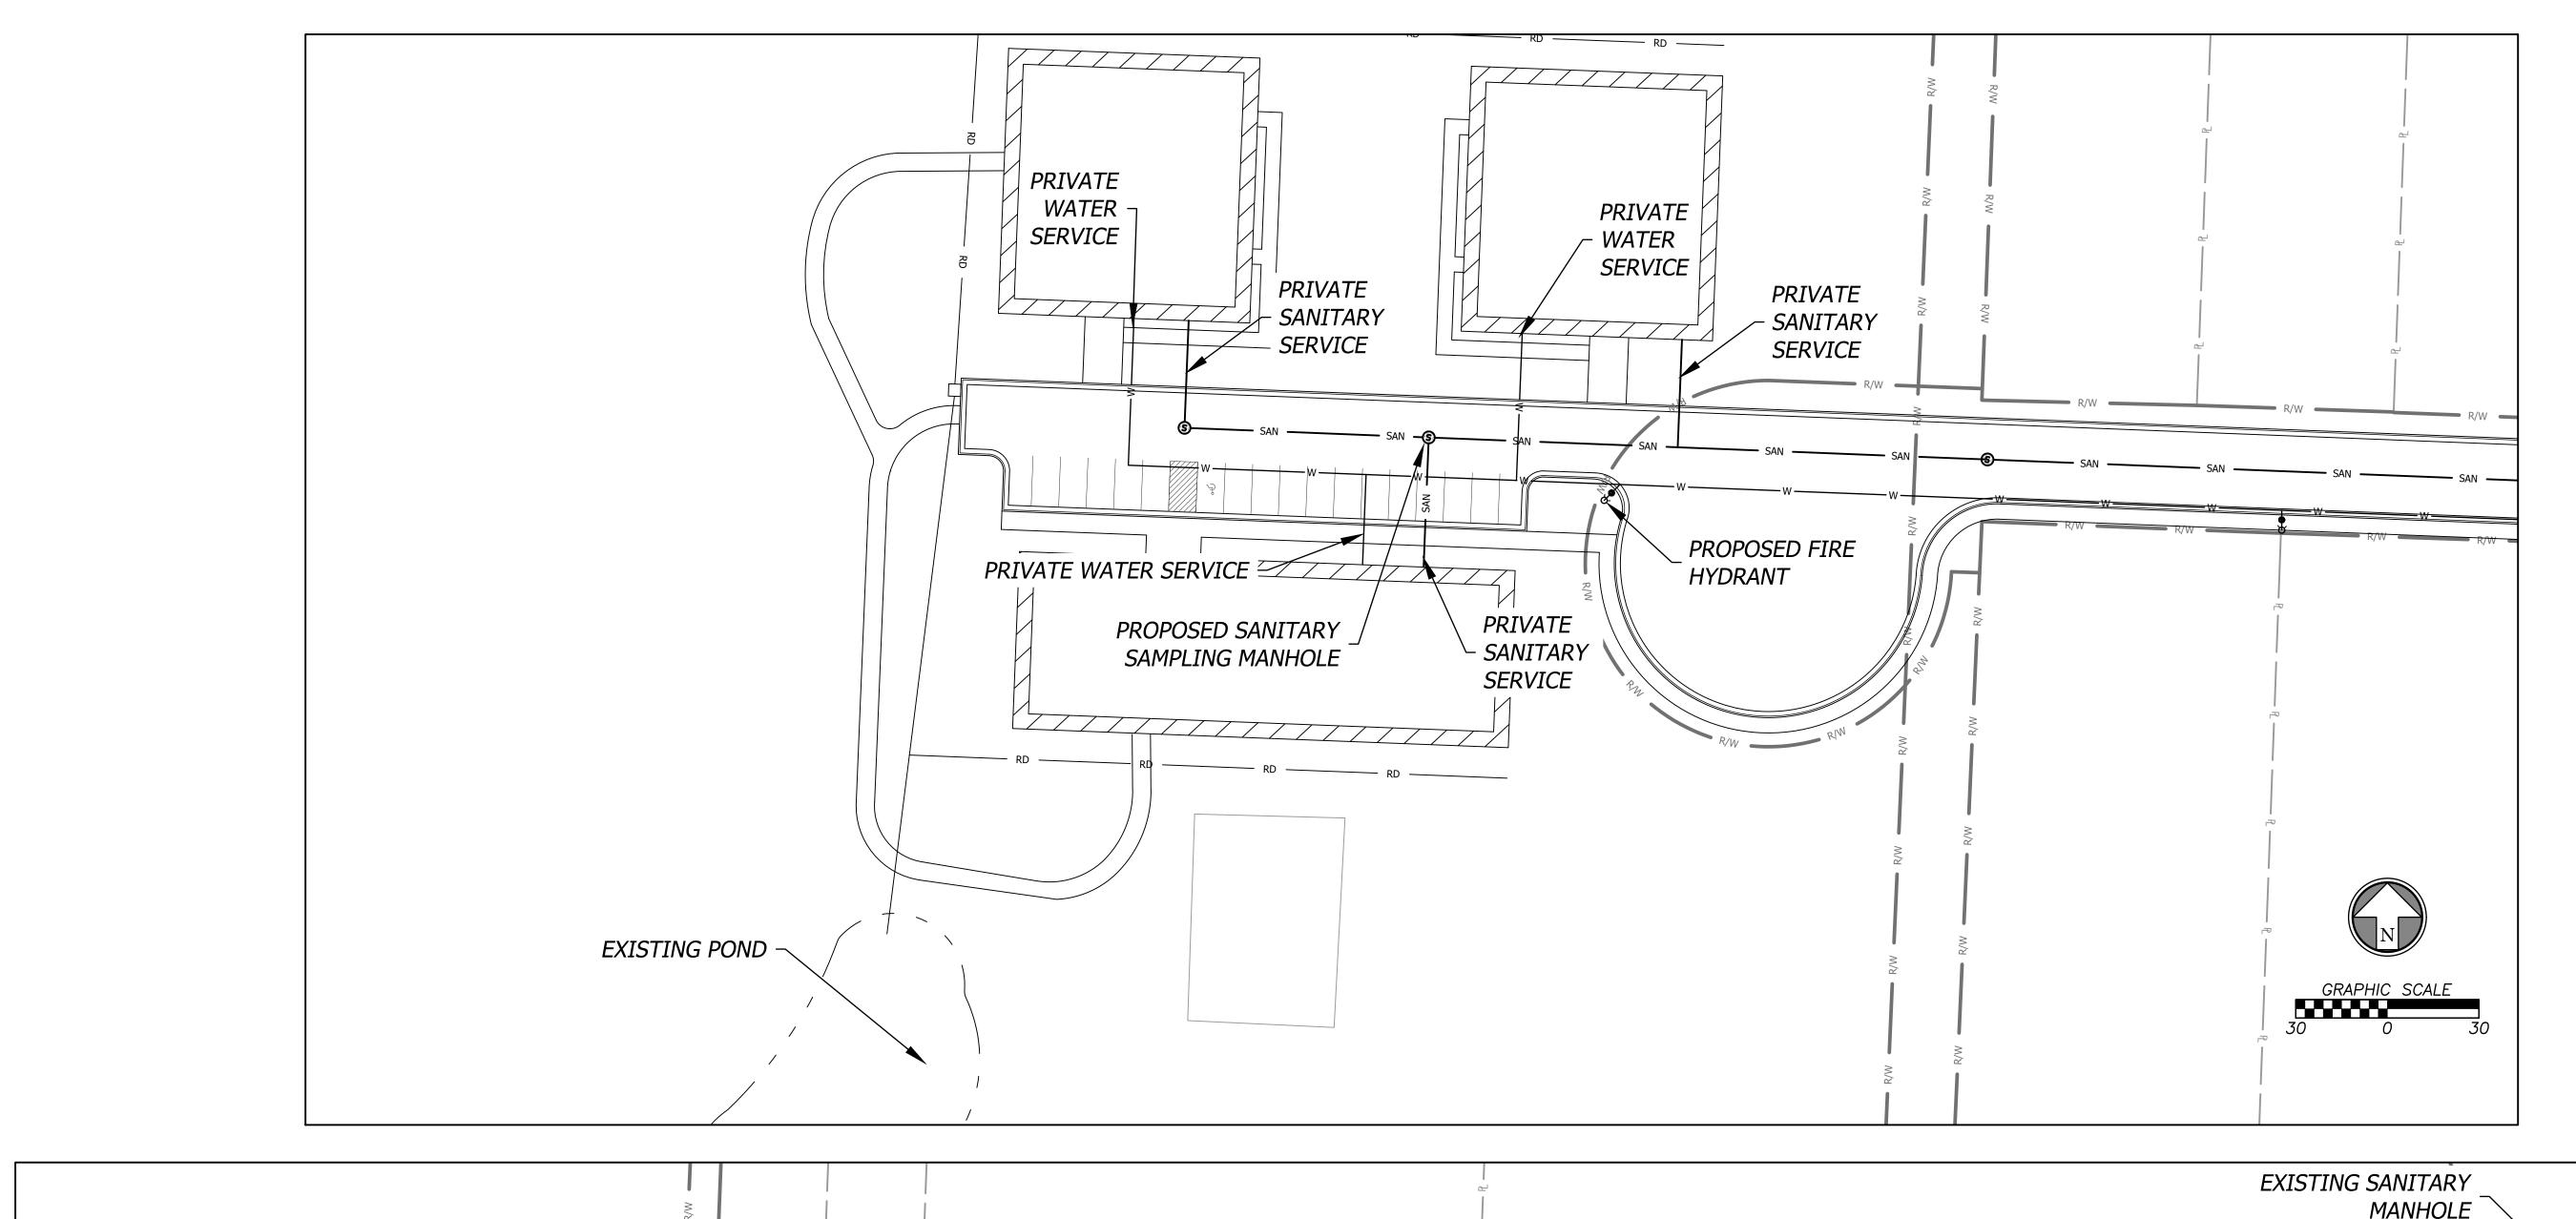

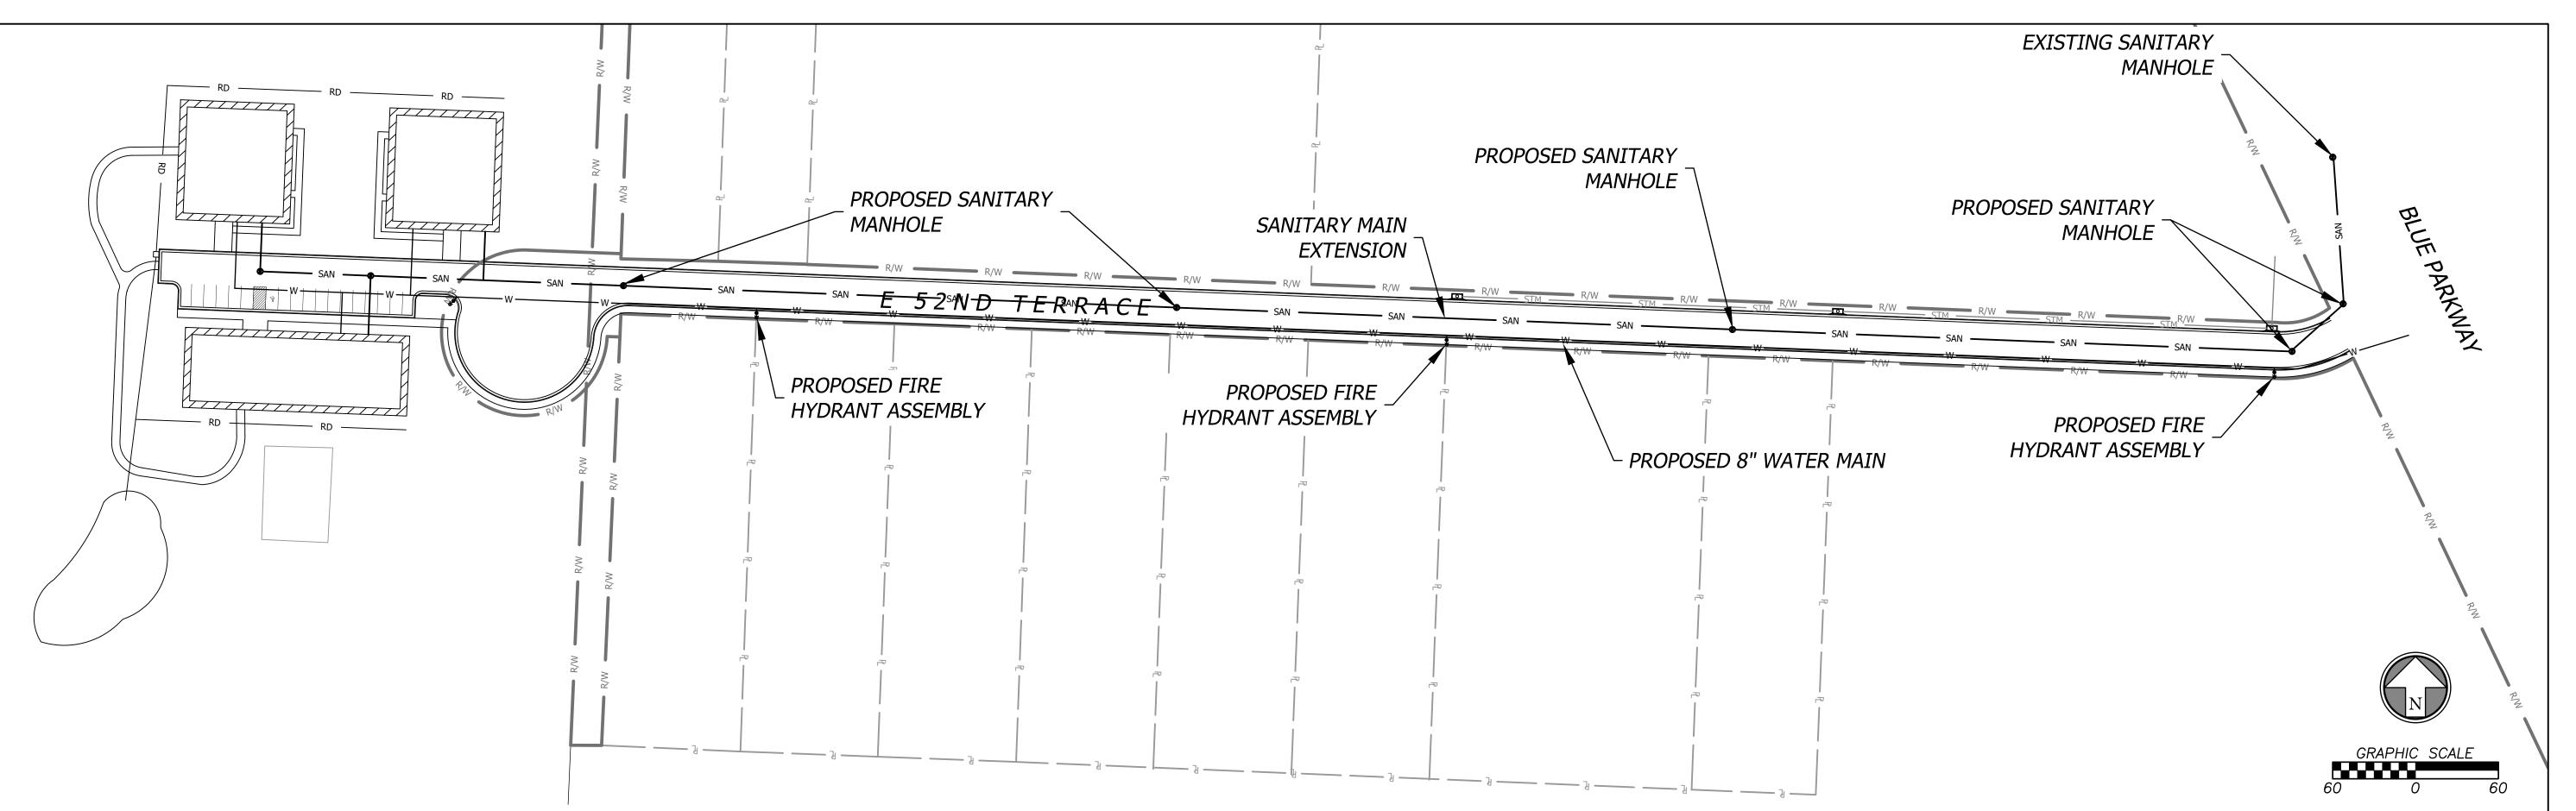

Sea Bab Signal Search Strain By App.

MATTHEW G GIBBS PF-2020004655

CIVIL ENGINEERING / SURVEYING / UTILITIES
7101 College Blvd., Suite 400
Overland Park, Kansas 66210
p. (913) 663-1900

CLOCKWORK 423 DELAWARE STREET SUITE 102 KANSAS CITY, MO 64105

O VILLAGE - KANSAS CITY 5928 E 52ND TERRACE ANSAS CITY, MO 64129 ER PLANNED DEVELOPMENT

Design: - Drawn: MGG
Checked: Issue Date: 04/23/2021
Project Number: 030040

C3.0



### **GENERAL LANDSCAPE NOTES**

- 1. The Contractor shall verify and coordinate all final grades with the Landscape Architect and or design team prior to completion.
- 2. Location and placement of all plant material shall be coordinated with the Landscape Architect prior to installation.
- 3. Location of all utilities are approximate, the Contractor shall field verify locations prior to commencement of construction operations.
- Refer to Civil Drawings for all grading and berming, erosion control, storm drainage, utilities and site layout.
- 5. The Contractor shall arrange and conduct a pre-construction meeting onsite with Landscape Architect prior to work.
- 6. Plant quantities are for information only, drawing shall prevail if conflict occurs. Contractor is responsible for calculating own quantities and bid accordingly.
- 7. The Contractor is to notify Landscape Architect after staking is complete and before plant pits are excavated.
- 8. Tree locations in areas adjacent to drives, walks, walls and light fixtures may be field adjusted as approved by Landscape Architect.
- 9. The Contractor shall report subsurface soil or drainage problems to the Landscape Architect.

30% of site (AC)

- 10. The plan is subject to changes based on plant size and material availability. All changes or substitutions must be approved by the City of Fairway, Kansas and the Landscape Architect.
- 11. Aluminum landscape edging to be used on all landscape beds adjoining turf areas as noted on landscape plans.
- 12. Landscape Contractor shall be responsible for watering all plant material until the time that a permanent water source is ready.
- 13. The Contractor shall show proof of procurement, sources, quantities, and varieties for all shrubs, perennials, ornamental grasses, and annuals within 21 days following the award of the contract.
- 14. Contractor shall provide full maintenance for newly landscaped areas for a period of 30 days after the date of final acceptance. At the end of the maintenance period, a healthy, well-rooted, even-colored, viable turf and landscaped area must be established. The landscaped areas shall be free of weeds, open joints, bare areas, and surface irregularities.
- 15. Landscape Contractor shall provide rock mulch sample to owner for approval.

Description	
Rev. Date	
Rev.	

ATTHEW G GIBBS



## **LEGEND**

Quantity Required Provided

3.96

0.90

1.92

PROPOSED FINISH GRADE MAJOR CONTOUR PROPOSED FINISH GRADE MINOR CONTOUR EXISTING GRADE MAJOR CONTOUR EXISTING GRADE MINOR CONTOUR PROPOSED STORM SEWER LINE PROPOSED ROOF LINE DRAIN RIGHT-OF-WAY LINE

> - Drawn: *NA* Issue Date: 04/23/202 Project Number: 03004





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## GENERAL NOTES-EXTERIOR MATERIALS

1. STONE VENEER TO BE SIMILAR TO AS MFR BY CORONADO STONE
A. MIX OF 70% SPLIT FIELDSTONE & 30% EASTERN MOUNTAIN LEDGE LOMPAC

2. FIBER CEMENT SIDING SIMILAR TO AS MFR BY JAMES HARDIE
A. COLOR TO BE SIMILAR TO PEARL GRAY
B. COLOR TO BE SIMILAR TO RICH ESPRESSO


3. ALUMINUM STOREFRONT AND OPERABLE WINDOWS TO BE DARK BRONZE /
BLACK FINISH
 4. STANDING SEAM METAL ROOF SIMILAR TO AS MFR BY BERRIDGE

A. COLOR TO BE PARCHMENT

B. GUTTERS, DOWNSPOUNTS, AND FLASHING TO MATCH.



4 | Elevation - HALO Center - West

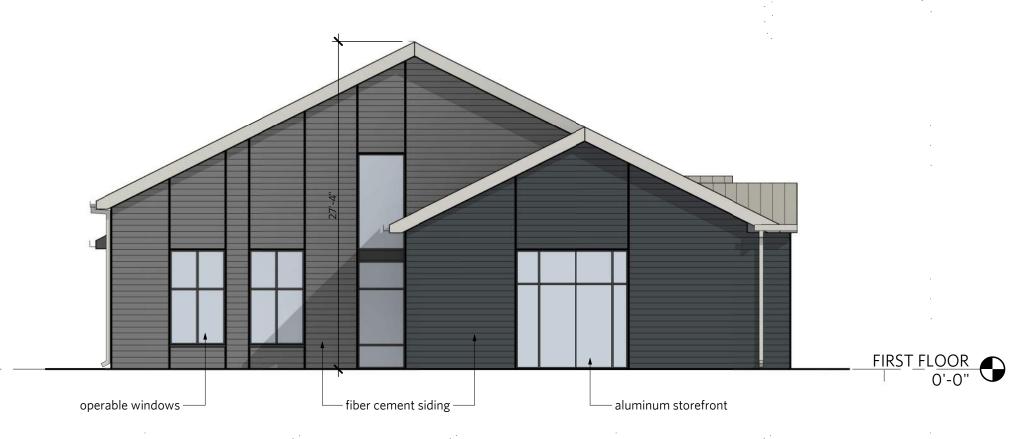

3 | Elevation - HALO Center - East



aluminum storefront halo logo stone veneer cement board siding commodular motal roof

1 | Elevation - HALO Center - Front

NOTE: trees shown as artistic representation. actual landscaping per landscaping plans

2 | Elevation - HALO Center - South

EXTERIOR ELEVATIONS - HALO

A200

CENTER

HALO VILLAGE

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REV ISSUE DATE

2018 03 01

REV ISSUE A CD

1. STONE VENEER TO BE SIMILAR TO AS MFR BY CORONADO STONE
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LOMPAC

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A. COLOR TO BE PARCHMENT
B. GUTTERS, DOWNSPOUNTS, AND FLASHING TO MATCH.

stone veneer —

— operable windows

4 | Elevation - HALO Housing - East 1/8" = 1'-0"

fiber cement siding —



3 | Elevation - HALO Housing - West



2 | Elevation - HALO Housing - North




1 | Elevation - HALO Housing - Front | 1/8" = 1'-0"

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EXTERIOR ELEVATIONS - HALO HOUSING







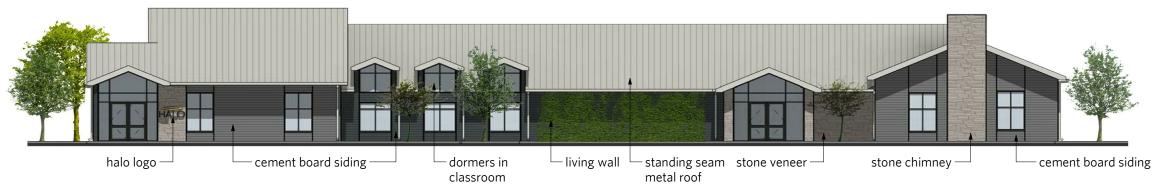





A2.3